


CONSTRUCTION AND EROSION CONTROL PLANS

FOR

SCULAC ROAD STREAM RESTORATION

BETHLEHEM TOWNSHIP NORTHAMPTON COUNTY PENNSYLVANIA

FEBRUARY 2025 REVISED OCTOBER 2025

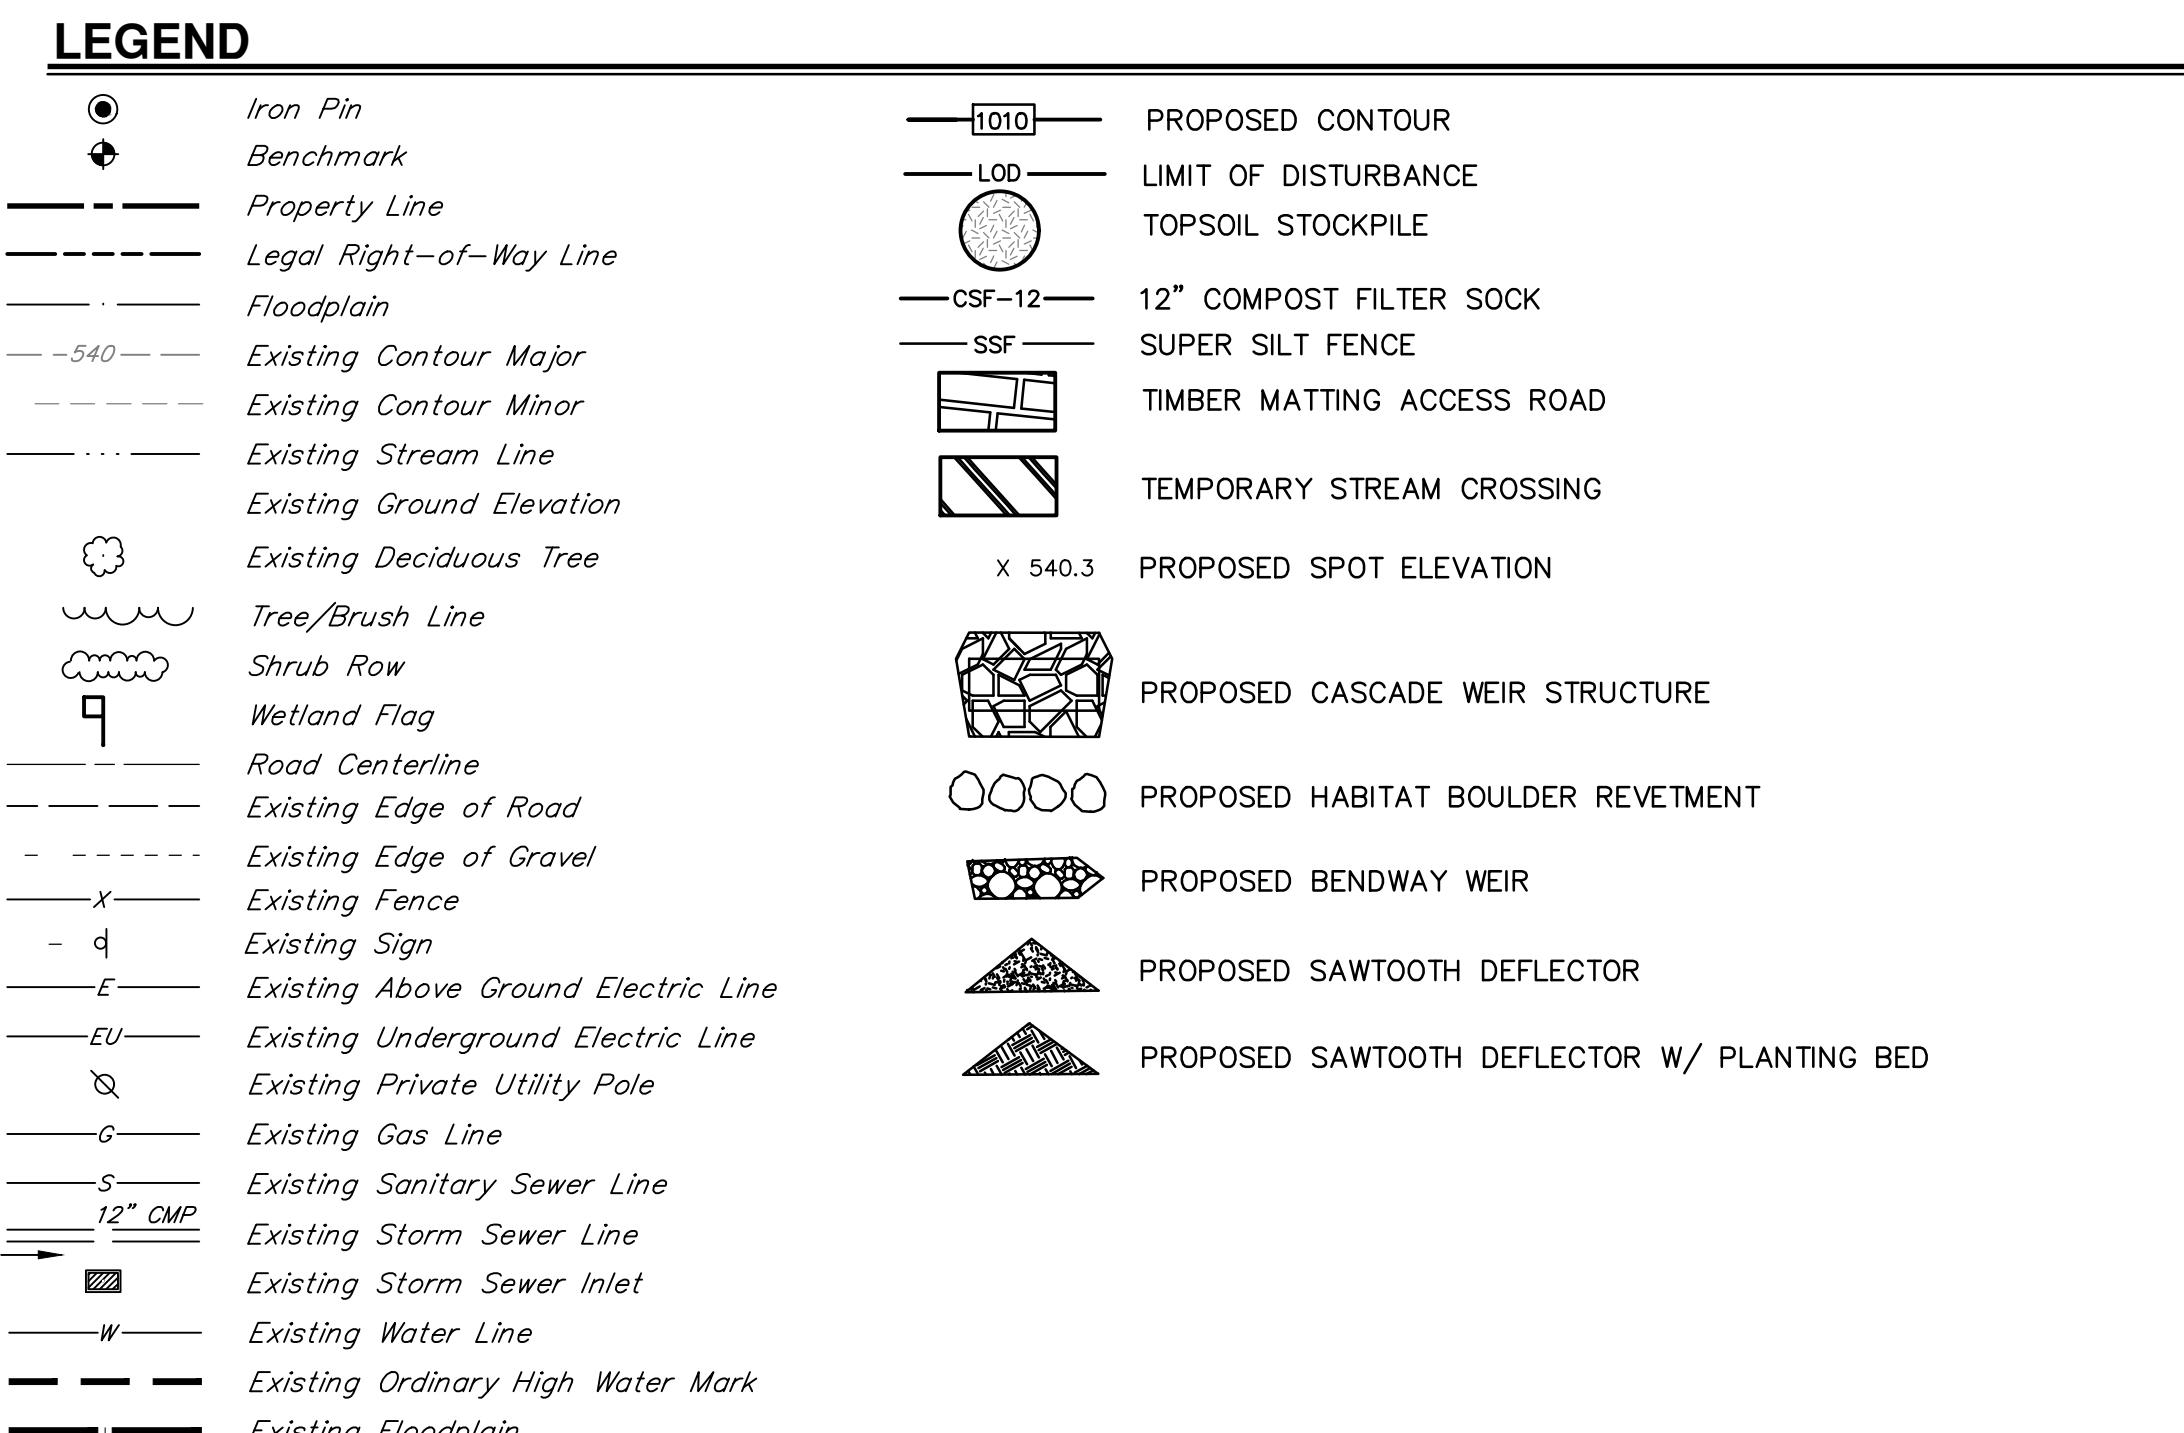

DEMOLITION NOTES

- ALL DEMOLITION SHALL BE CONDUCTED IN ACCORDANCE WITH ALL LOCAL, STATE AND FEDERAL REGULATIONS.
- ALL DEMOLITION MATERIAL SHALL BE DISPOSED OF IN A LEGAL MANNER.
- ITEMS TO REMAIN SHALL BE PROTECTED DURING DEMOLITION AND CONSTRUCTION ACTIVITIES. IF ANY ITEM TO REMAIN IS DAMAGED OR MADE INOPERABLE FOR ITS INTENDED FUNCTION, IT SHALL BE REPAIRED OR REPLACED TO A CONDITION EQUAL TO OR BETTER THAN ITS CONDITION WHEN DAMAGED AT CONTRACTOR'S EXPENSE.

TRAFFIC CONTROL NOTES

- THE CONTRACTOR WILL FURNISH, ERECT, PLACE AND MAINTAIN TRAFFIC CONTROL SIGNS AND DEVICES AND MAINTAIN TRAFFIC DURING HOURS OF CONSTRUCTION AND AT ALL OTHER TIMES IN ACCORDANCE WITH THE METHODS BELOW:
 - 67 PA CODE, CHAPTER 212, OFFICIAL TRAFFIC CONTROL DEVICES
 - PENNDOT PUBLICATION NO. 213
 - PENNDOT PUBLICATION NO. 35, APPROVED CONSTRUCTION MATERIALS (BULLETIN 15)
 - PENNDOT PUBLICATION NO. 408, SPECIFICATIONS, CURRENT EDITION

GENERAL UTILITY NOTES

- THE CONTRACTOR MUST CONTACT THE PENNSYLVANIA ONE-CALL NUMBER THREE WORKING DAYS PRIOR TO THE START OF WORK TO HAVE ALL UTILITIES MARKED IN THE WORK AREA. THE CONTRACTOR SHALL ALSO COMPLY WITH ALL APPLICABLE REGULATIONS OF ACT 199 NOTIFICATION OF UTILITIES PRIOR TO CONSTRUCTION.
- EXISTING UTILITIES ARE SHOWN IN ACCORDANCE WITH THE BEST INFORMATION AVAILABLE AND ARE FOR THE CONVENIENCE OF THE CONTRACTOR ONLY. AS SUCH, THESE LOCATIONS MUST BE CONSIDERED APPROXIMATE ONLY, AND MUST BE FIELD VERIFIED PRIOR TO ANY CONSTRUCTION ACTIVITIES FOR THE PROJECT. HRG, INC. PROVIDES A CERTIFICATE OF APPROXIMATE INFORMATION CONCERNING THE LOCATION, ABSENCE, OR PRESENCE OF ANY UNDERGROUND UTILITY. IT SHALL BE THE CONTRACTOR'S RESPONSIBILITY TO VERIFY THE EXACT LOCATION AND DEPTH OF ALL UTILITY LINES OR OTHER CONFLICTS (WHETHER OR NOT SHOWN ON THE PLAN) PRIOR TO THE START OF ANY CONSTRUCTION ACTIVITIES, BY DIGGING TEST PITS (AT CONTRACTOR'S EXPENSE) WELL IN ADVANCE OF CONSTRUCTION. LOCATION OF UTILITIES ARE NOT AS SHOWN ON THE PLAN, CONTACT THE ENGINEER BEFORE PROCEEDING WITH CONSTRUCTION.

WORK RESTRICTION NOTES

- NO TREE CLEARING OPERATIONS SHALL BE PERFORMED BETWEEN MAY 15 AND AUGUST 15.

RECEIVING WATERCOURSES

STORMWATER FROM THIS SITE FLOWS TO THE LEHIGH RIVER. THE CHAPTER 93 CLASSIFICATION OF THE LEHIGH RIVER IS WARM WATER FISHES (WWF), MIGRATORY FISHES (MF).

GRADING AND STORMWATER NOTES

- EXISTING CONTOURS ARE SHOWN AT 1' INTERVALS.
- THE CONTRACTOR SHALL ASSURE POSITIVE DRAINAGE AWAY FROM BUILDINGS FOR ALL NATURAL AND PAVED AREAS. ALL AREAS OF THE SITE MUST BE GRADED TO MAINTAIN POSITIVE DRAINAGE TO A DRAINAGE FACILITY. ANY LOCALIZED DEPRESSIONS WITHIN PAVED AREAS MUST BE ELIMINATED.
- THE CONTRACTOR SHALL ADJUST AND/OR CUT EXISTING PAVEMENT AS NECESSARY TO ASSURE A SMOOTH AND CONTINUOUS GRADE TO TIE-IN TO EXISTING GRADE.
- THE CONTRACTOR SHALL ADHERE TO ALL TERMS AND CONDITIONS OF THE PERMITS ISSUED BY THE GOVERNING REGULATORY AGENCY.
- THE CONTRACTOR SHALL APPLY A STABILIZATION MATTING, OR EQUIVALENT, TO ALL SLOPES 3:1 OR STEEPER FOR ANY TEMPORARY OR PERMANENT CUTS OR FILLS.
- CONTRACTOR SHALL BE RESPONSIBLE FOR COORDINATION RESOLUTION OF ALL UTILITY CONFLICTS SHOWN (OR NOT SHOWN) ON PLANS.


ROCK MATERIAL USE NOTES

- USE OF APPROPRIATE ROCK MATERIAL THROUGHOUT THE PROJECT AREA IS CRITICAL TO SUCCESSFUL RECOLONIZATION OF MACROINVERTEBRATES AND OTHER AQUATIC SPECIES. ACCORDINGLY, THE CONTRACTOR IS DIRECTED TO USE VARIOUS ROCK MATERIALS REQUIRED IN THE SUBJECT WORK ONLY IN ACCORDANCE WITH THE FOLLOWING:
 - NATIVE STREAMBED MATERIAL
 - THE CONTRACTOR SHALL RE-USE NATIVE STREAMBED MATERIAL THROUGHOUT THE PROJECT TO THE GREATEST EXTENT FEASIBLE. WHEN THE ELEVATION OF THE STREAM BED IS TO BE RAISED, THE CONTRACTOR SHALL REMOVE AND STOCKPILE THE NATIVE STREAMBED MATERIAL. THE STREAMBED MATERIAL SHALL BE RE-USED. THE STREAMBED MATERIAL STREAM SUBGRADE MATERIAL SHALL BE A MIXTURE OF ROCK, SILT AND SAND, AND NATIVE SOIL MATERIALS BLENDED AND PLACED TO APPROXIMATE THE MAKEUP OF THE EXISTING STREAM SUBGRADE.
 - LIMESTONE QUARRY ROCK
 - THE PROJECT AREA IS LOCATED WITHIN THE EPLER AND ONTLAUNEE FORMATION WHICH IS PRIMARILY MADE OF LIMESTONE AND DOLOMITE ROCK. AS SUCH, LIMESTONE QUARRY ROCK MAY BE USED AS FOLLOWS:
 1. LARGE BLOCKY LIMESTONE QUARRY ROCK MAY BE USED TO CONSTRUCT IN-STREAM STRUCTURES.
 2. MID-SIZED ANGULAR LIMESTONE QUARRY ROCK MAY BE USED AS THE RIP-RAP TOE IN BANK STABILIZATION METHODS AND FOR THE PREFORMED SCOUR HOLES.
 3. LIMESTONE GRAVEL MATERIAL MAY BE USED AS STREAMBED MATERIAL OR INCORPORATED INTO THE STREAMBED SUBGRADE.

SURVEY NOTES

- SUBJECT PROPERTY LINES DEPICTED ON THIS PLAN HAVE BEEN ESTABLISHED BASED UPON DEED PLOTTING AND GIS PARCEL INFORMATION AND NOT A RESULT FROM A FIELD RUN BOUNDARY SURVEY.
- THIS SURVEY HORIZONTALLY REFERENCES NORTH AMERICAN DATUM OF 1983 (NAD83) PA STATE PLANE, NORTH ZONE, DERIVED OR DETERMINED THROUGH GNSS, CONVENTIONAL METHODS BASED UPON POSITIONAL INFORMATION REFERENCED THROUGH THE FOLLOWING PUBLISHED HORIZONTAL CONTROL MONUMENTS, CORS OR KEYNET/GPS GNSS VRS NETWORK.
- THE VERTICAL DATUM IS BASED ON NAVD88, DERIVED OR DETERMINED THROUGH GNSS, CONVENTIONAL METHODS BASED UPON POSITIONAL INFORMATION REFERENCED THROUGH THE FOLLOWING PUBLISHED BENCH MARK MONUMENTS, CONTINUOUSLY OPERATING REFERENCE STATIONS (CORS) OR KEYNET/GPS GNSS VRS NETWORK. DATUM REFERENCED PROJECT BENCH MARK LOCATED AT THE INTERSECTION OF HAMPTON ROAD AND WASHINGTON STREET WITH AN ELEVATION OF 339.83.
- TOPOGRAPHIC EXISTING CONDITIONS AND CONTOURS SHOWN ARE DERIVED FROM A FIELD RUN TOPOGRAPHIC SURVEY AND SUPPLEMENTED BY UAV LIDAR ON AUGUST 21, 2024.
- THIS PLAN WAS PREPARED WITHOUT THE BENEFIT OF A TITLE REPORT AND MAY BE SUBJECT TO EASEMENTS AND OTHER RESTRICTIONS, EITHER RECORDED OR UNRECORDED. THE SURVEYOR HAS MADE NO INVESTIGATION OR INDEPENDENT SEARCH FOR EASEMENT OF RECORD, ENCUMBRANCES, RESTRICTIVE COVENANTS, OWNERSHIP TITLE EVIDENCE OR ANY OTHER FACTS THAT AN ACCURATE AND CURRENT TITLE SEARCH MAY DISCLOSE OTHER THAN WHAT IS SHOWN ON THIS PLAN.
- THE LOCATIONS OF UTILITIES AS SHOWN HEREON ARE BASED ON ABOVEGROUND FEATURES, FIELD OBSERVATIONS/SURVEY, AND RECORD DRAWINGS PROVIDED BY UTILITY COMPANIES. LOCATIONS OF UNDERGROUND UTILITIES/STRUCTURES MAY VARY FROM LOCATIONS SHOWN. UNRECORDED, ADDITIONAL UTILITIES/STRUCTURES MAY ALSO BE ENCOUNTERED. NO EXCAVATIONS ARE MADE DURING THE PROGRESS OF THIS SURVEY TO LOCATE BURIED UTILITIES/STRUCTURES. IT SHALL BE THE CONTRACTOR'S RESPONSIBILITY TO FIELD VERIFY THE EXACT LOCATION AND DEPTH OF ALL UTILITY LINES PRIOR TO THE COMMENCEMENT OF ANY CONSTRUCTION ACTIVITIES. THE CONTRACTOR SHALL CONTACT ALL UTILITY COMPANIES IN COMPLIANCE WITH ACT 187 TO VERIFY THE EXACT LOCATION OF ALL UNDERGROUND UTILITIES. A ONE CALL WILL BE PERFORMED PRIOR TO FIELD SURVEYING. SERIAL NO. 20242114315 & 20242114338.

- ALL MATERIALS AND DETAILS SPECIFIED SHALL NOT BE ALTERED DURING CONSTRUCTION WITHOUT WRITTEN APPROVAL BY THE ENGINEER.
- EROSION AND SEDIMENT (E&S) CONTROL PLANS HAVE BEEN PREPARED. CONTRACTOR MUST REFER TO THE OFFICIAL E&S PLANS.
- SHOULD A SINKHOLE(S) OPEN WITHIN THE WORK SITE, IMMEDIATELY DIVERT ALL SURFACE RUNOFF AND CONTACT THE ENGINEER FOR BACKFILLING GUIDANCE.
- ALL MATURE TREES ARE TO BE PROTECTED UNLESS NOTED FOR REMOVAL AND REPLACEMENT. PRIOR TO MOBILIZING EARTHMOVING EQUIPMENT, THE CONTRACTOR SHALL FLAG ALL TREES PLANNED FOR REMOVAL AND CONDUCT AN ON-SITE MEETING WITH THE OWNER AND ENGINEER TO CONFIRM. TO THE EXTENT POSSIBLE, CONTRACTOR SHALL REUSE STUMPS ON-SITE IN THE CONSTRUCTION OF ROOT WAD BANK PROTECTION.
- ALL WORK TO BE COMPLETED WITHIN THE AUTHORITY RIGHT-OF-WAY, AUTHORITY PROPERTY, OR EASEMENTS ACQUIRED.
- THE CONTRACTOR SHALL NOTIFY OWNER AND ENGINEER IMMEDIATELY UPON DISCOVERY OF ANY CONDITIONS THAT ARE NOT CONSISTENT WITH THE CONTENT OF THESE PLANS.

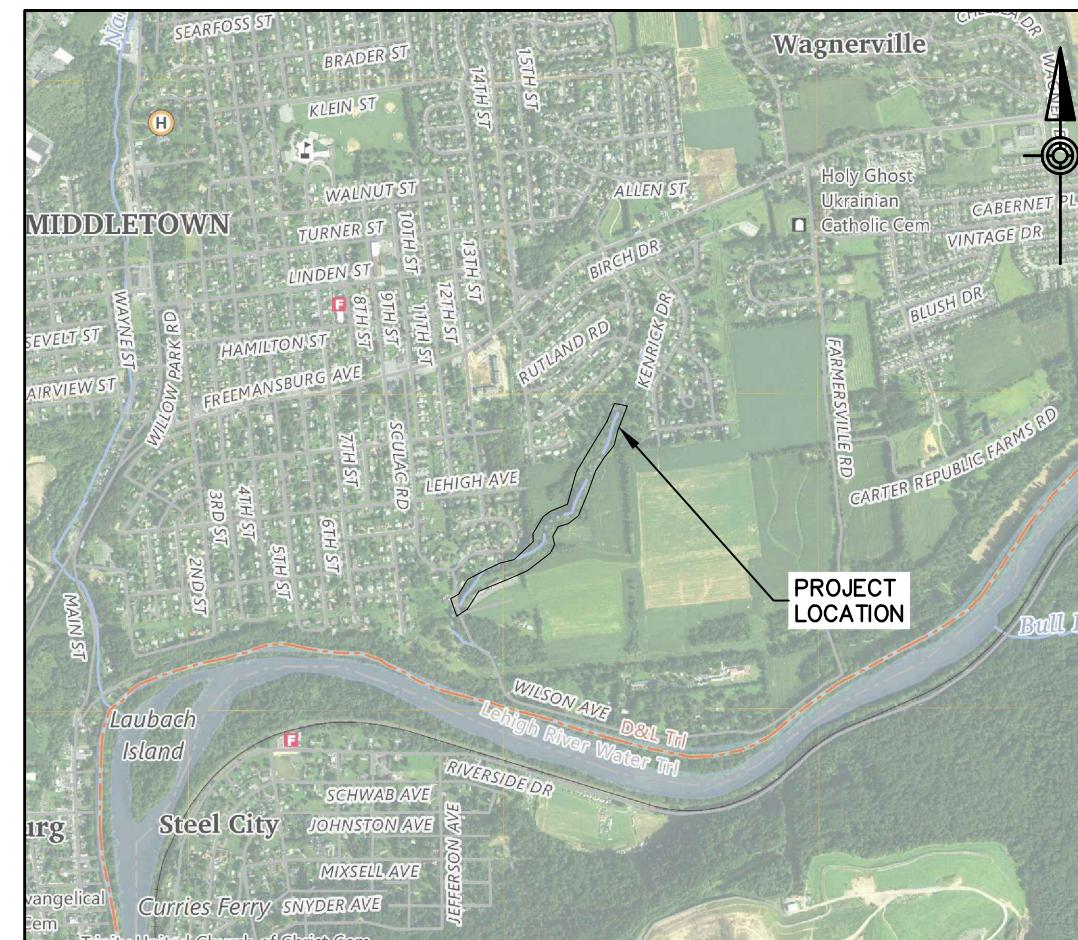

LOCATION MAP

SCALE: 1"=2000'

PA ONE CALL

ACT 287, AS AMENDED



PENNSYLVANIA ACT 287 (1974) AS AMENDED, REQUIRES NOTIFICATION BY EXCAVATORS, DESIGNERS, OR ANY PERSON PREPARING TO DISTURB THE EARTH'S SURFACE ANYWHERE IN THE COMMONWEALTH. PA ONE-CALL SERIAL NO. 20242114315 & 20242114338 HAS BEEN ASSIGNED TO THIS PROJECT ON JULY 30, 2024.

PA ONE CALL-UTILITY LIST

BETHLEHEM TOWNSHIP MUNICIPAL AUTHORITY
 4225 EASTON AVENUE BETHLEHEM, PA 18020
 JOHN BARTHOLOMEW
 JOHN.B@BETHLEHEMTPW.COM
 (610) 814-6400

FIRST ENERGY PENELEC
 21 S. MAIN STREET AKRON, OH, 44308
 MELLYSSA ADAMS
 MELLYSSAADAMS@FIRSTENERGYCORP.COM
 (800) 545-7741

PPG ELECTRIC UTILITIES CORPORATION
 434 SUSQUEHANNA TRAIL NORTHUMBERLAND, PA 17857
 DOUG HAUPT
 DLHAUPT@PPLWEB.COM
 (570) 368-5235


ASTOUND BROADBAND POWERED BY RCN
 5508 NOR BATH BOULEVARD NORTHAMPTON, PA 18067
 ERIC BEERS
 ERIC.BEERS@ASTOUND.COM
 (833) 249-2786

UGI UTILITIES INC.
 2121 CITY LINE ROAD BETHLEHEM, PA 18017
 TIMOTHY STEWARD
 TSTEWARD@UGI.COM
 (800) 276-2722

CITY OF BETHLEHEM
 10 EAST CHURCH STREET BETHLEHEM, PA 18018
 ROBERT TAYLOR
 RTAYLOR@BETHLEHEM-PA.GOV
 (610) 865-7000

VERIZON BUSINESS
 700 WESTON PARKWAY CARY, NC 27513
 VICTOR WOOD
 VICTOR.S.WOOD@VERIZON.COM
 (919) 414-2782

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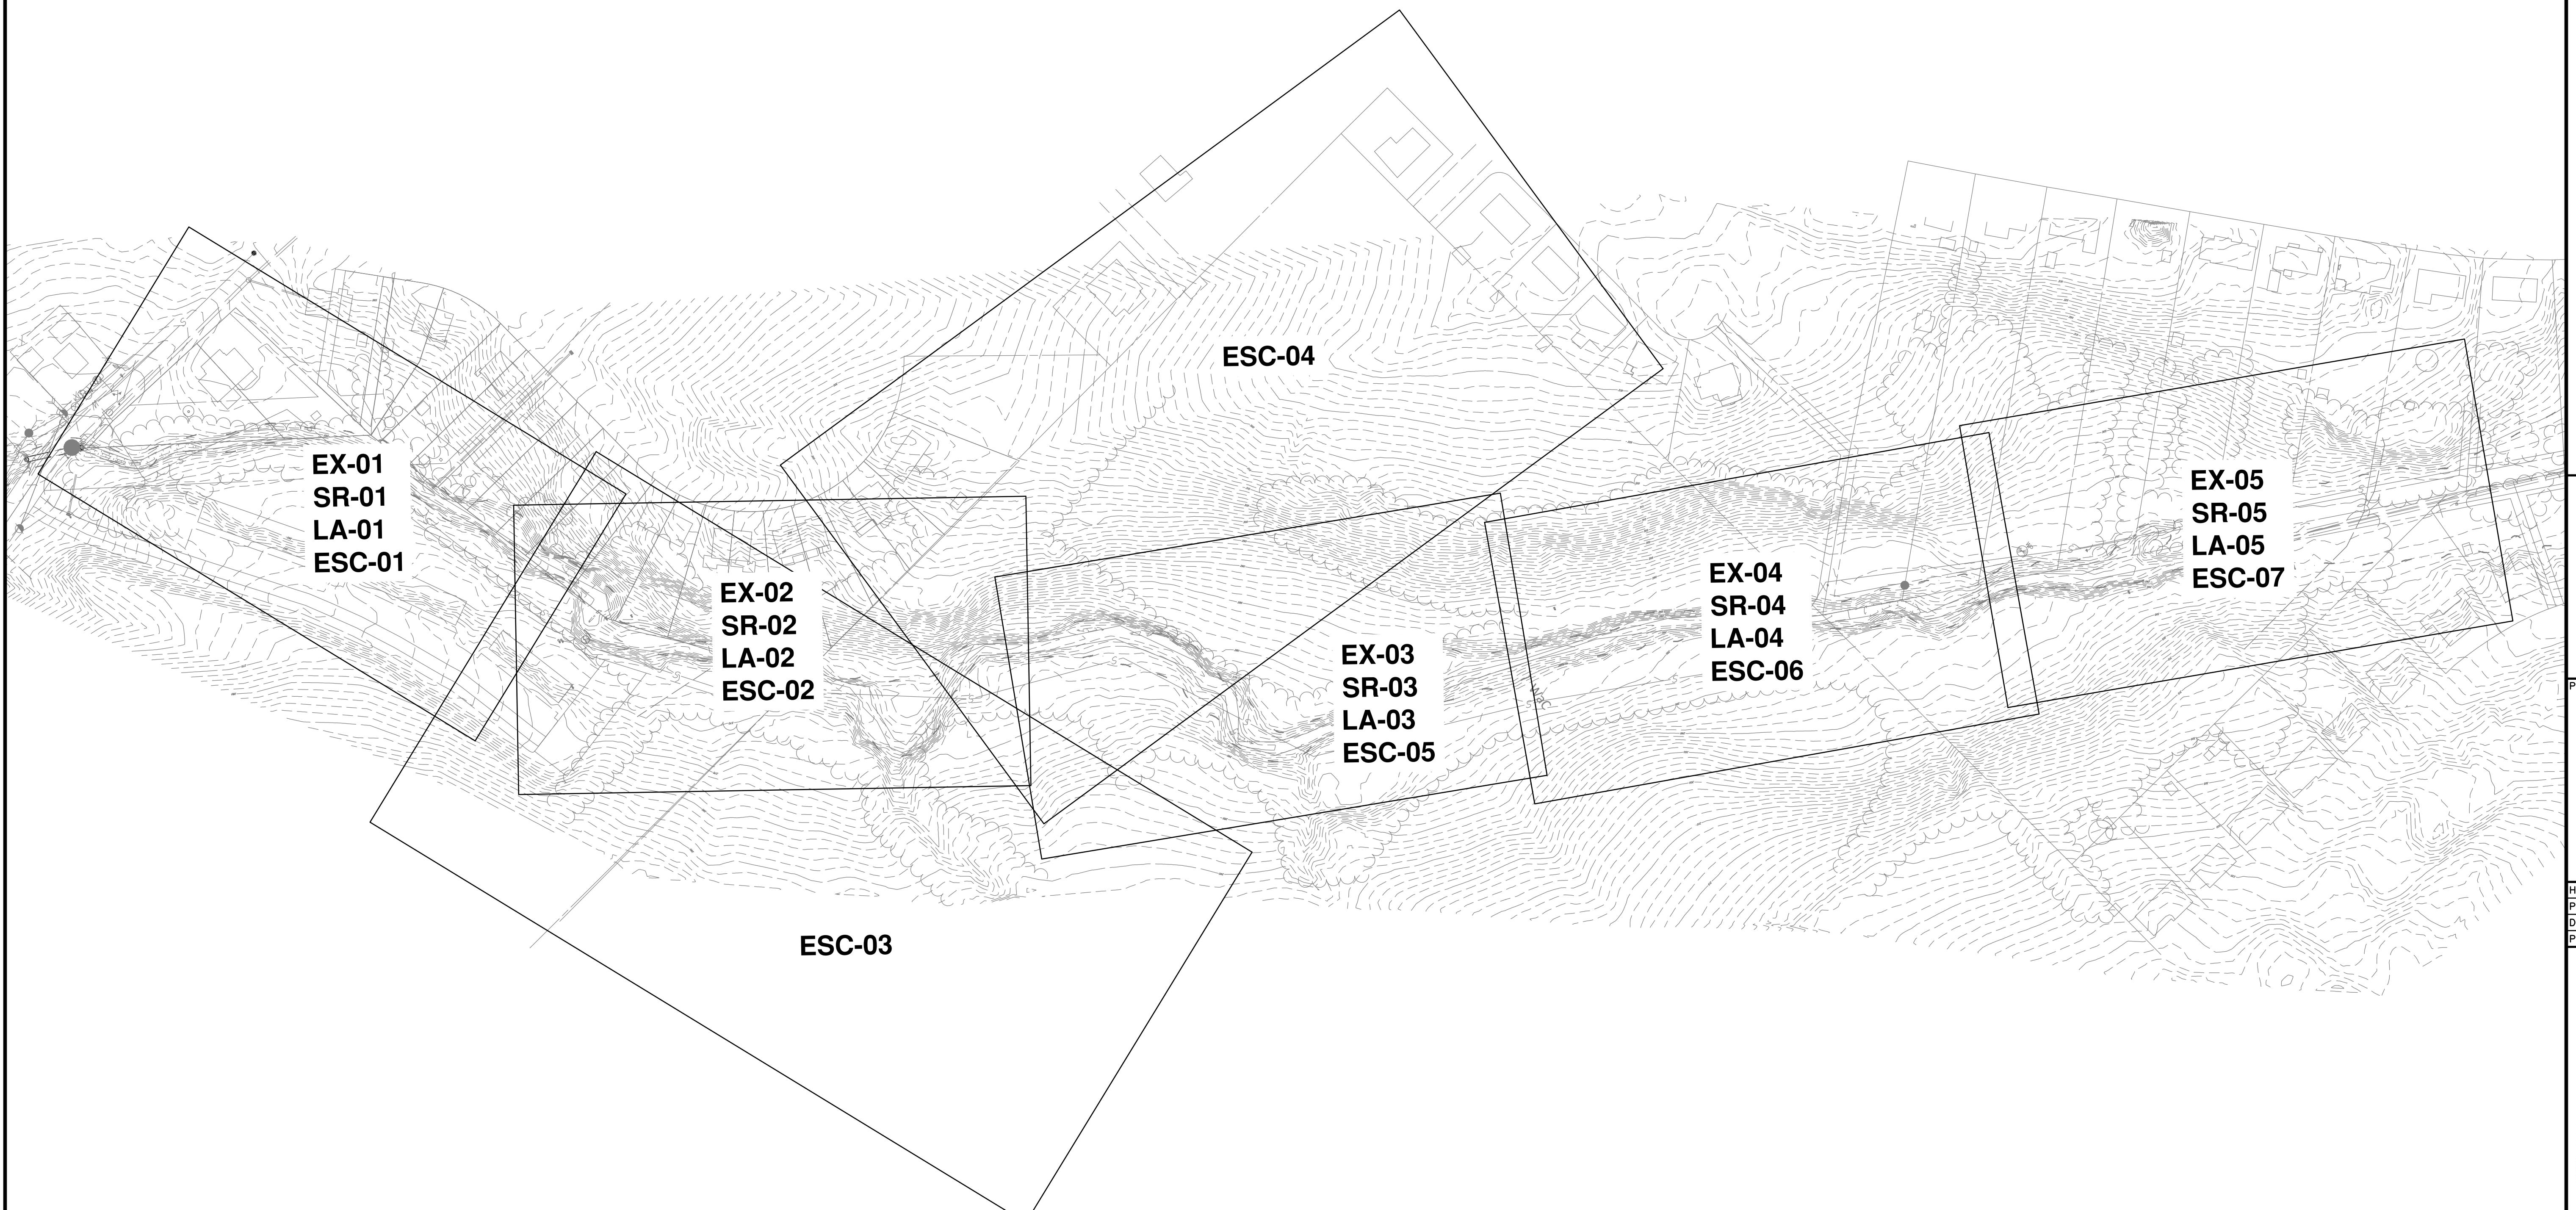
HRG PROJECT NUMBER: R009170.0431
PLAN DATE: FEBRUARY 2025
DRAWING SCALE: AS SHOWN
PROJ. MANAGER: MATTHEW VANASKE

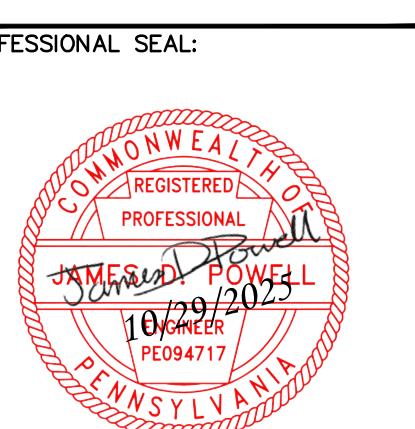NO.	DATE	DESCRIPTION
1	03/05/25	REVISED PER NCCD COMMENTS
2	10/01/25	REVISED PER CONSTRUCTABILITY REVIEW
3		
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INDEX OF SHEETS

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LAST UPDATED: 10/29/2025 11:15 AM BY POWELL

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PAGE: 02




GRAPHIC SCALE
100' 50' 0' 100'
SCALE: 1" = 100'

FILE NAME: IND-01.DWG
PAGE: 02

CONSTRUCTION AND EROSION CONTROL PLANS
FOR
SCULAC ROAD STREAM RESTORATION

BETHLEHEM TOWNSHIP MUNICIPAL AUTHORITY
4225 EASTON AVENUE
BETHLEHEM, PA 18020
NORTHAMPTON COUNTY, PENNSYLVANIA

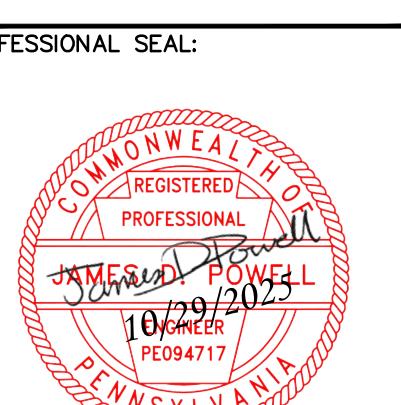

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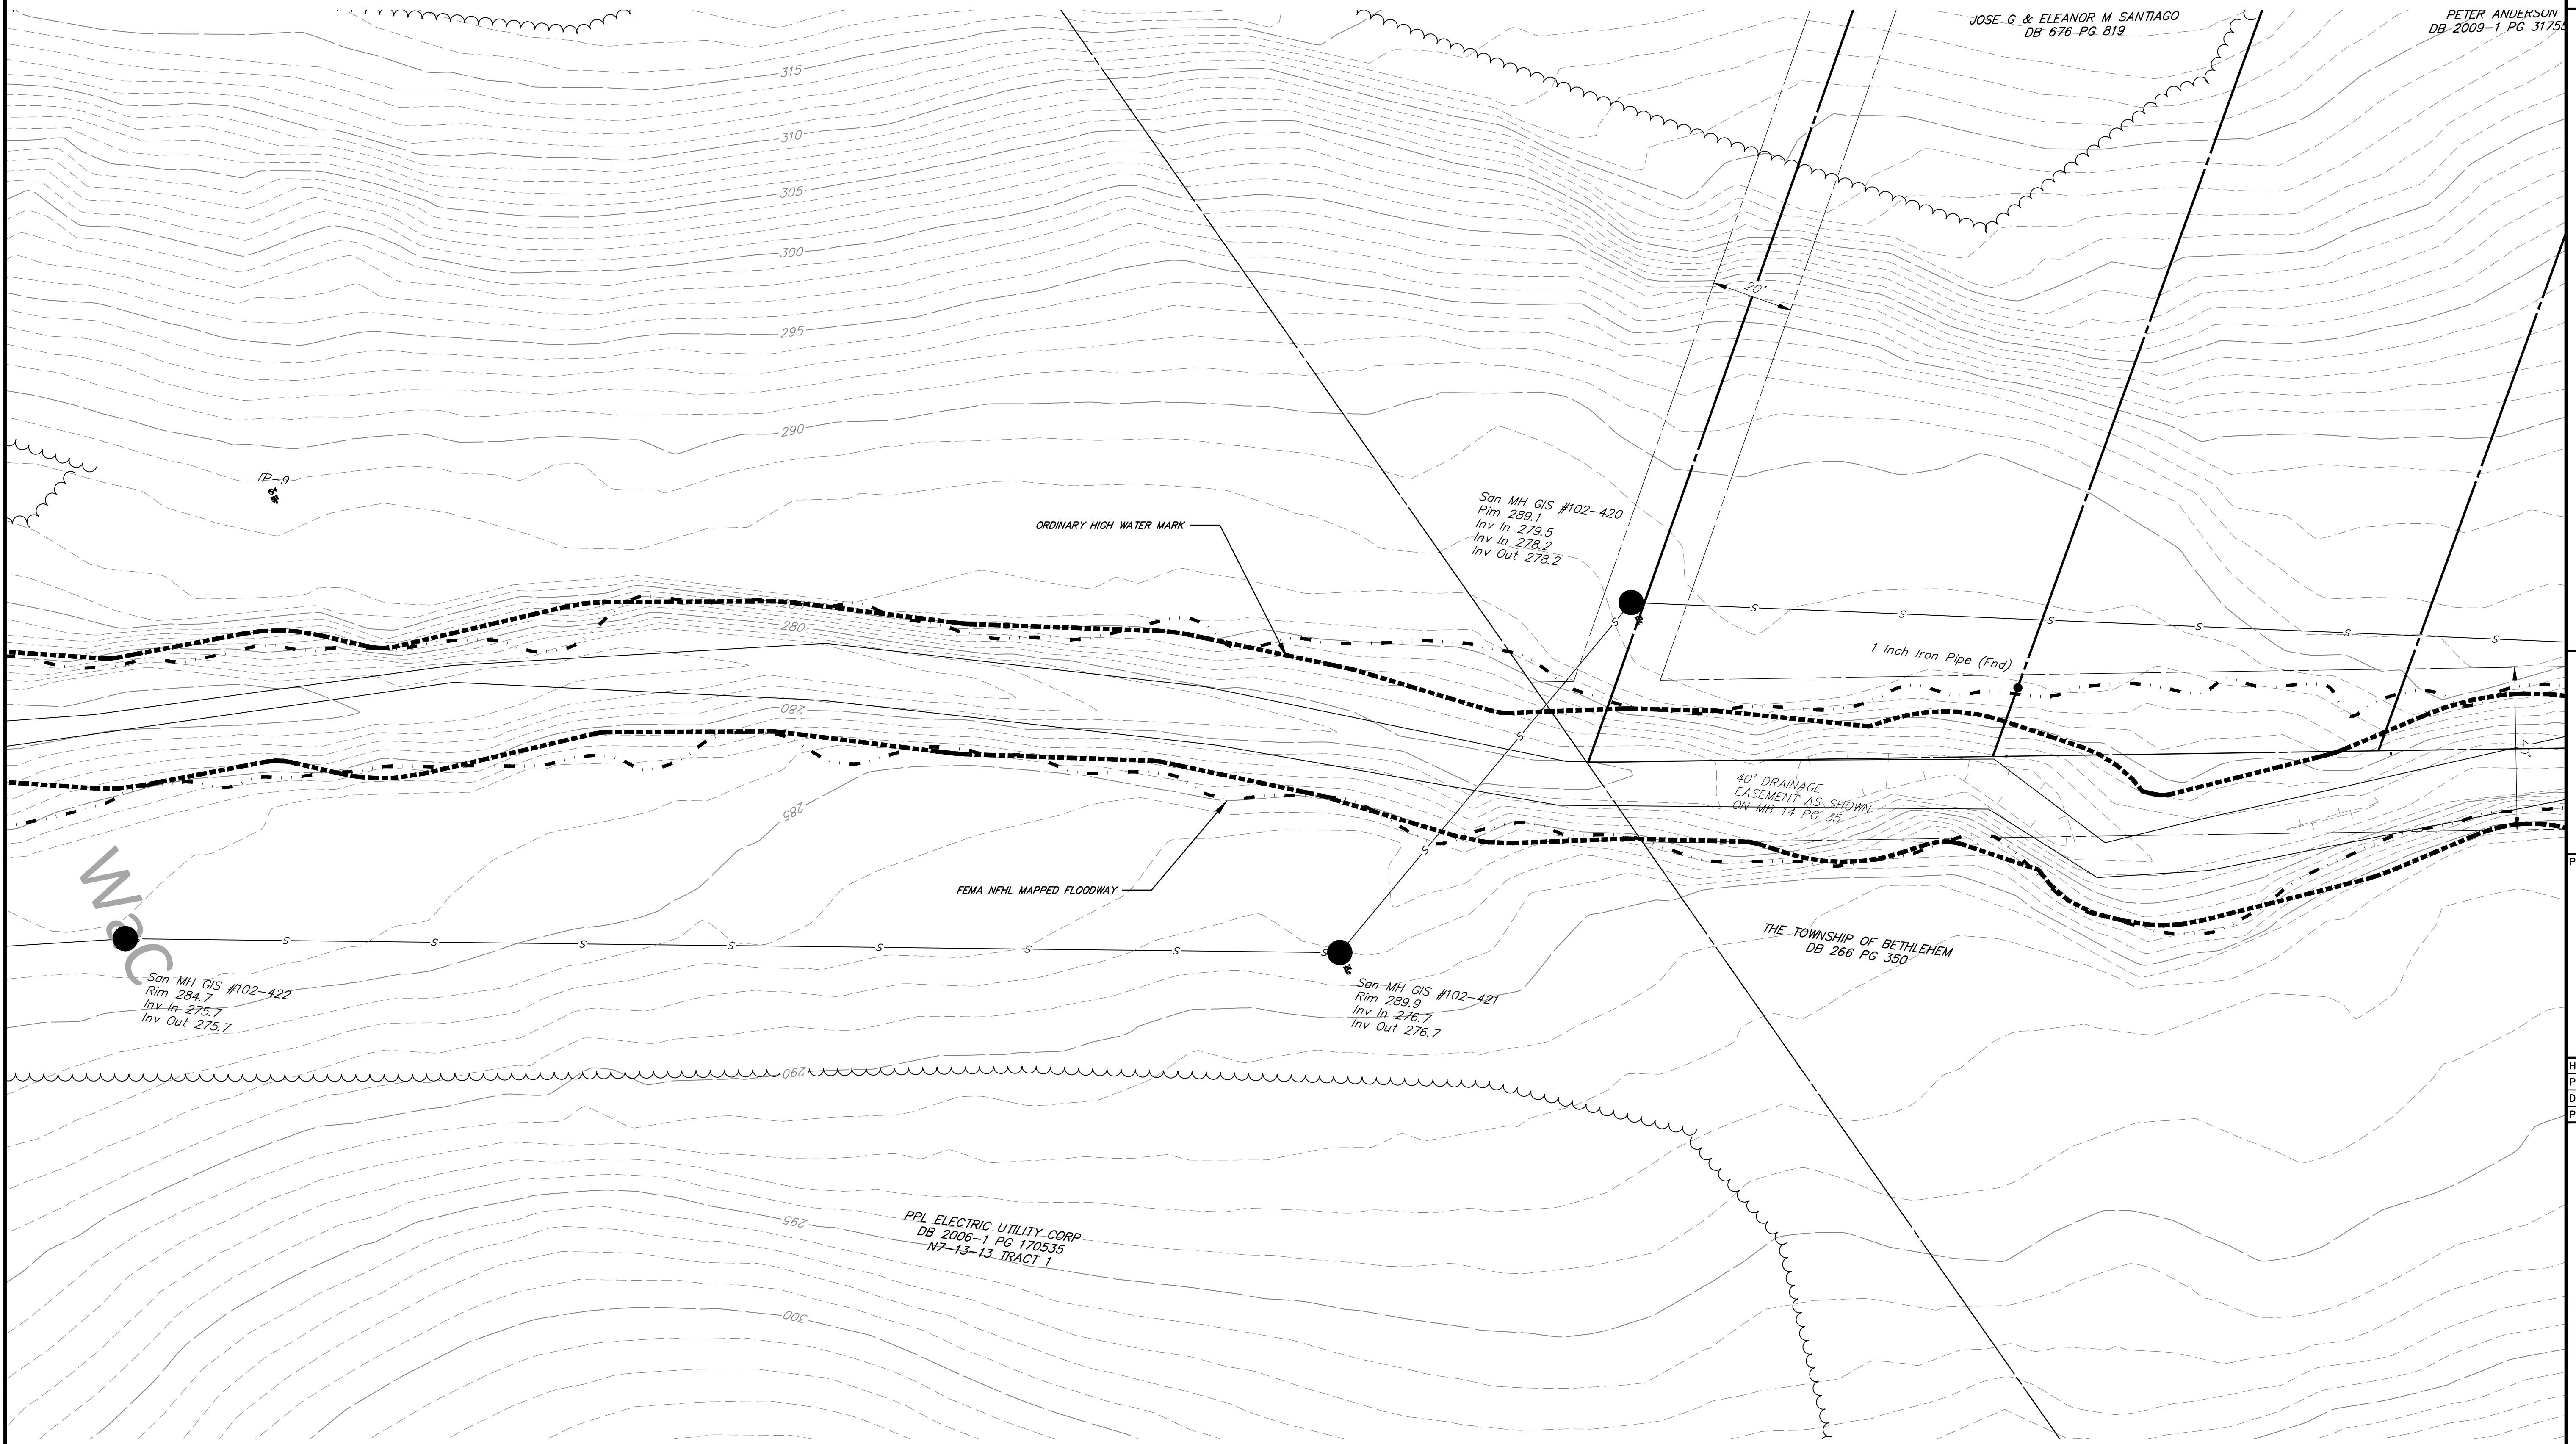
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EXISTING
CONDITIONS
PLAN


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GRAPHIC SCALE
20' 10' 0' 20'
SCALE: 1" = 20'

EX-02 04



CONSTRUCTION AND EROSION CONTROL PLANS
FOR
SCULAC ROAD STREAM RESTORATION
BETHLEHEM TOWNSHIP MUNICIPAL AUTHORITY
BETHLEHEM, PA 18020
NORTHAMPTON COUNTY, PENNSYLVANIA

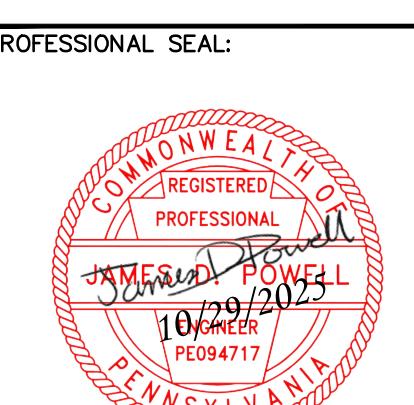

HRG PROJECT NUMBER: R009170.0431
PLAN DATE: FEBRUARY 2025
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PROJ. MANAGER: MATTHEW VANASKE


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EXISTING
CONDITIONS
PLAN

GRAPHIC SCALE
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SCALE: 1" = 20'

EX-04

06

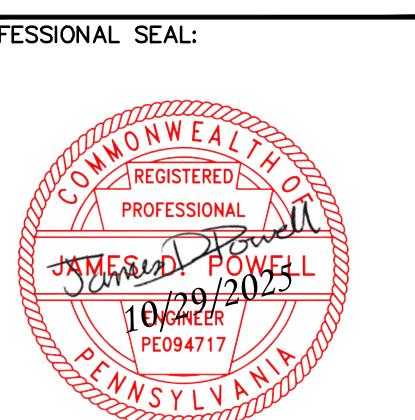


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SHEET TITLE:
EXISTING
CONDITIONS
PLAN

SHEET: EX-05
07

GRAPHIC SCALE
20' 10' 0' 20'
SCALE: 1" = 20'

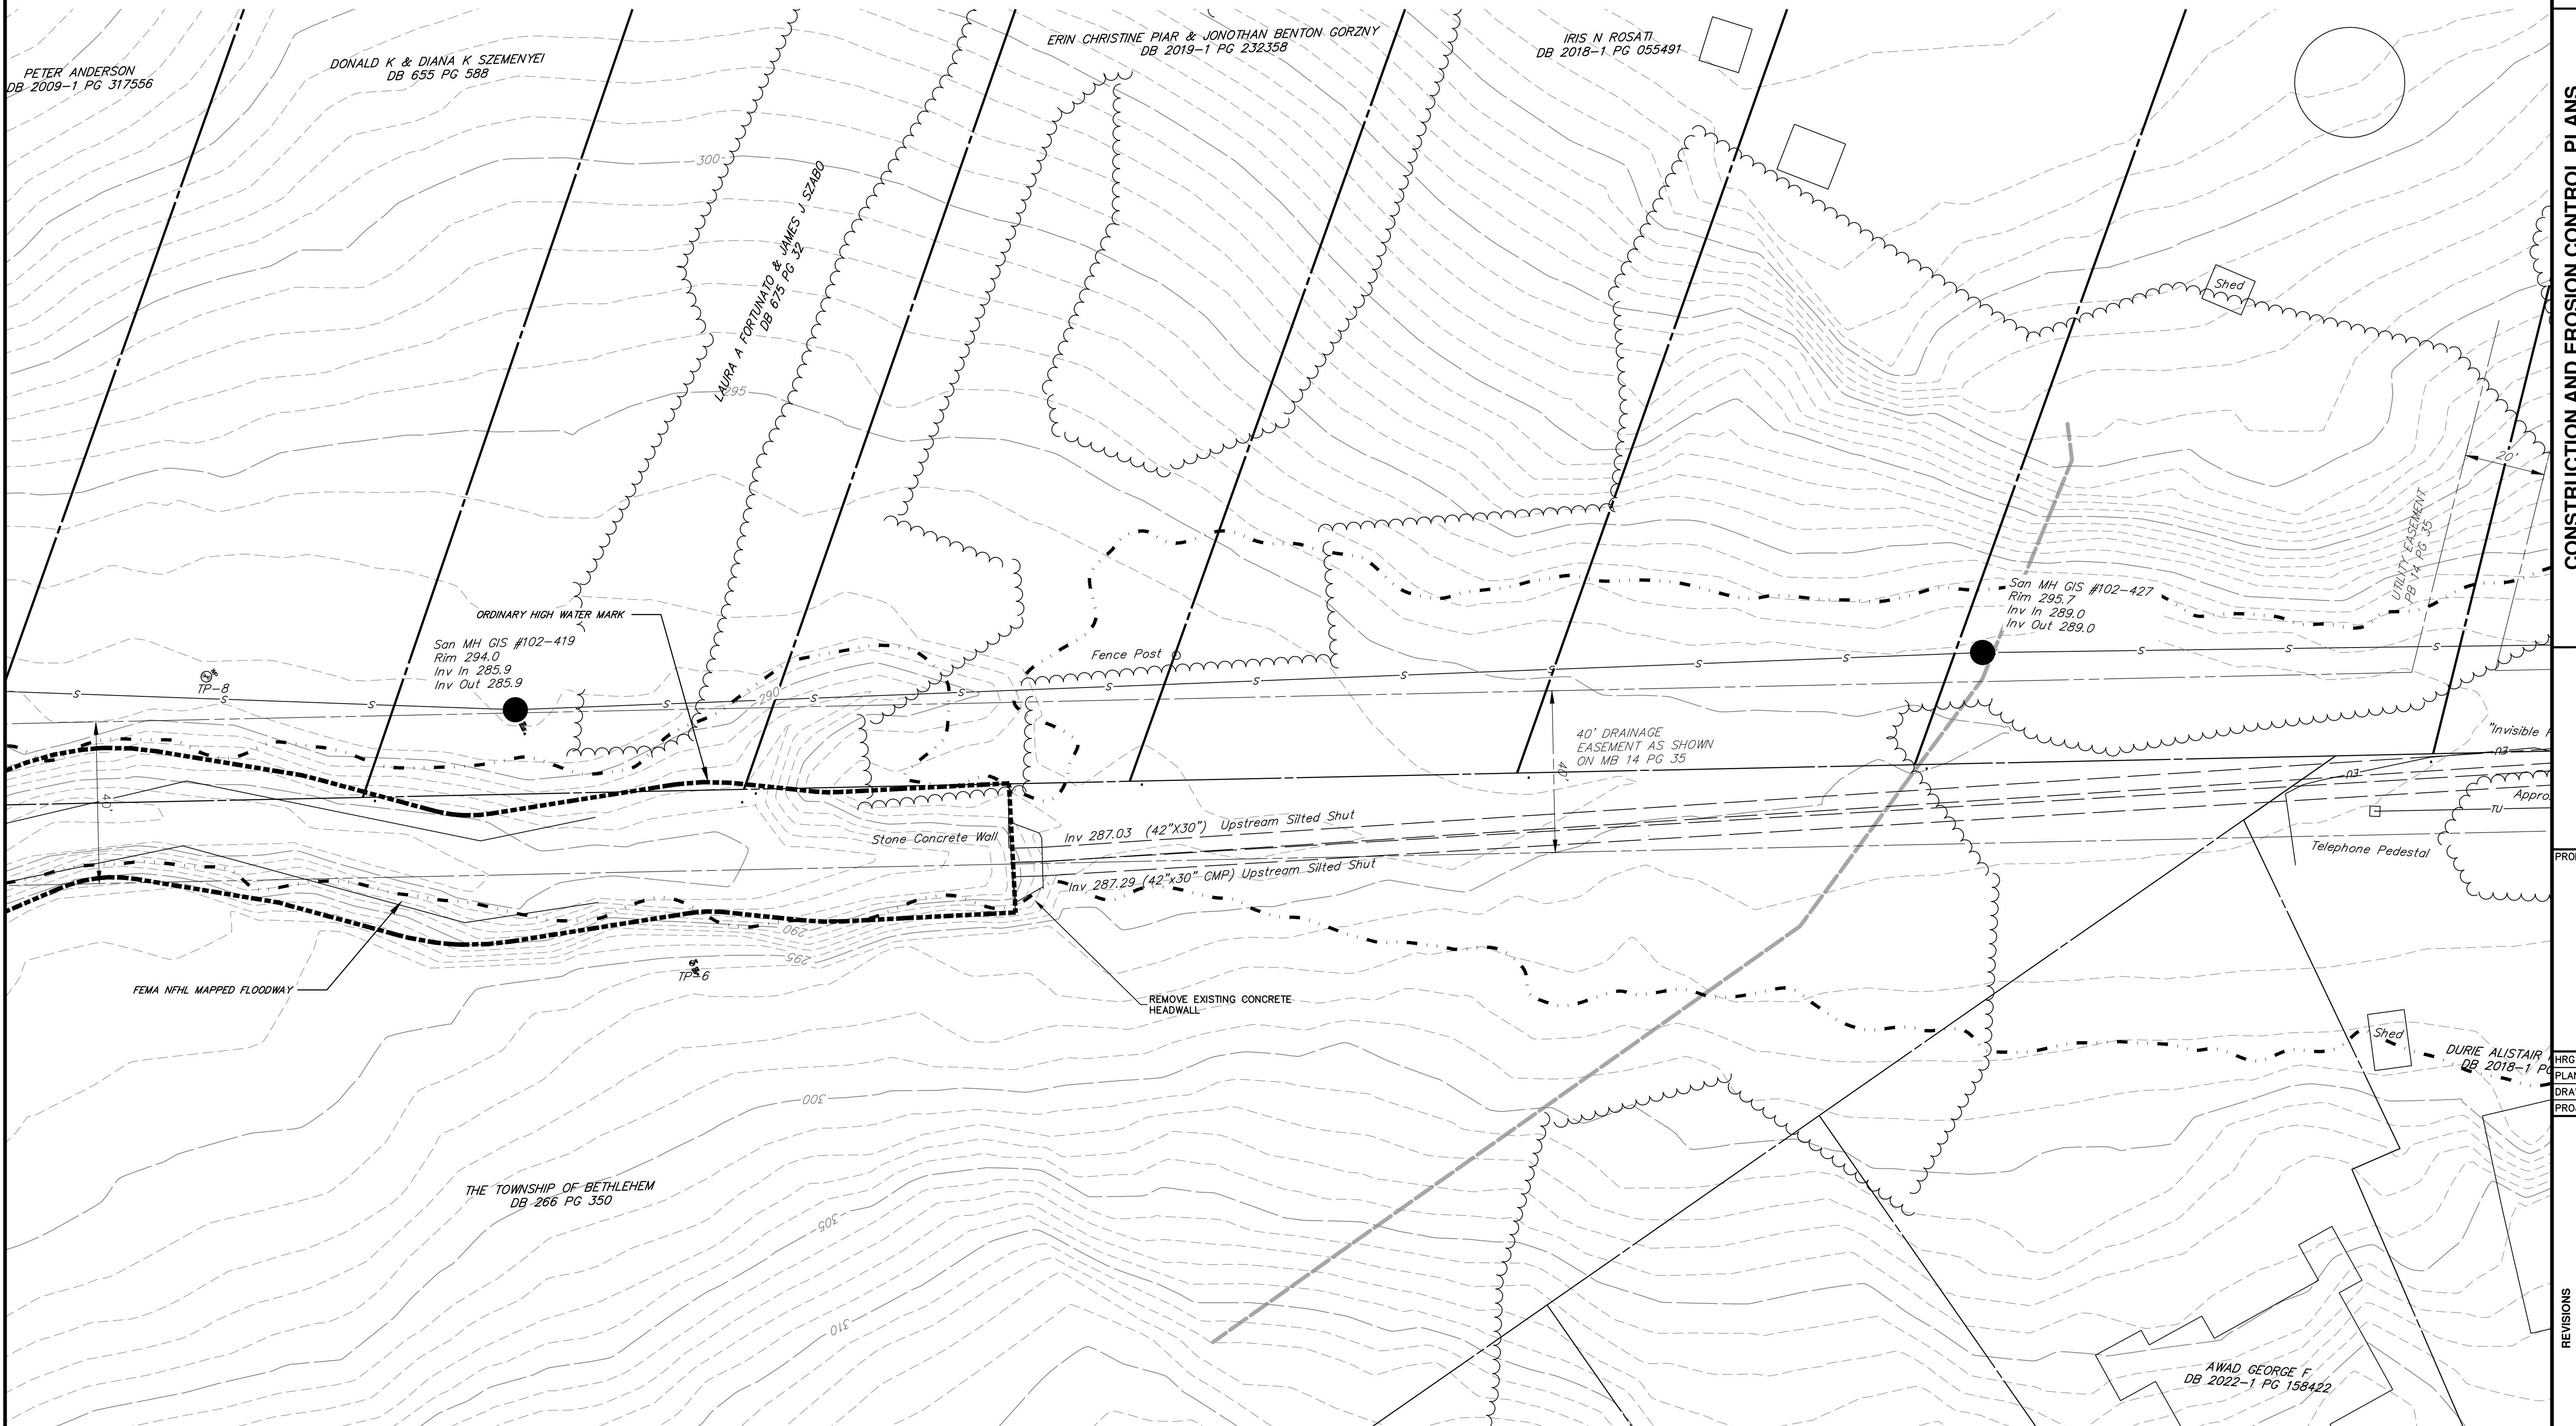


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SHEET TITLE:
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PLAN

SHEET: EX-05
07

CONSTRUCTION AND EROSION CONTROL PLANS
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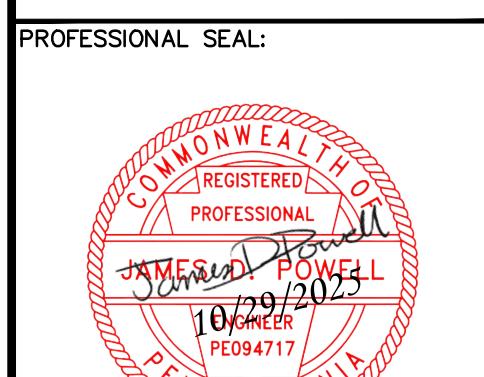
4225 EASTON AVENUE
BETHLEHEM, PA 18020
BETHLEHEM TOWNSHIP, NORTHAMPTON COUNTY, PENNSYLVANIA



PROPOSED STREAM CENTERLINE				
NUMBER	LENGTH	RADIUS	LINE / CHORD BEARING	A VALUE
C1	14.362	31.441	N41° 54' 33.34"E	
C2	28.484	30.000	N27° 47' 40.32"E	
C3	52.276	65.000	N23° 38' 02.88"E	
C4	38.894	80.000	N32° 44' 47.16"E	
C5	105.592	180.000	N35° 37' 26.88"E	
C6	24.476	85.000	N60° 40' 43.93"E	
C7	3.169	95.000	N69° 53' 01.20"E	
C8	32.165	90.000	N81° 04' 39.82"E	
C9	111.360	115.000	N63° 34' 30.29"E	
C10	13.747	80.000	N40° 45' 23.98"E	
C11	30.341	120.000	N52° 55' 21.86"E	
C12	25.261	120.000	N62° 28' 38.92"E	
C13	28.796	120.000	N61° 38' 00.67"E	
C14	63.088	55.000	N21° 53' 54.47"E	
C15	43.596	65.000	N8° 15' 08.58"E	
C16	192.833	190.000	N56° 32' 31.06"E	
C17	30.061	150.000	N79° 52' 33.34"E	
C18	43.031	90.000	N60° 26' 15.50"E	
C19	22.145	40.000	N30° 52' 50.08"E	
C20	13.714	120.000	N18° 17' 40.47"E	

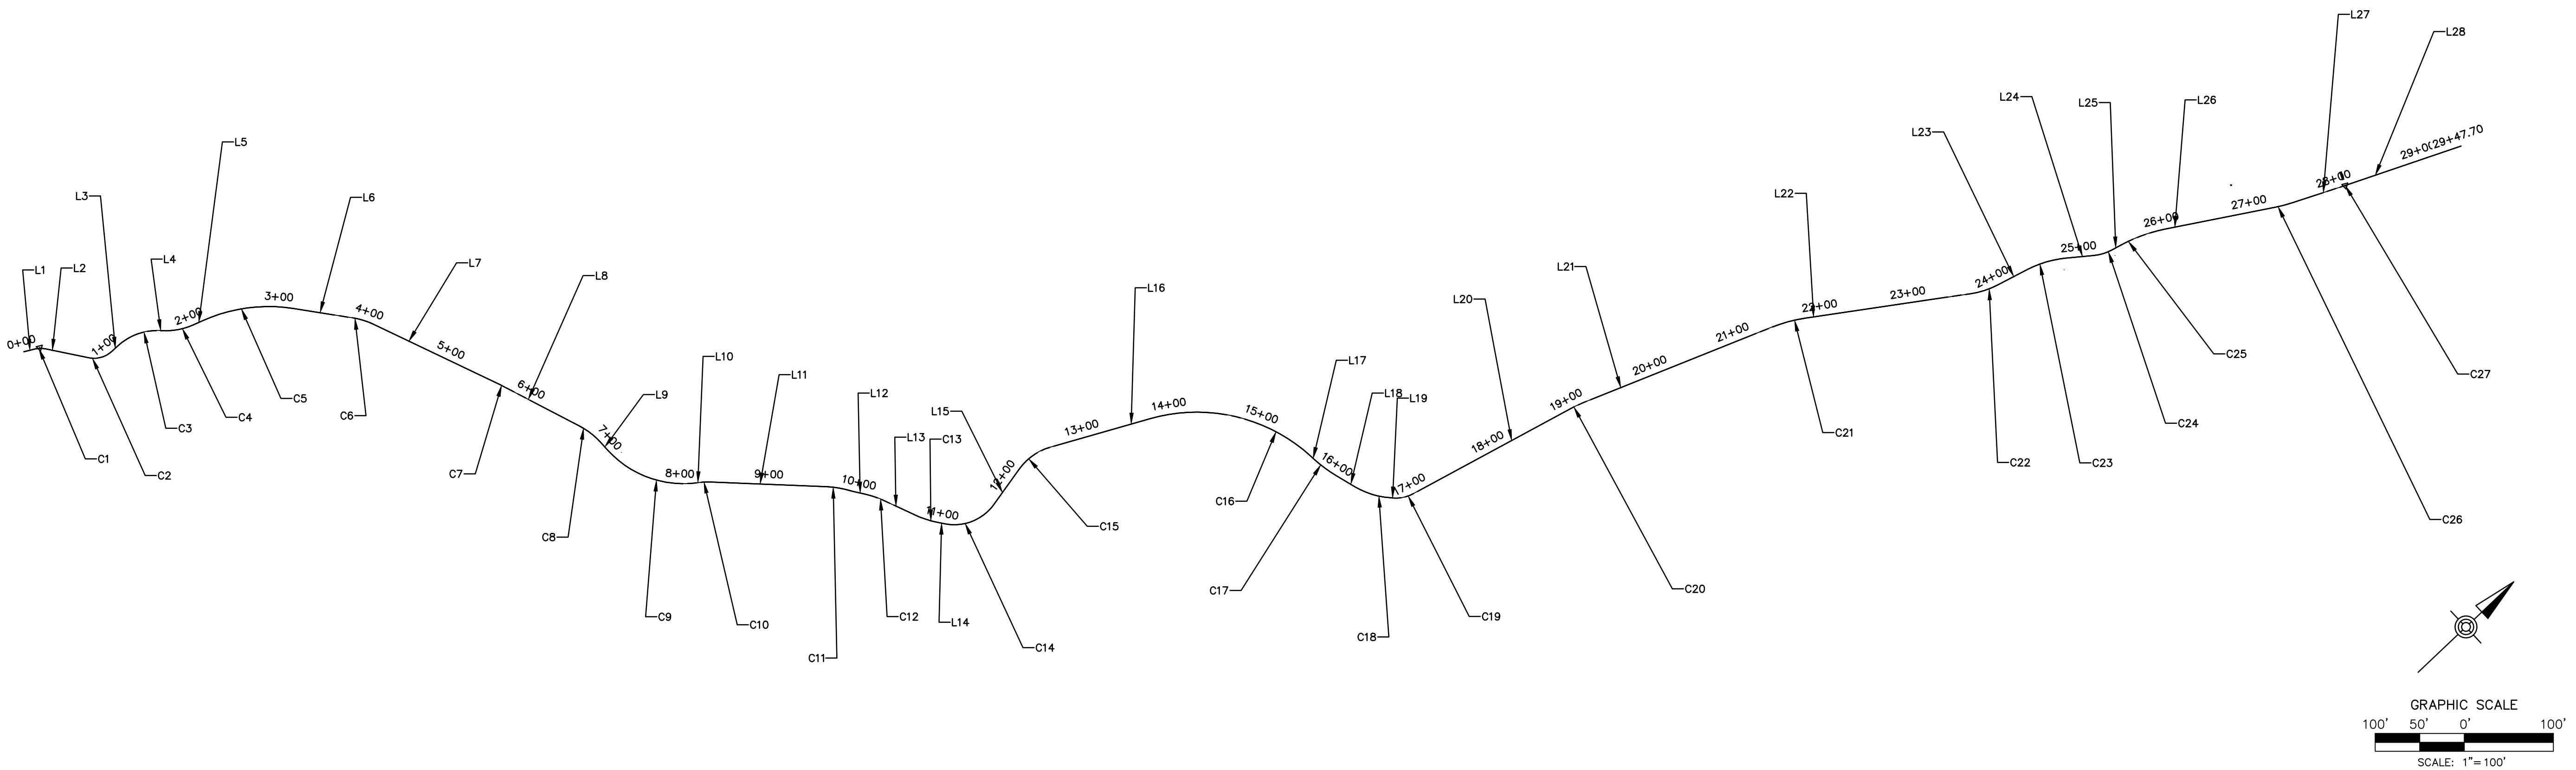PROPOSED STREAM CENTERLINE				
C21	42.188	180.000	N28° 16' 58.49"E	
C22	31.640	95.000	N25° 27' 21.47"E	
C23	46.430	120.000	N26° 59' 55.99"E	
C24	22.913	55.000	N26° 08' 53.68"E	
C25	59.724	190.000	N23° 13' 06.31"E	
C26	21.686	180.000	N28° 46' 19.36"E	
C27	0.411	31.441	N24° 56' 44.99"E	
L1	10.963		N28° 49' 24.49"E	
L2	48.797		N54° 59' 42.20"E	
L3	8.558		N0° 35' 38.45"E	
L4	0.658		N46° 40' 27.32"E	
L5	8.887		N18° 49' 07.00"E	
L6	67.370		N52° 25' 46.77"E	
L7	156.426		N68° 55' 41.10"E	
L8	96.746		N70° 50' 21.30"E	
L9	10.483		S88° 41' 01.66"E	
L10	1.977		N35° 50' 02.24"E	
L11	128.064		N45° 40' 45.72"E	
L12	15.162		N56° 26' 48.98"E	
L13	34.476		N68° 30' 28.88"E	


PROPOSED STREAM CENTERLINE				
L14	7.397		N54° 45' 32.46"E	
L15	48.543		N10° 57' 43.52"W	
L16	116.724		N27° 28' 00.67"E	
L17	5.787		N85° 37' 01.45"E	
L18	24.712		N74° 08' 05.22"E	
L19	3.228		N46° 44' 25.78"E	
L20	202.709		N15° 01' 14.37"E	
L21	226.772		N21° 34' 06.56"E	
L22	186.134		N34° 59' 50.41"E	
L23	37.238		N15° 54' 52.52"E	
L24	30.173		N38° 04' 59.46"E	
L25	6.234		N14° 12' 47.89"E	
L26	122.469		N32° 13' 24.73"E	
L27	61.331		N25° 19' 13.99"E	
L28	137.296		N24° 34' 15.99"E	



HRG PROJECT NUMBER: R009170.0431
PLAN DATE: FEBRUARY 2025
DRAWING SCALE: AS SHOWN
PROJ. MANAGER: MATTHEW VANASKE

REVISIONS		DESCRIPTION	
NO.	DATE	1	2
1	03/05/25	REVISED PER NCCD COMMENTS	
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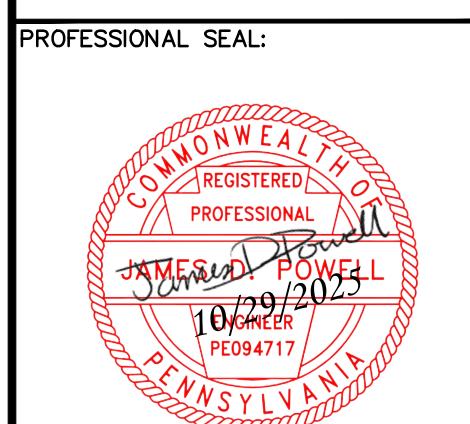
FILE NAME: GEO-01.DWG
FILE DATE: 10/29/2025
LAST UPDATED: 10/29/2025
LAYOUT: SCULAC ROAD CENTERLINE
Sheet Title: STREAM CENTERLINE GEOMETRY PLAN
Sheet: GEO-01
Page: 08

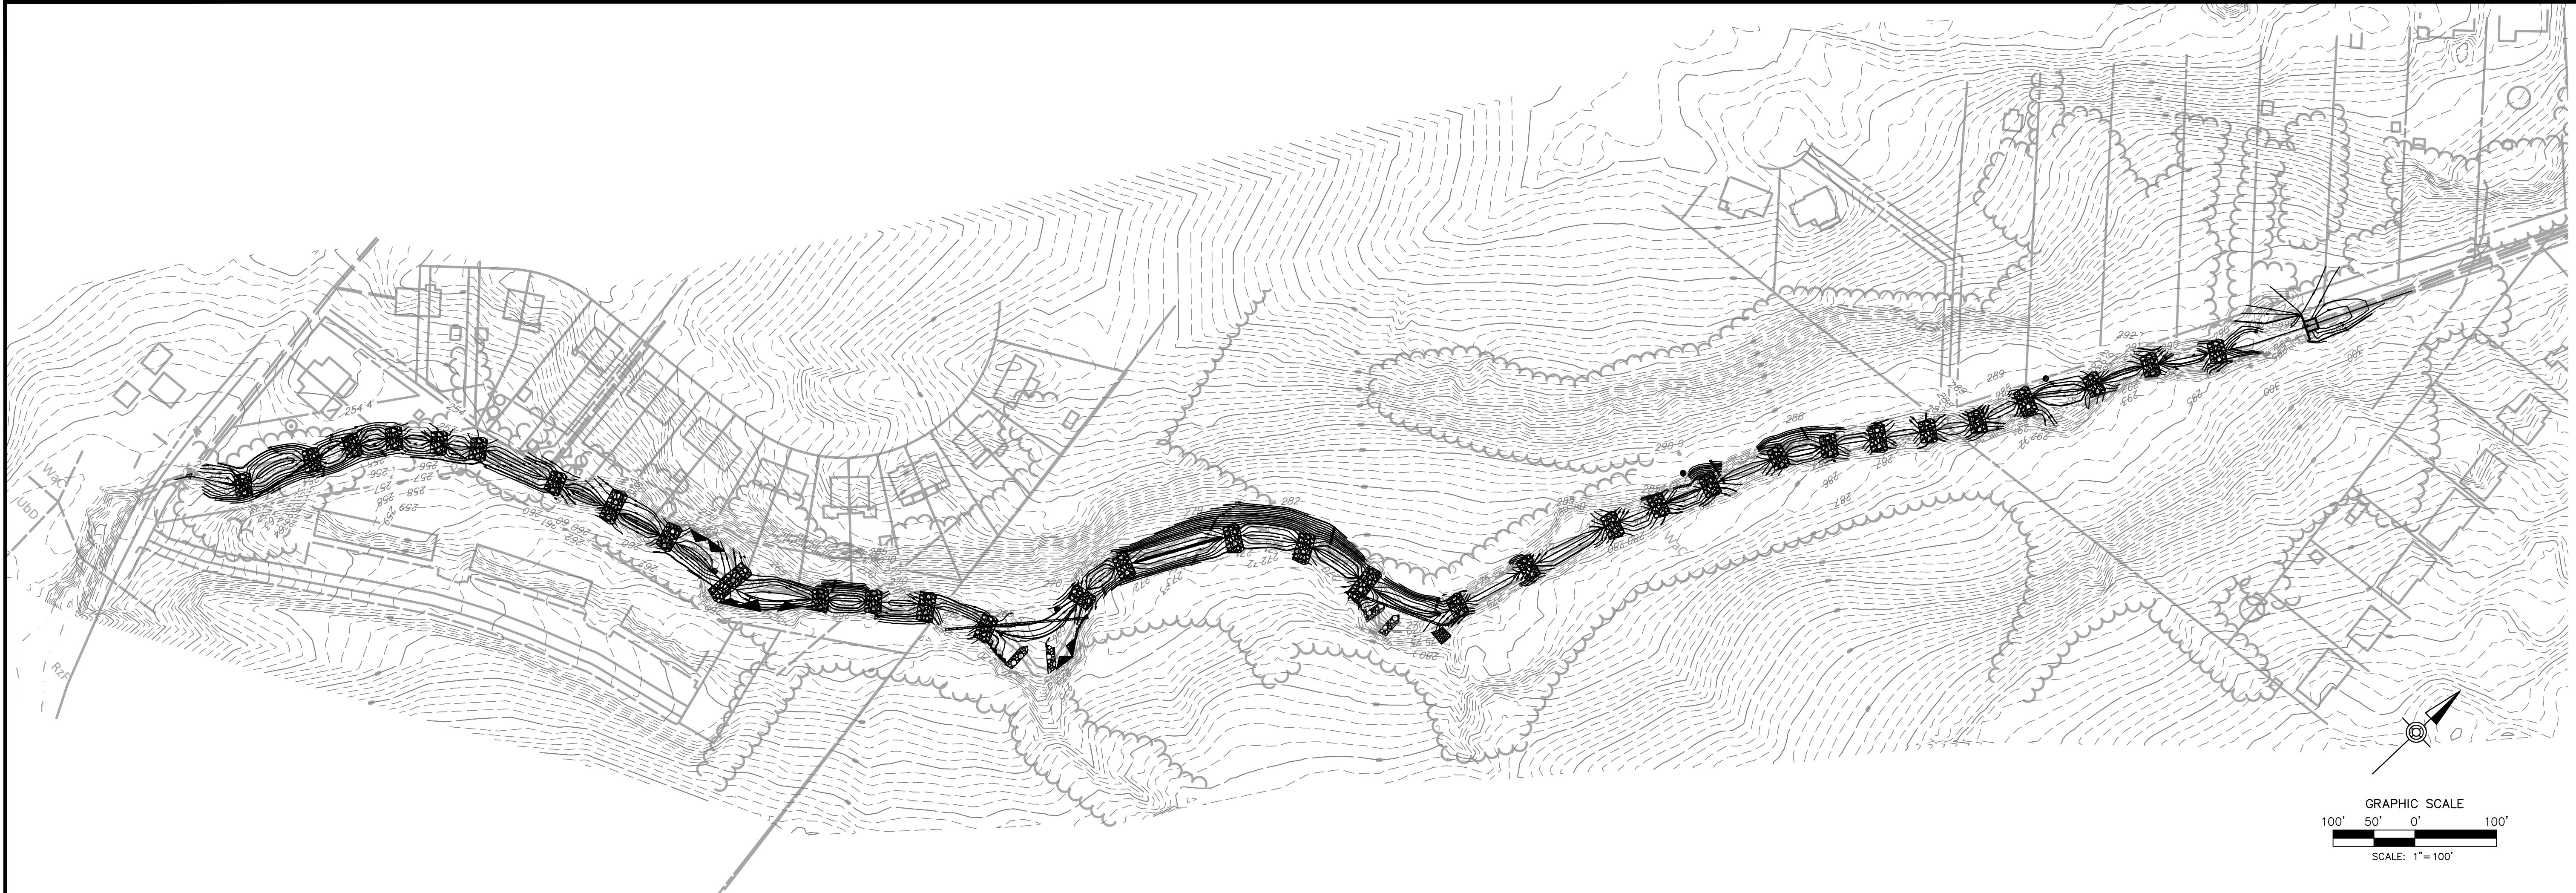

STRUCTURES TABLE - CASCADES		
ID NUMBER	WIDTH (FT.)	DEPTH (FT.)
C.1	25'	1.0
C.2	25'	1.0
C.3	25'	1.25
C.4	31'	1.0
C.5	25'	1.0
C.6	25'	1.0
C.7	31'	1.0
C.8	25'	1.0
C.9	25'	1.50
C.10	25'	1.50
C.11	25'	1.0
C.12	28'	1.0
C.13	25'	1.50
C.14	25'	1.0
C.15	43'	1.50
C.16	33'	1.50
C.17	31'	1.0
C.18	27'	1.0
C.19	28'	1.0
C.20	30'	1.50
C.21	33'	1.25
C.22	25'	1.25
C.23	25'	1.50
C.24	53'	1.50
C.25	30'	1.50
C.26	38'	1.50
C.27	25'	1.50
C.28	25'	1.0
C.29	25'	1.0
C.30	25'	1.0
C.31	25'	1.0
C.32	25'	1.0
C.33	25'	1.0

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FOR
SCULAC ROAD STREAM RESTORATION

BETHLEHEM TOWNSHIP MUNICIPAL AUTHORITY
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4225 EASTON AVENUE
BETHLEHEM TOWNSHIP, NORTHAMPTON COUNTY, PENNSYLVANIA



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NO.	DATE	DESCRIPTION
1	02/25/2025	REVISED PER NCCD COMMENTS
2	10/01/2025	REVISED PER CONSTRUCTIONABILITY REVIEW
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OVERALL
STREAM
RESTORATION
PLAN

FILE NAME: R009170.0431.DWG SHEET NAME: SR-OVR SHEET NUMBER: 09
LAST DRAWN: 10/29/2025 11:15 AM BY POWELL

CONSTRUCTION AND EARTHWORKS CONTRACT
FOR
SCULAC ROAD STREAM RESTORATION

4225 EASTON AVENUE
BETHLEHEM, PA 18020
NORTHAMPTON COUNTY
PA 18045
BETHLEHEM TOWNSHIP
PENNSYLVANIA

PALESTINE TOWNSHIP MUNICIPAL AUTHORITY
1005 EASTON AVENUE

OCULAC ROAD STREAM RESTORATION

THE ANNUAL CONVENTION FOR

PRO





PROJECT NUMBER: R009170.043
N DATE: FEBRUARY 2022
WING SCALE: AS SHOWN
L. MANAGED: MATTHEW MANNACK

DESCRIPTION

2
ET TITLE:
**STREAM
RESTORATION
PLAN**

ET: **SB-01**

10

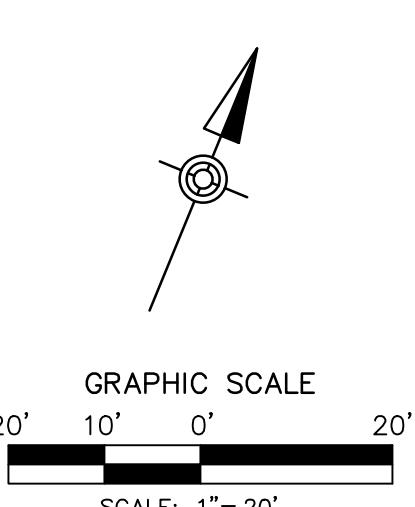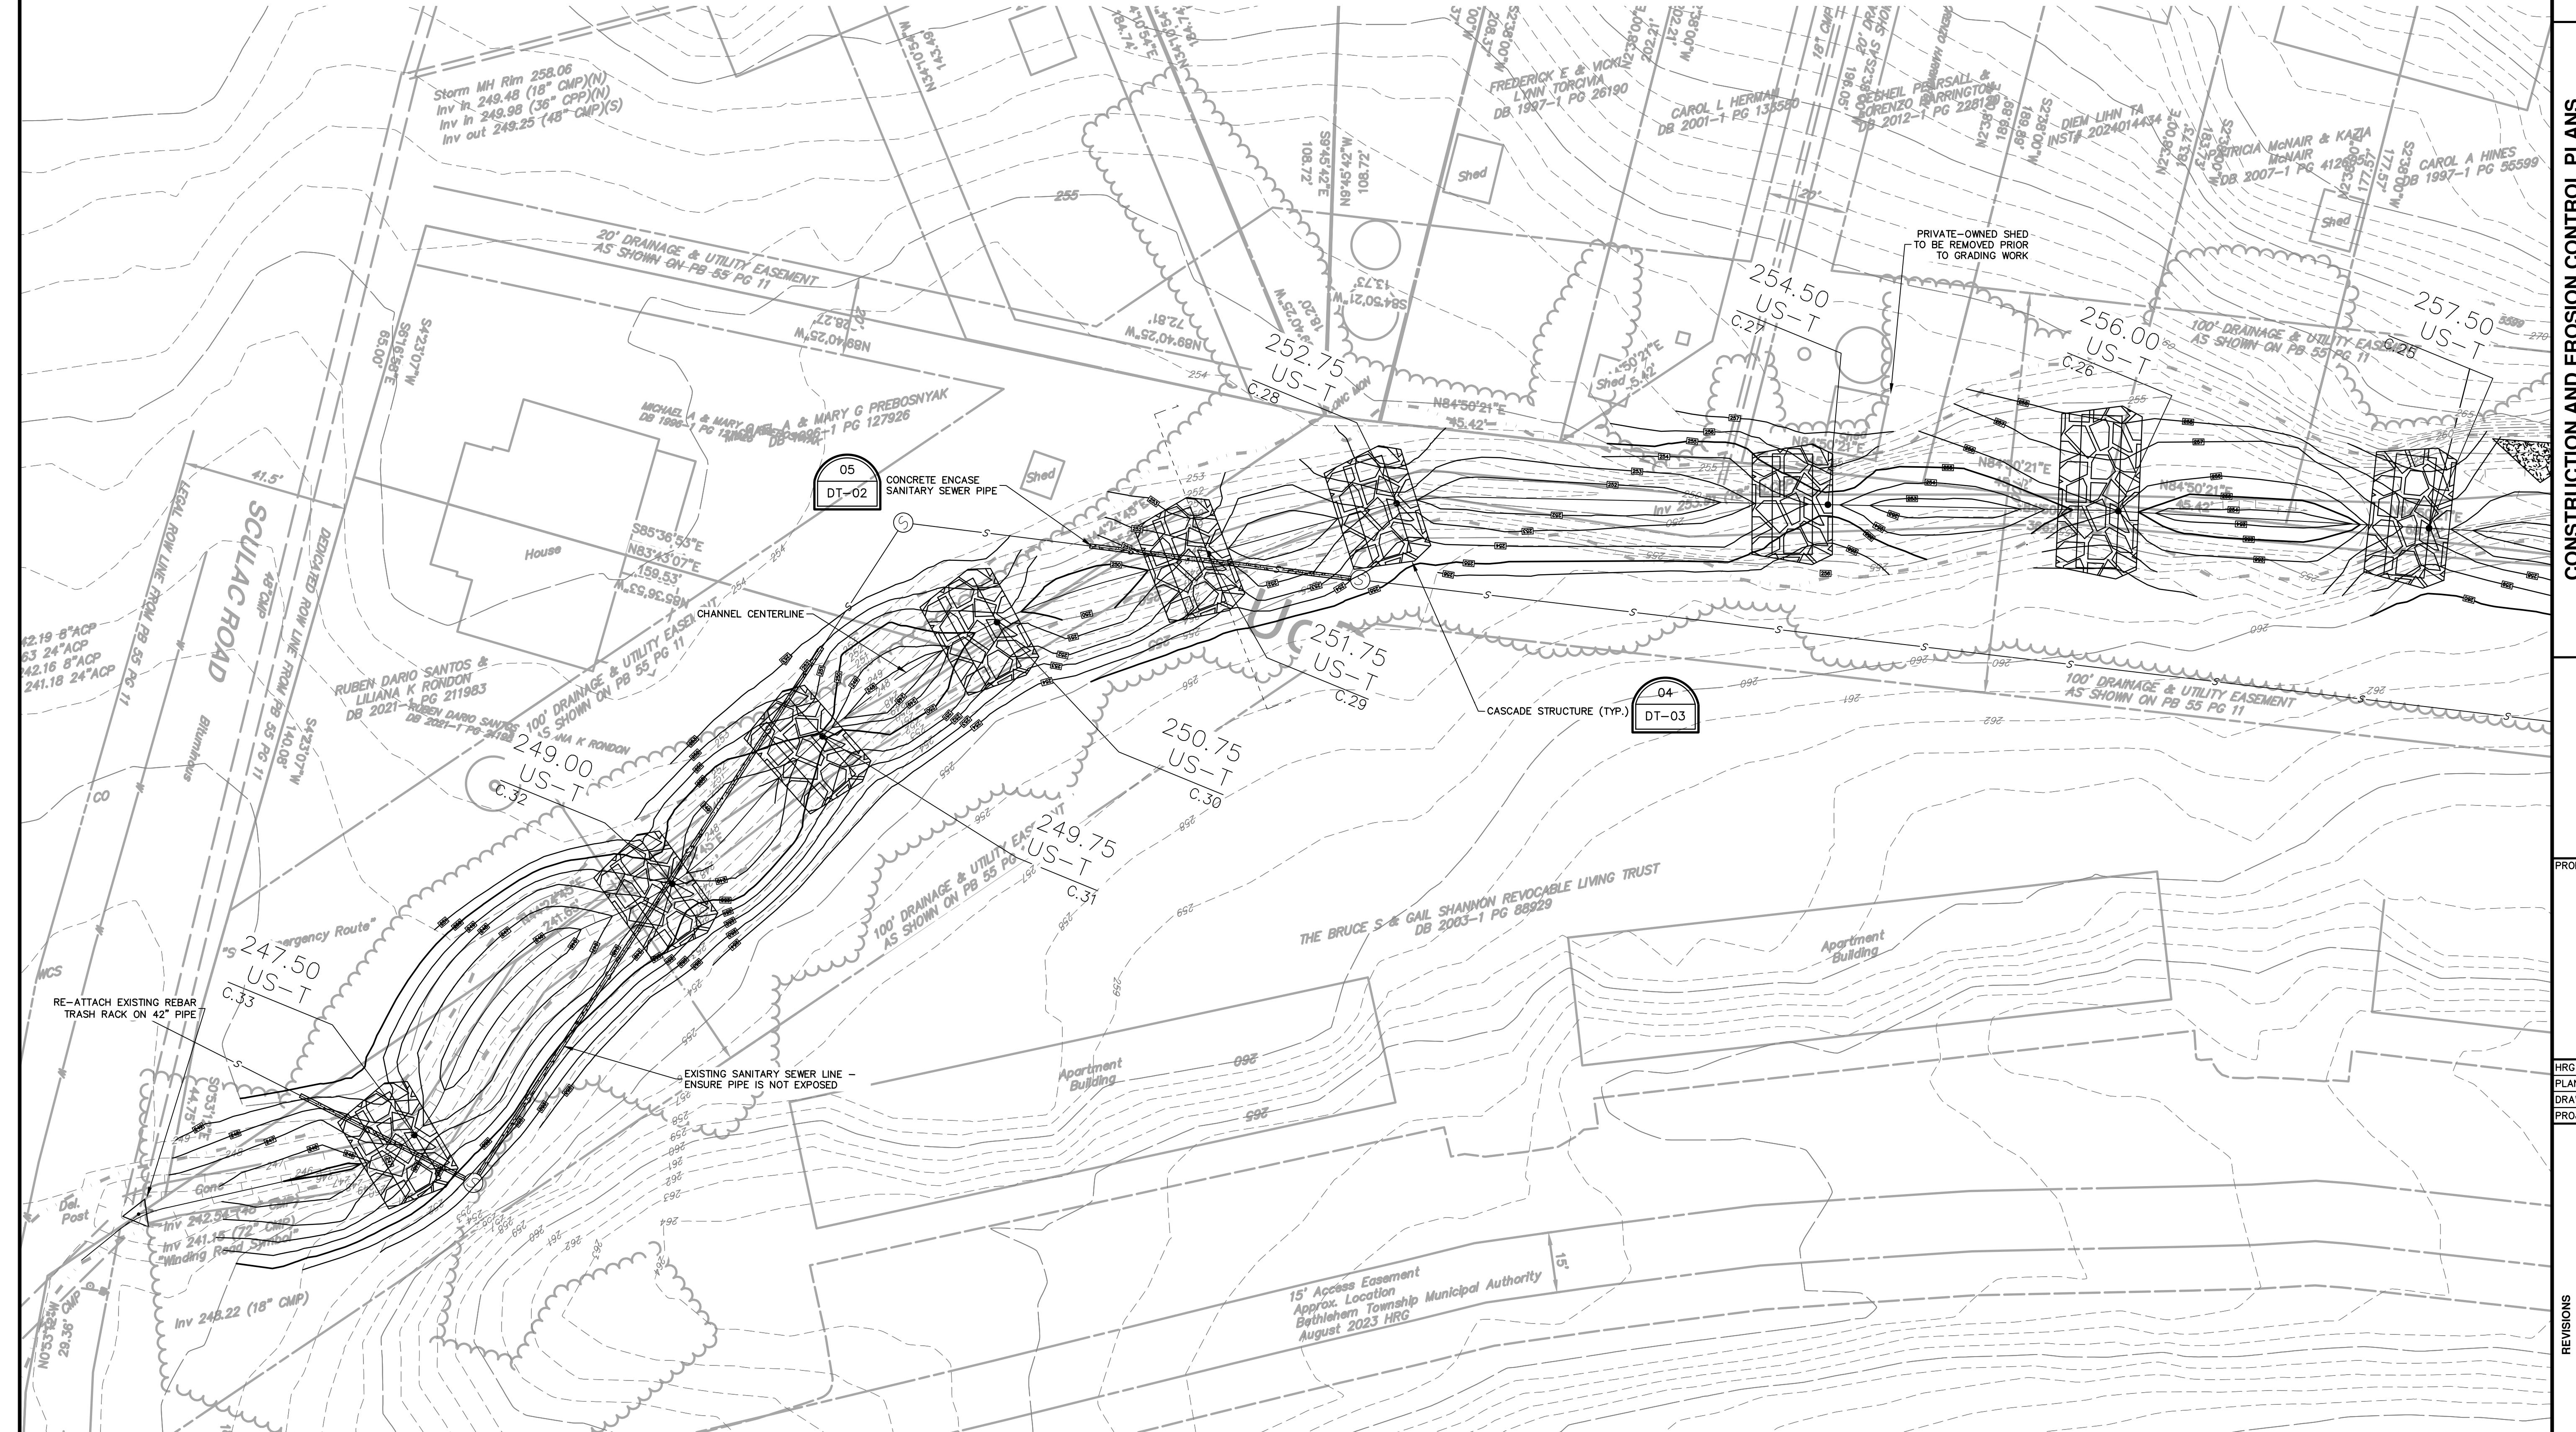

A graphic scale with markings for 20', 10', 0', and 20'. A vertical line is at 0', and a horizontal line is at 1".

ET: **SB-01**

10

CONSTRUCTION AND EROSION CONTROL PLANS FOR SCULAC ROAD STREAM RESTORATION

4225 EASTON AVENUE
BETHLEHEM, PA 18020

The seal is circular with a rope-like border. The words "COMMONWEALTH OF PENNSYLVANIA" are written along the top inner edge, and "PROFESSIONAL" is written along the bottom inner edge. The center contains the text "REGISTERED" above "PROFESSIONAL". Below this, "JAMES D. POWELL" is written in a stylized signature, with "10/29/2025" written above it. At the bottom, "10/29/2025" is written above "ENGINEER" and "PE094717".



HRG PROJECT NUMBER: R009170.043
PLAN DATE: FEBRUARY 2022
DRAWING SCALE: AS SHOWN
PROJ. MANAGER: MATTHEW VANASKIE

REVIZIONS	DESCRIPTION	CCD COMMENTS	CONSTRUCTABILITY RE

SHEET TITLE:
**STREAM
RESTORATION
PLAN**

SHEET: **SB-03**

12

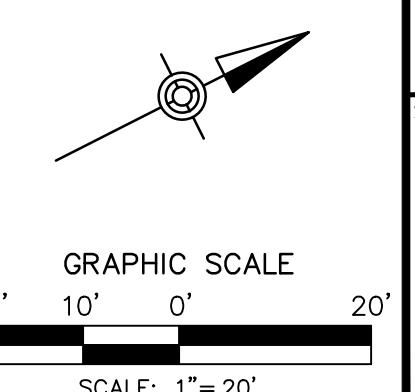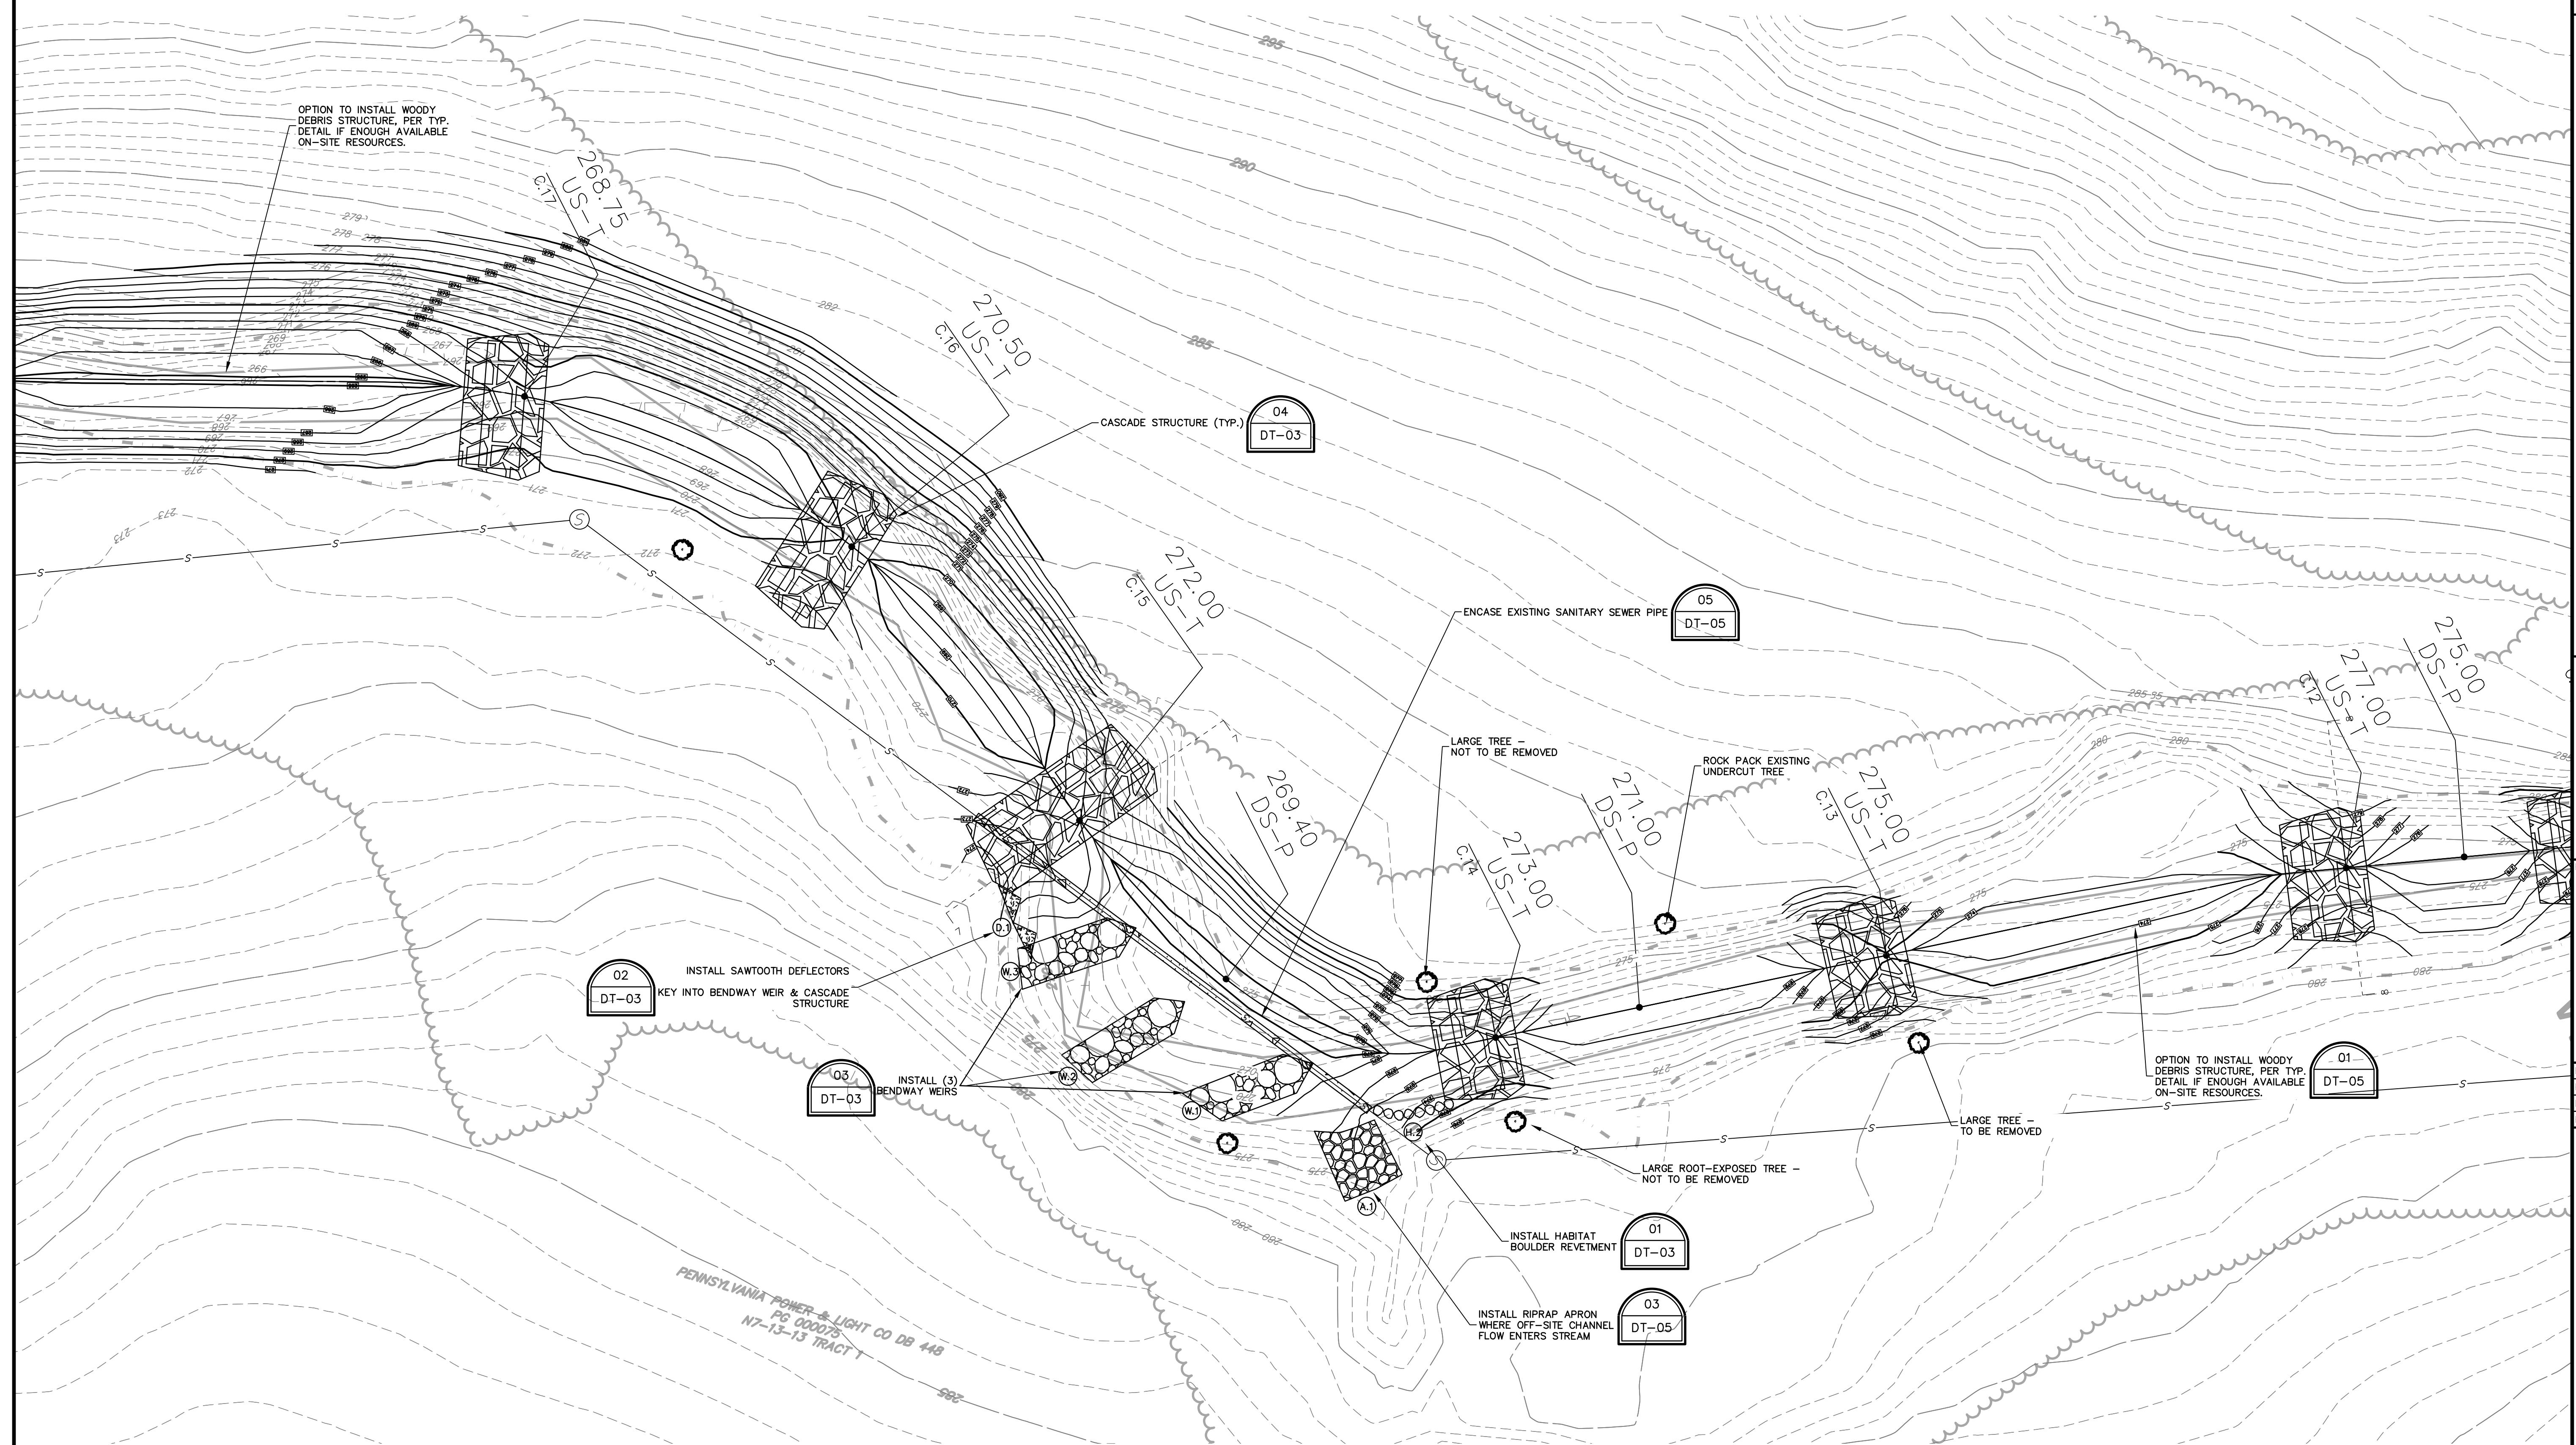


SHEET: **SB-03**

12

PETER ANULAKOV
DB-2009-1 PG 3175

CONSTRUCTION AND EROSION CONTROL PLANS
FOR
SCULAC ROAD STREAM RESTORATION
BETHLEHEM TOWNSHIP MUNICIPAL AUTHORITY
BETHLEHEM, PA 18020
NORTHAMPTON COUNTY, PENNSYLVANIA

BETHLEHEM TOWNSHIP, NORTHAMPTON COUNTY, PENNSYLVANIA

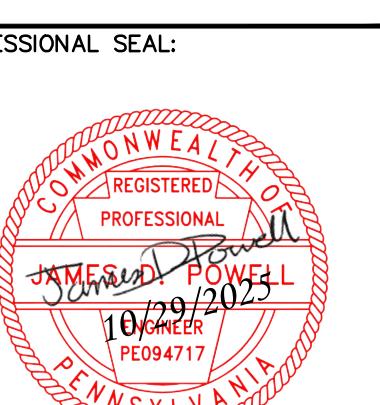

HRG PROJECT NUMBER: R009170.0431
PLAN DATE: FEBRUARY 2025
DRAWING SCALE: AS SHOWN
PROJ. MANAGER: MATTHEW VANASKIE

REVISIONS


NO.	DATE	DESCRIPTION
1	03/05/25	REVISED PER NCCD COMMENTS
2	10/01/25	REVISED PER CONSTRUCTIONABILITY REVIEW
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9		

STREAM
RESTORATION
PLAN

FILE NAME: R009170.0431.DWG SHEET: SR-04

LAST DRAWN: 10/29/2025 BY: M. VANASKIE

FILE NAME: R009170.0431.DWG SHEET: 13

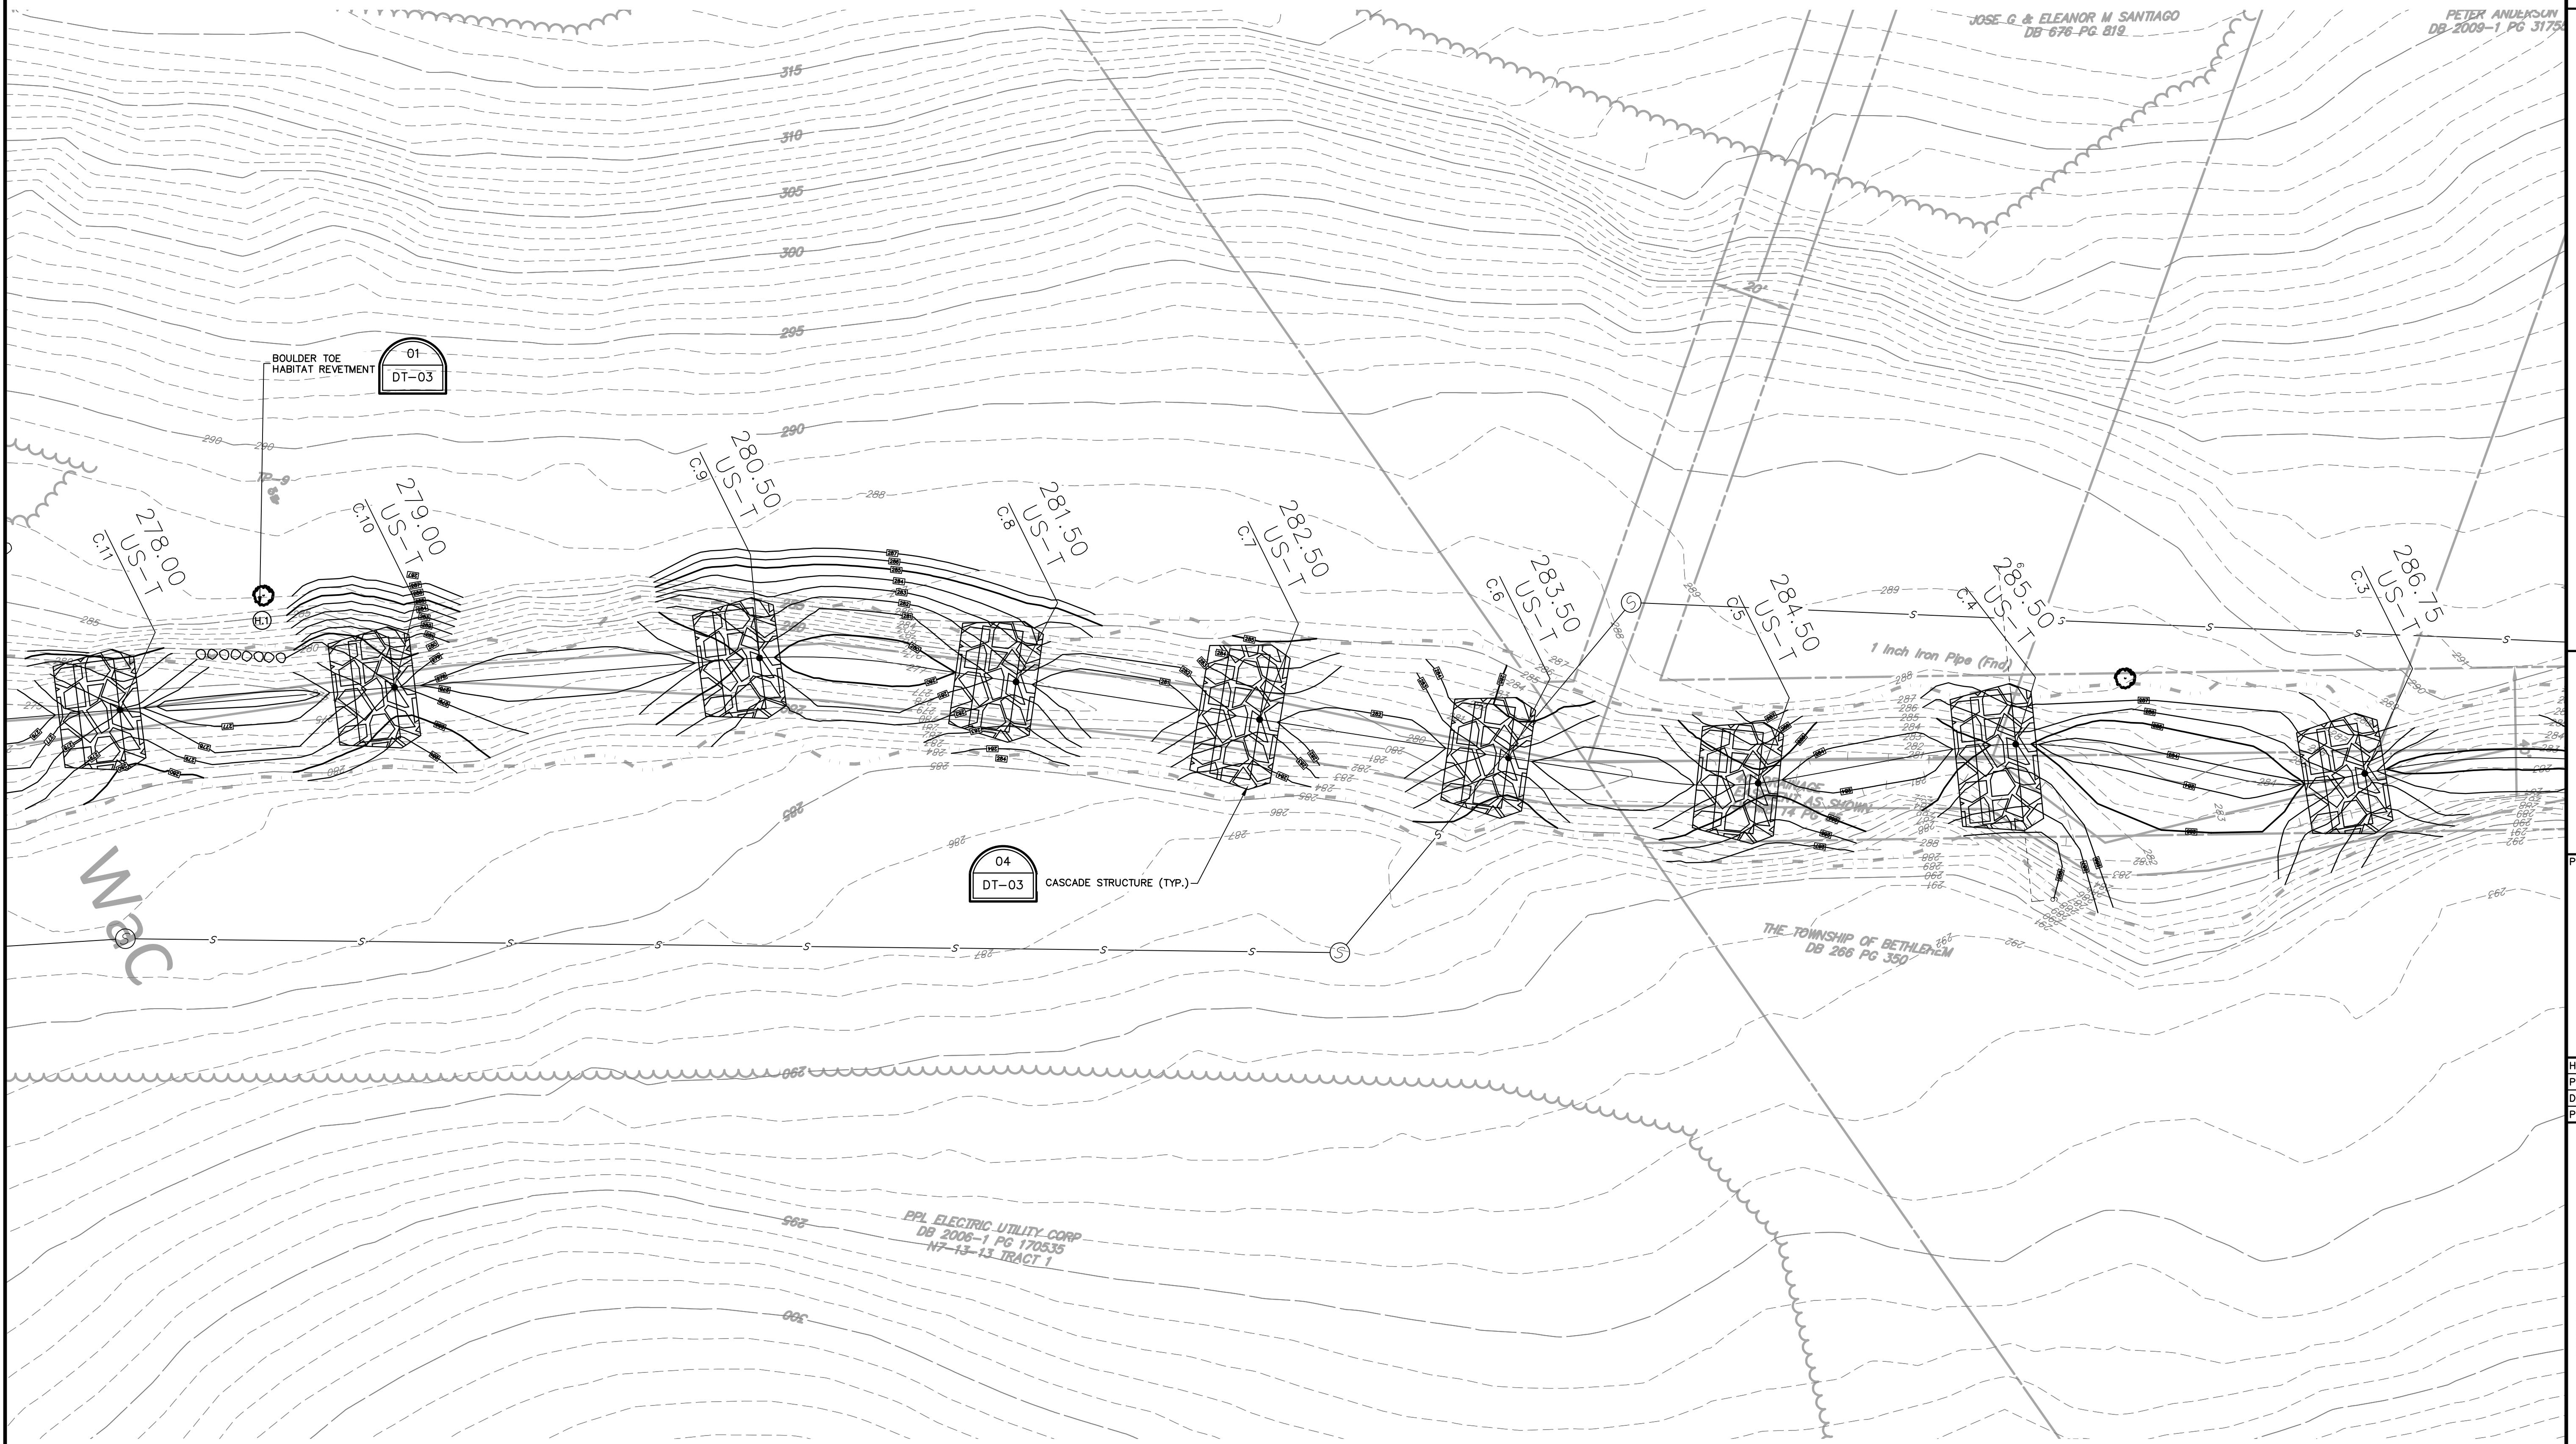

GRAPHIC SCALE
20' 10' 0' 20'
SCALE: 1" = 20'

FILE NAME: R009170.0431.DWG SHEET: SR-04


LAST DRAWN: 10/29/2025 BY: M. VANASKIE

FILE NAME: R009170.0431.DWG SHEET: 13

CONSTRUCTION AND EROSION CONTROL PLANS
FOR

SCULAC ROAD STREAM RESTORATION

BETHLEHEM TOWNSHIP MUNICIPAL AUTHORITY
4225 EASTON AVENUE
BETHLEHEM, PA 18020
NORTHAMPTON COUNTY, PENNSYLVANIA

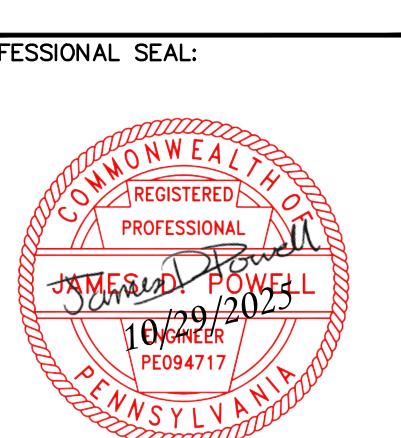

HRG PROJECT NUMBER: R009170.0431
PLAN DATE: FEBRUARY 2025
DRAWING SCALE: AS SHOWN
PROJ. MANAGER: MATTHEW VANASKIE

REVISIONS
NO. DATE DESCRIPTION

1 03/05/25 REVISED PER NCCD COMMENTS

2 10/01/25 REVISED PER CONSTRUCTIONABILITY REVIEW

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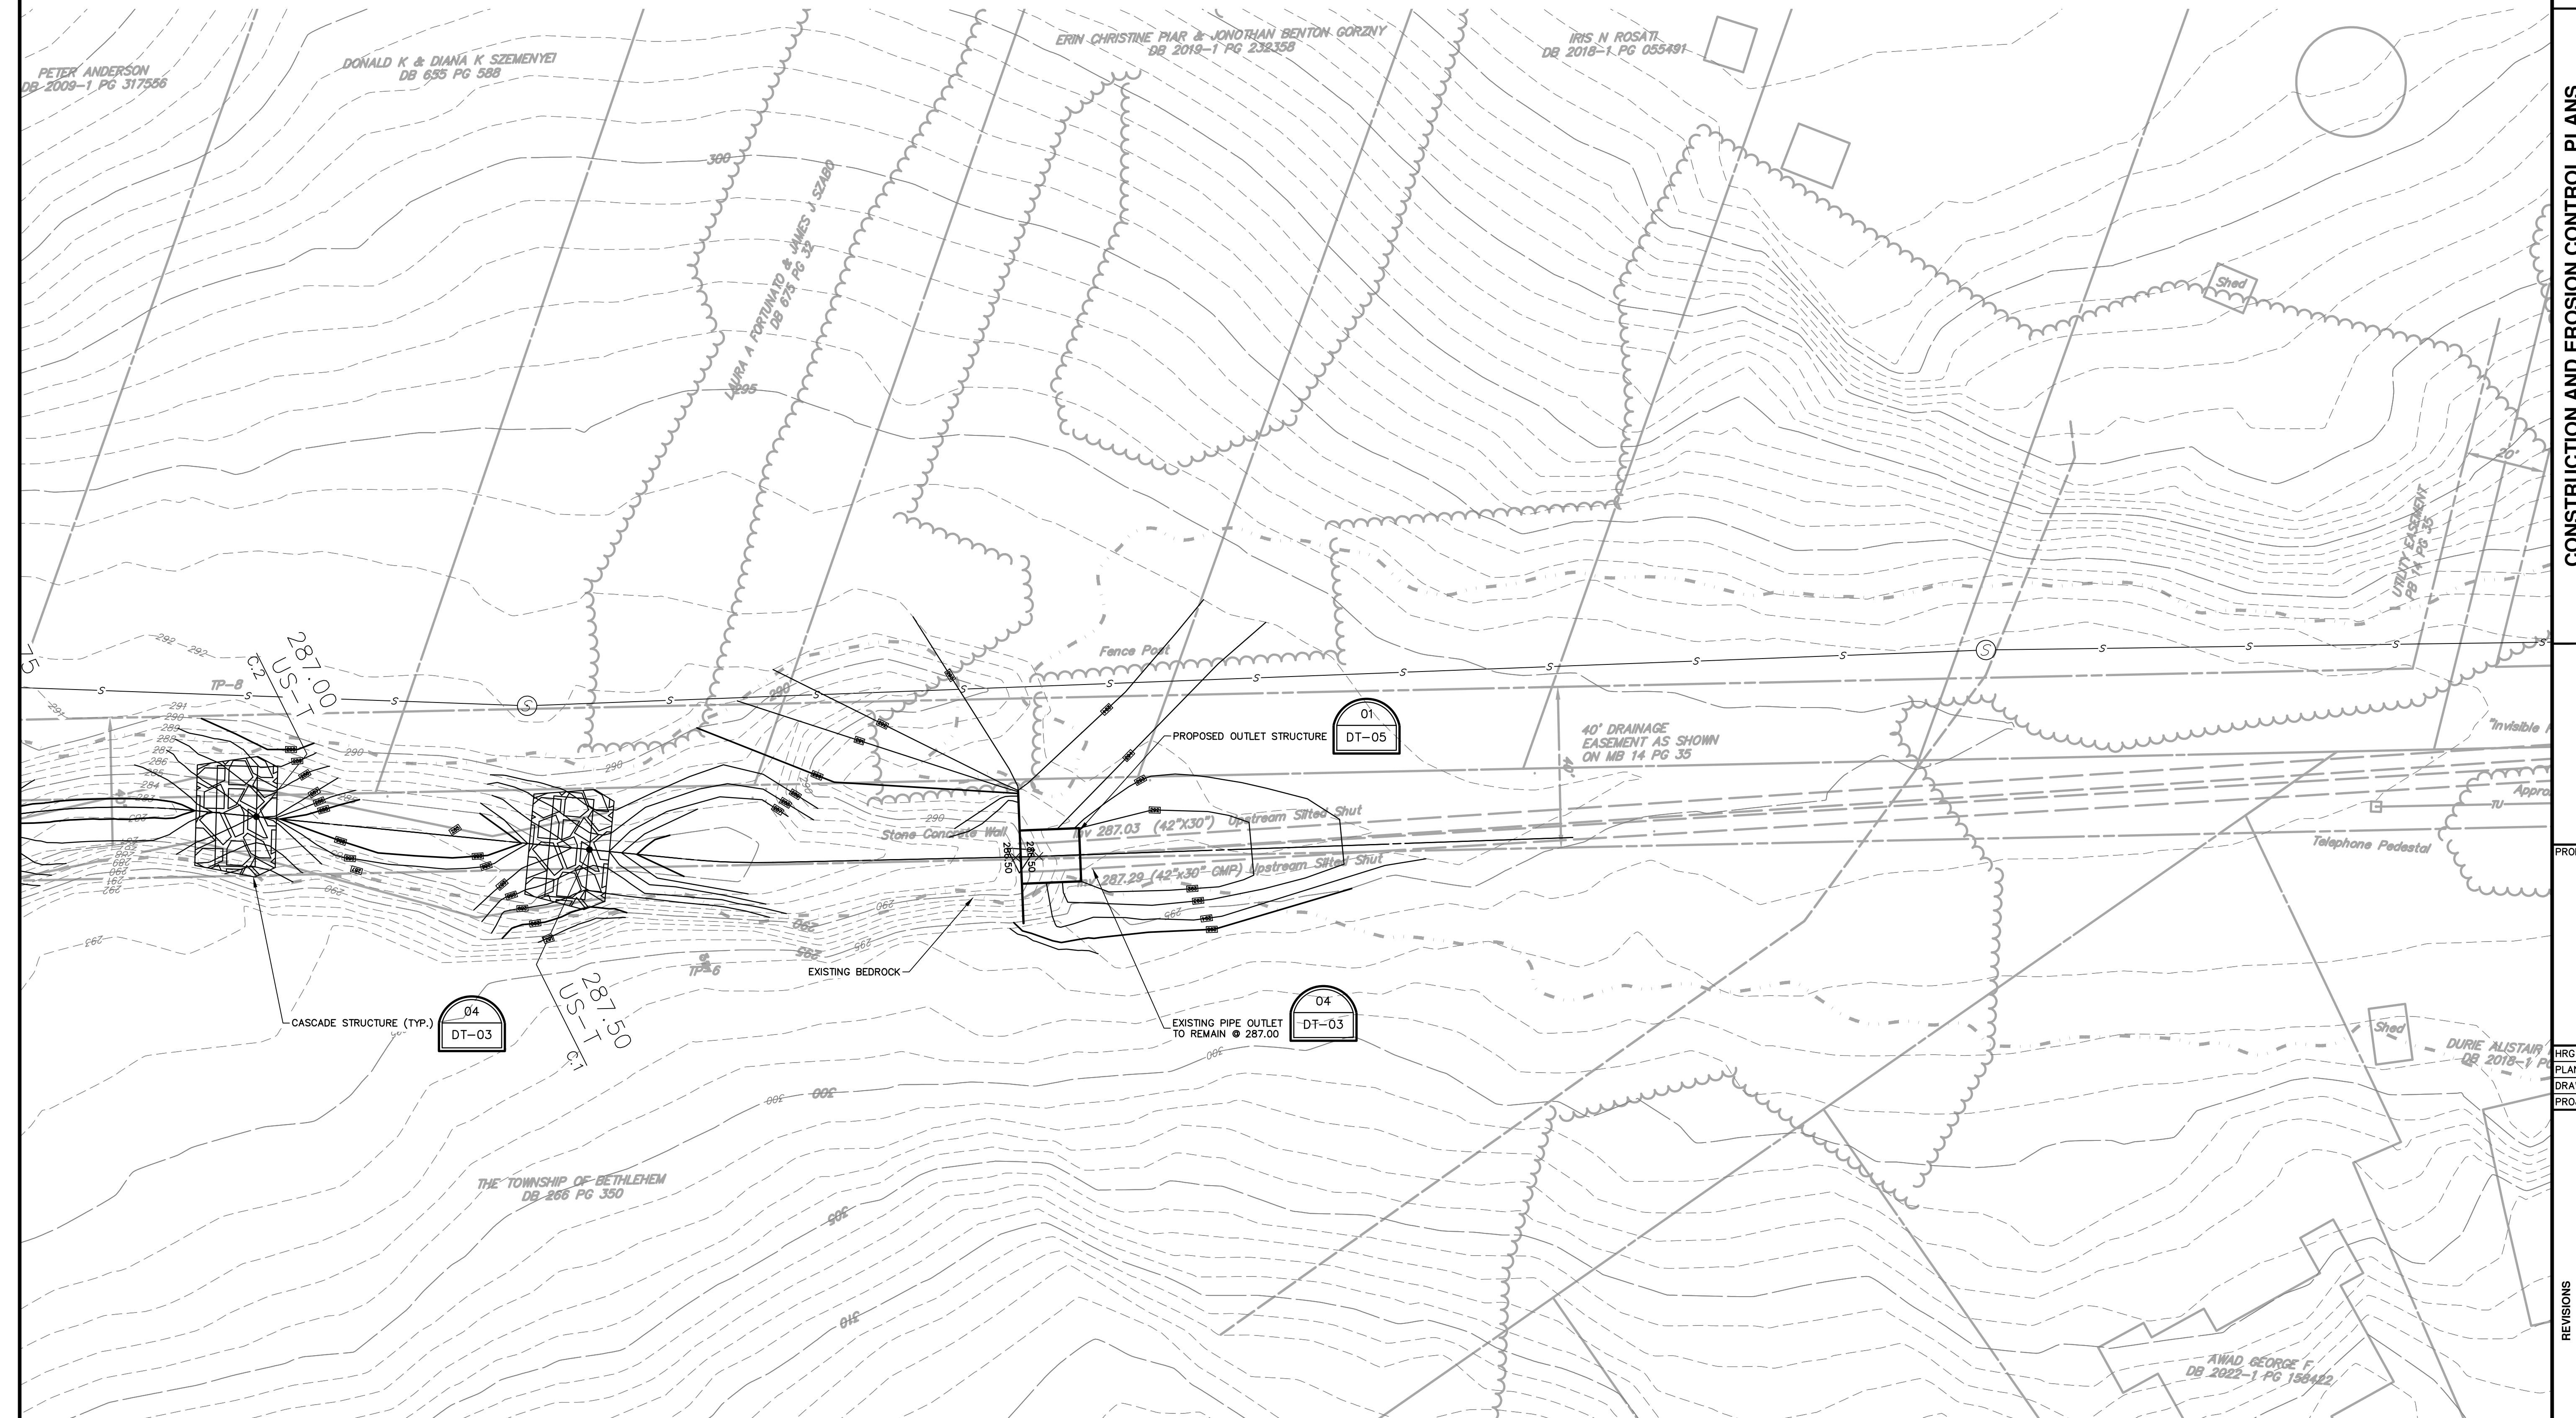
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STREAM
RESTORATION
PLAN

FILE NAME: R009170.0431.DWG
LAST UPDATED: 10/29/2025 11:15 AM BY JON

SHEET: SR-05


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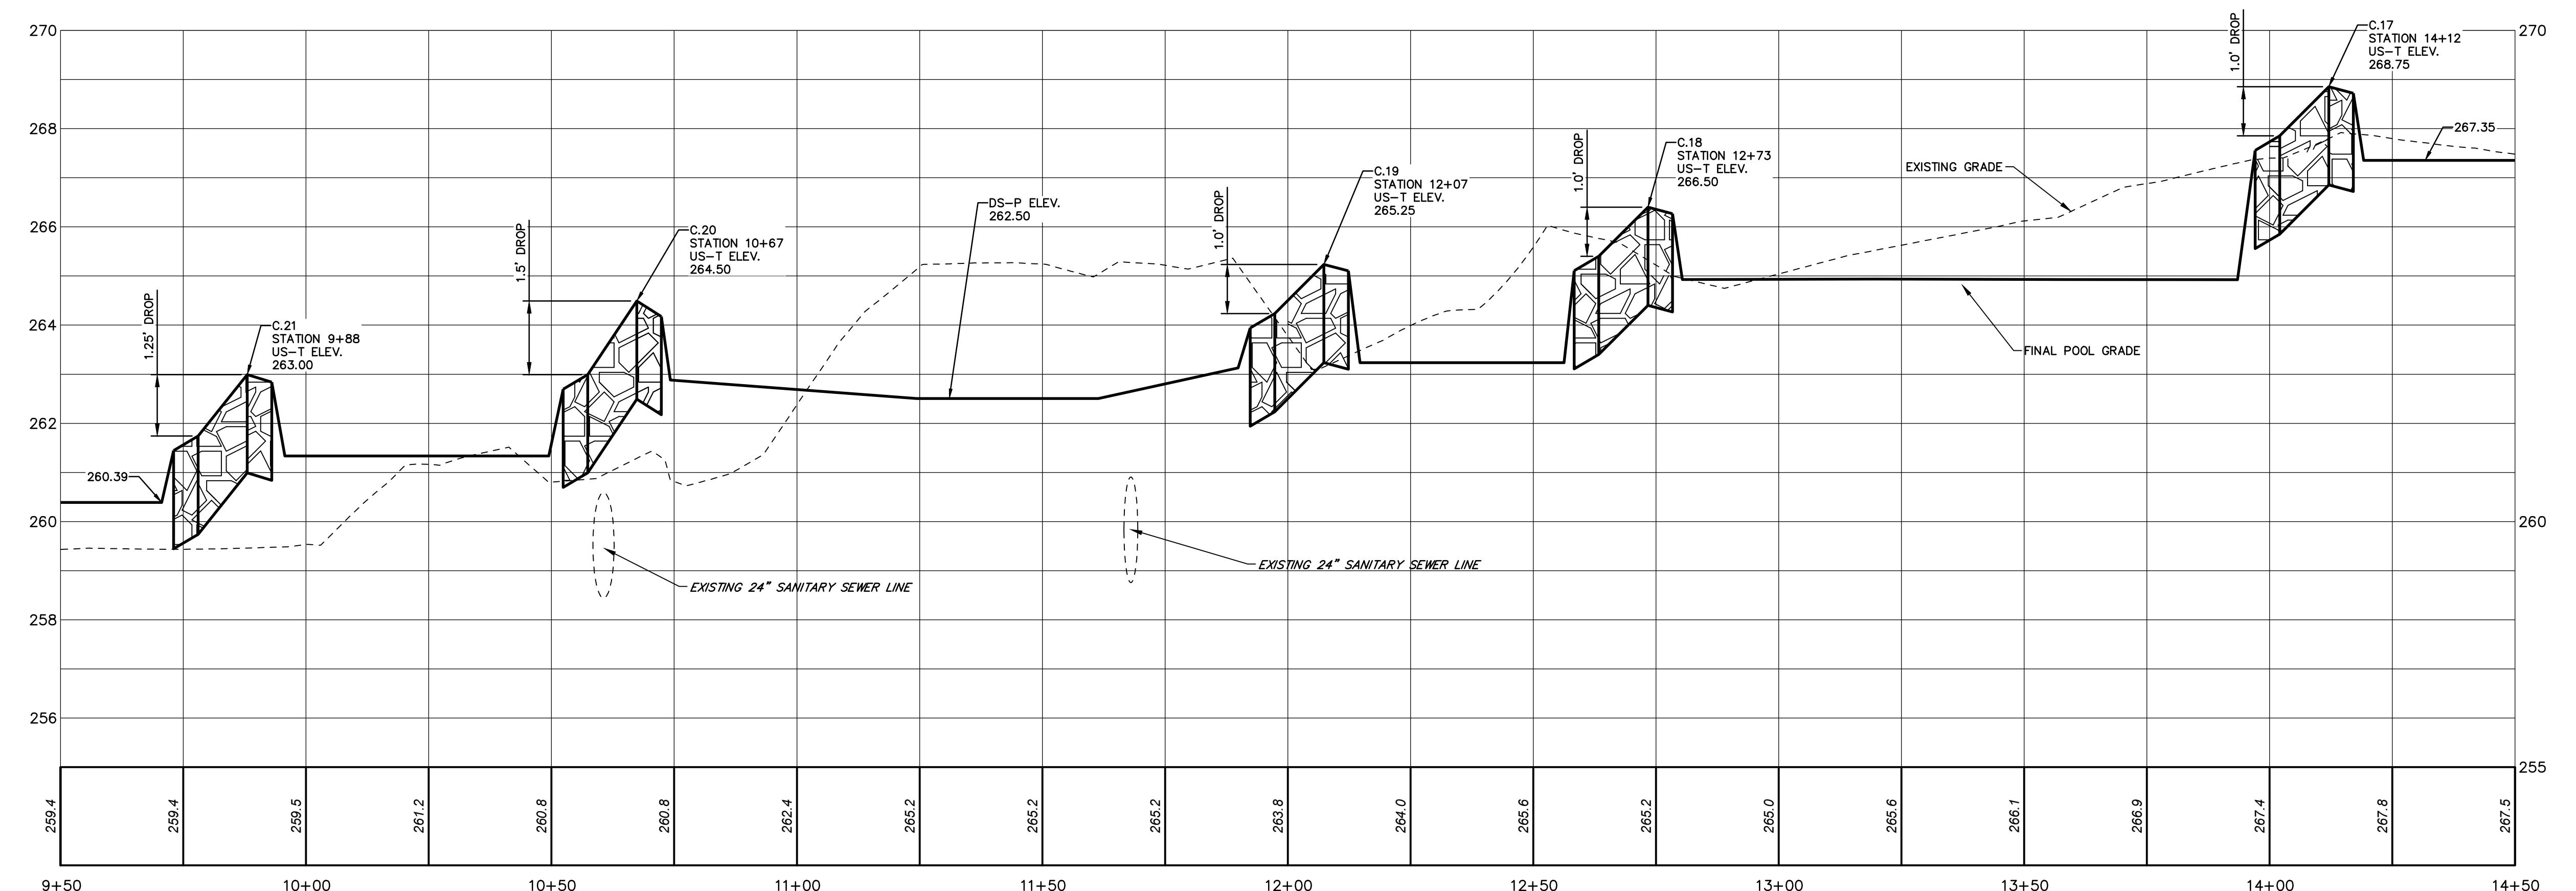


**CONSTRUCTION AND EROSION CONTROL PLANS
FOR
SCULAC ROAD STREAM RESTORATION**


BETHLEHEM TOWNSHIP MUNICIPAL AUTHORITY
BETHLEHEM, PA 18020

BETHLEHEM TOWNSHIP, NORTHAMPTON COUNTY, PENNSYLVANIA



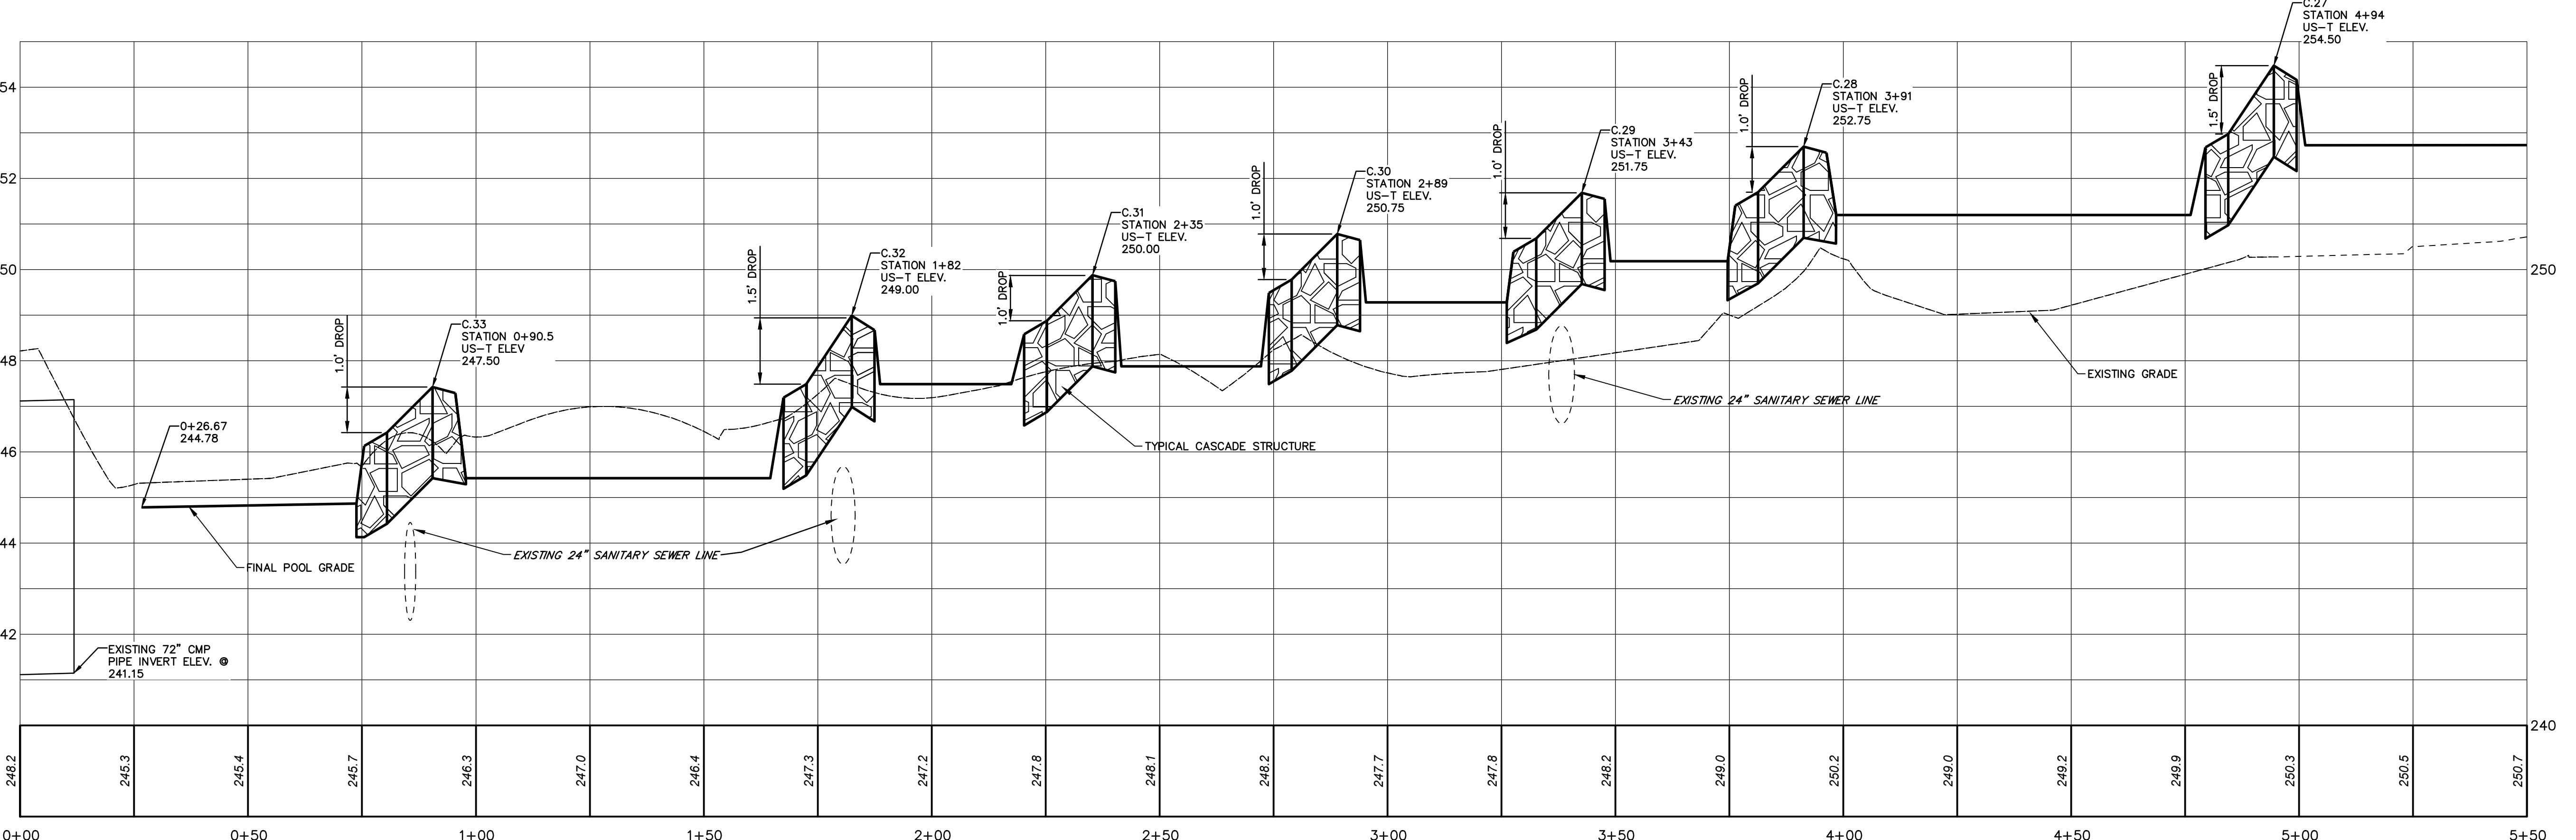

PROPOSED STREAM PROFILE 09+50 TO 14+50

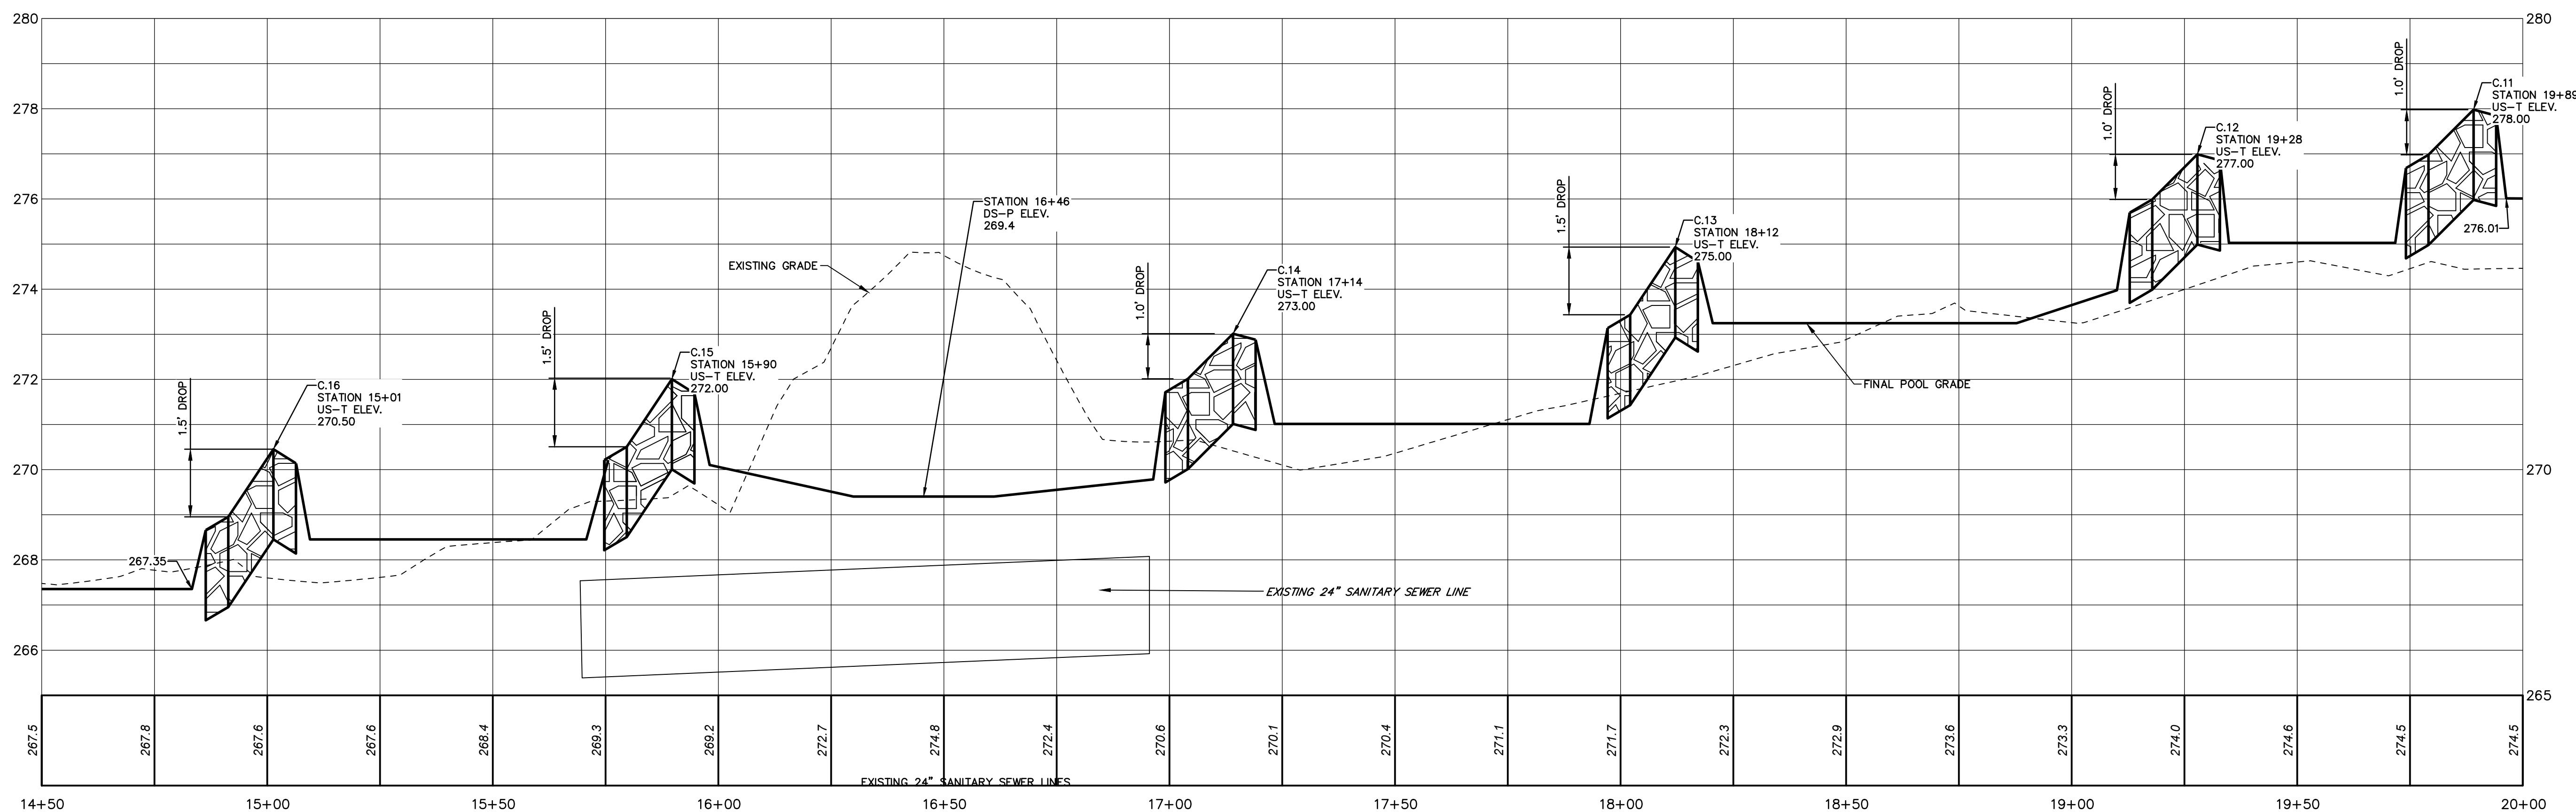


PROFILE VIEW SCALE

HORIZ: 30' 15' 0' 30'
VERT: 6' 3' 0' 6'
SCALE IN FEET

PROPOSED STREAM PROFILE 14+50 TO 20+00

**CONSTRUCTION AND EROSION CONTROL PLANS
FOR
SCULAC ROAD STREAM RESTORATION**

BETHLEHEM TOWNSHIP MUNICIPAL AUTHORITY
BETHLEHEM, PA 18020
NORTHAMPTON COUNTY, PENNSYLVANIA

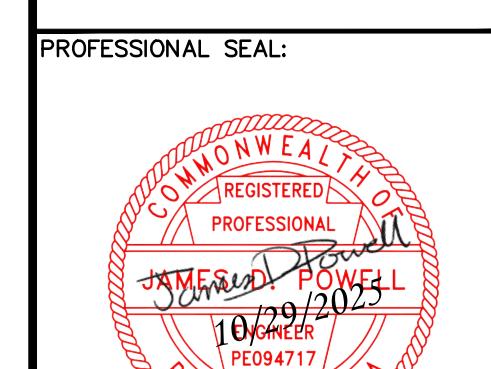


HRG PROJECT NUMBER: R009170.0431
PLAN DATE: FEBRUARY 2025
DRAWING SCALE: AS SHOWN
PROJ. MANAGER: MATTHEW VANASKE

REVISIONS
NO. DATE DESCRIPTION
1 03/05/25 REVISED PER NCCD COMMENTS
2 10/01/25 REVISED PER CONSTRUCTIONABILITY REVIEW
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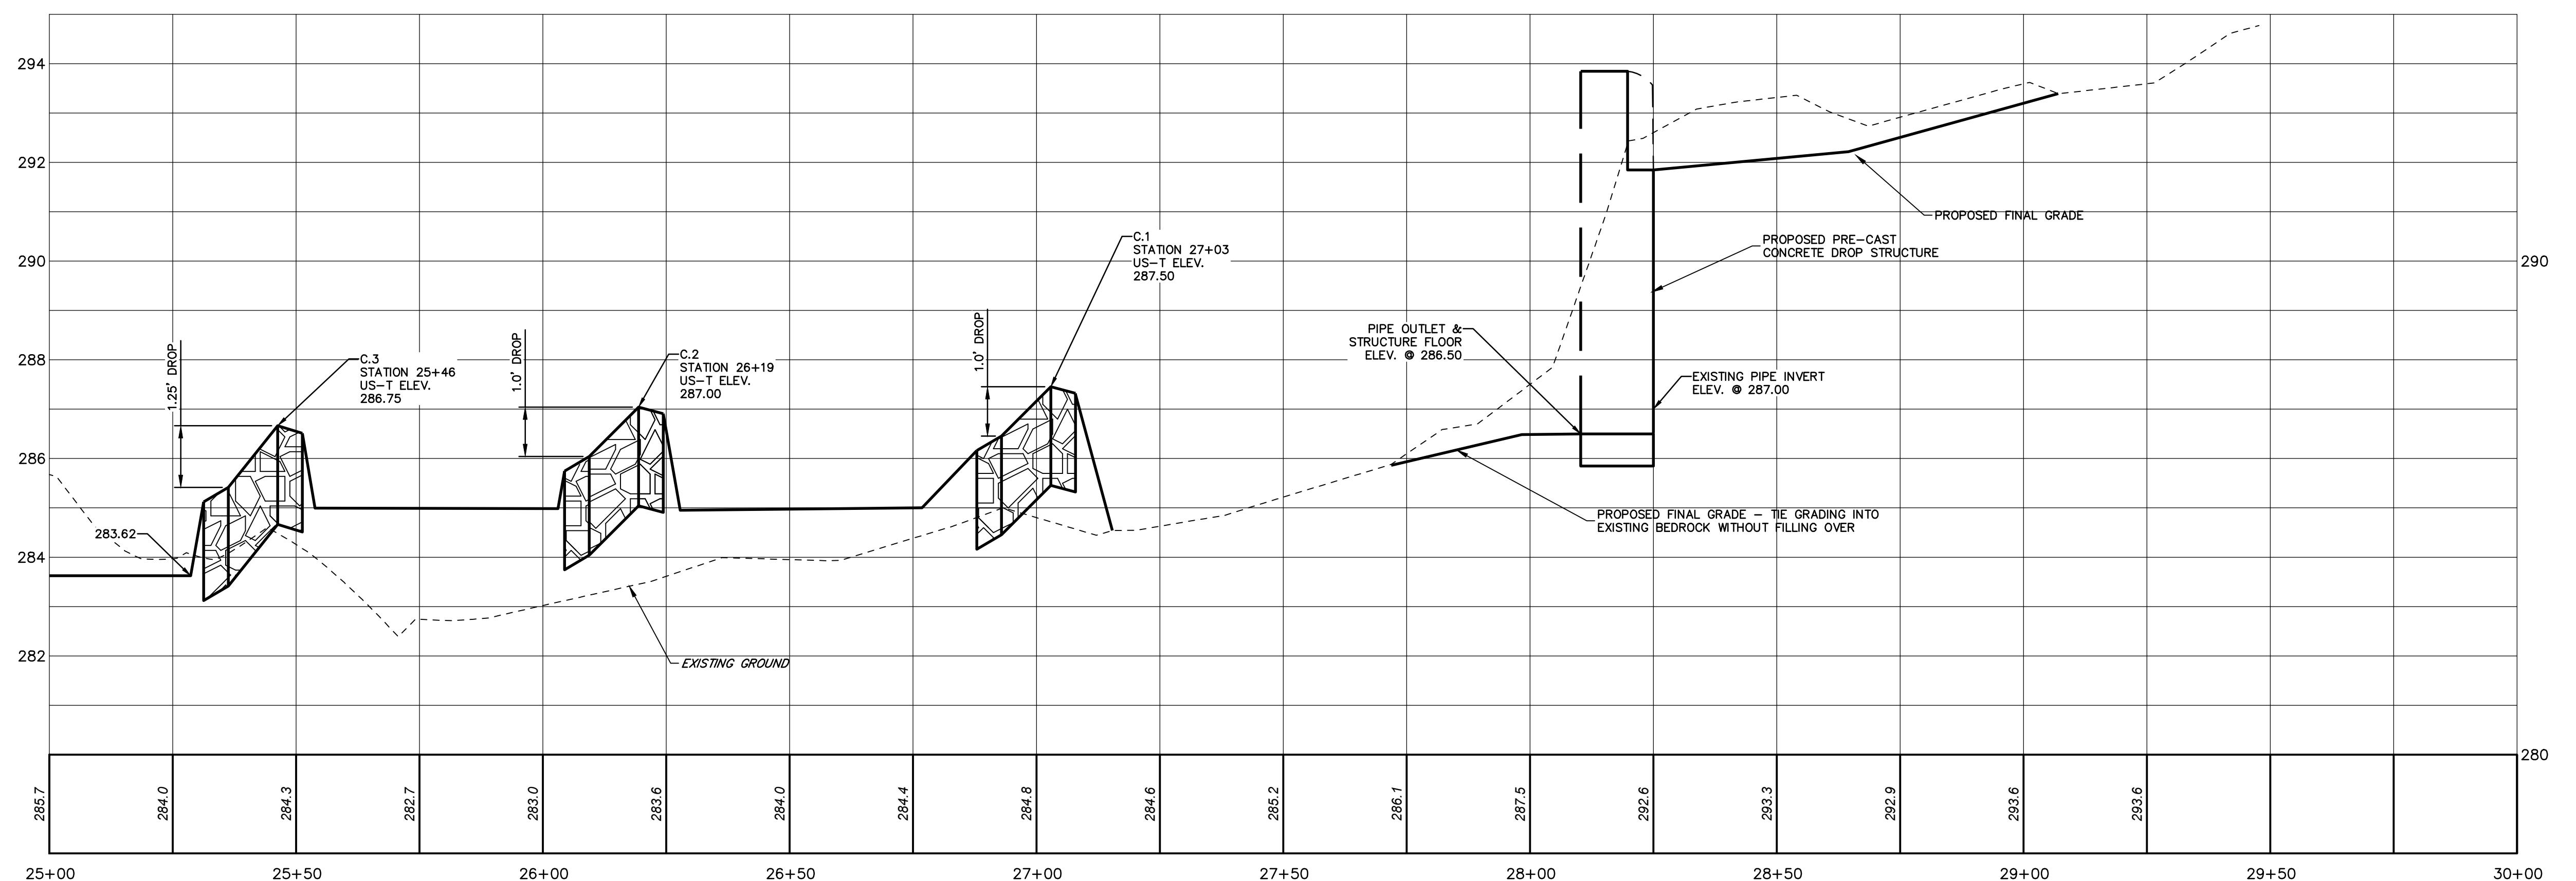
PROPOSED
STREAM
PROFILES
SHEET TITLE:
PR-02
FILE NAME: R009170.0431-PR-02.DWG
LAST MODIFIED: 10/29/2025 11:30 AM
FILE SIZE: 2.00 MB

**CONSTRUCTION AND EROSION CONTROL PLANS
FOR
SCULAC ROAD STREAM RESTORATION**

BETHLEHEM TOWNSHIP MUNICIPAL AUTHORITY
BETHLEHEM, PA 18020
NORTHAMPTON COUNTY, PENNSYLVANIA

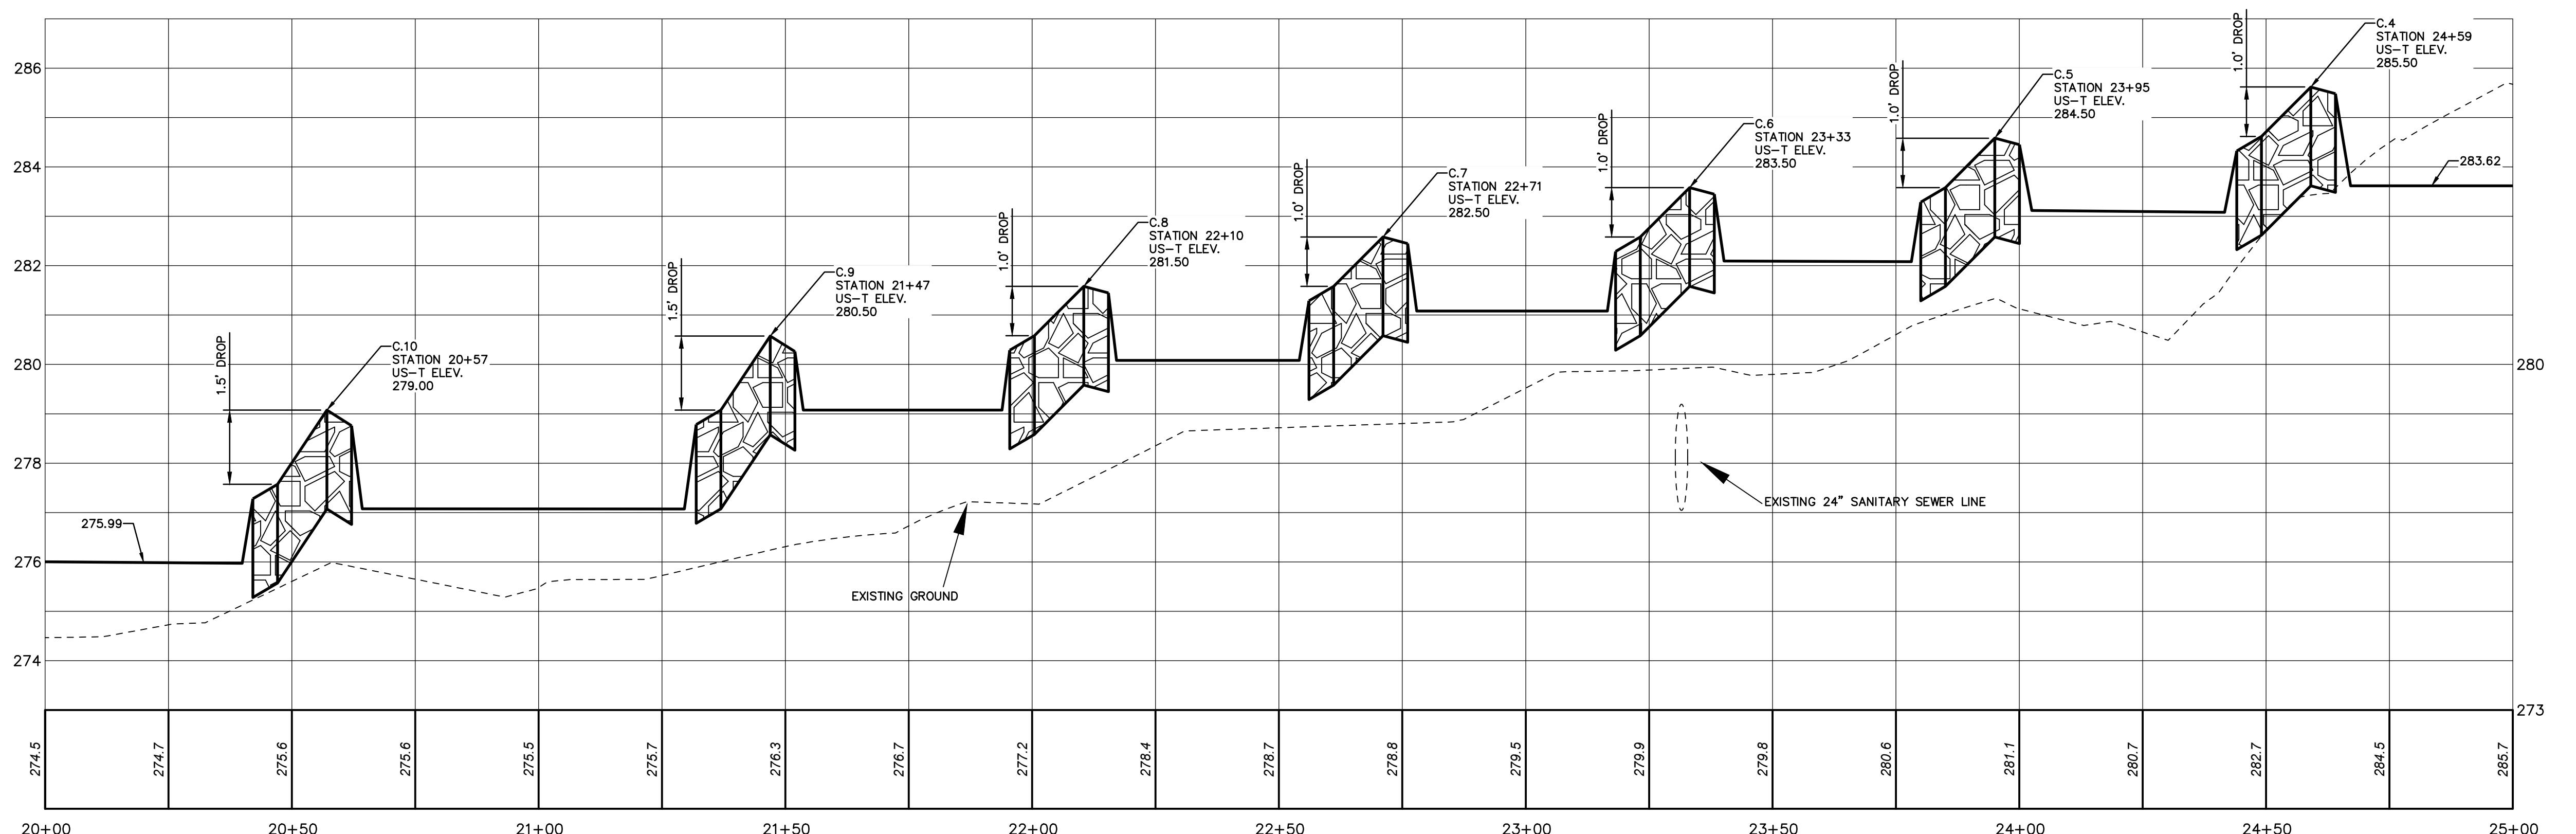


PROPOSED STREAM PROFILE 20+00 TO 25+00



PROPOSED STREAM PROFILE 25+00 TO 30+00

PROFILE VIEW SCALE

HORIZ: 30' 15' 0' 30'
VERT: 6' 3' 0' 6'
SCALE IN FEET

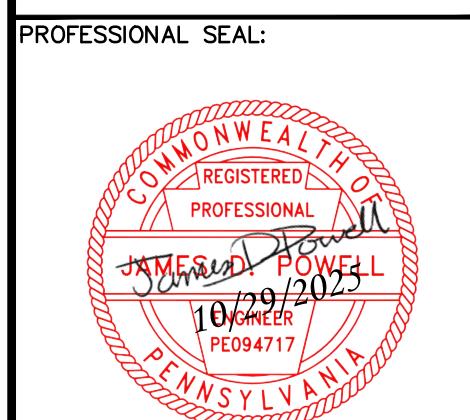

HRG PROJECT NUMBER: R009170.0431
PLAN DATE: FEBRUARY 2025
DRAWING SCALE: AS SHOWN
PROJ. MANAGER: MATTHEW VANASKE


REVISIONS
NO. DATE DESCRIPTION
1 03/05/2025 REVISED PER NCCD COMMENTS
2 10/01/2025 REVISED PER CONSTRUCTABILITY REVIEW
3
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PROPOSED STREAM PROFILES


SHEET: PR-03
17

SECTION AND EDITION ONE: LAND
FOR
SCULAC ROAD STREAM RESTORATION
BETHLEM TOWNSHIP MUNICIPAL AUTHORITY


BETHLEHEM, PA 18020
4223 EASTON AVENUE
NORTHAMPTON COUNTY
PENNSYLVANIA

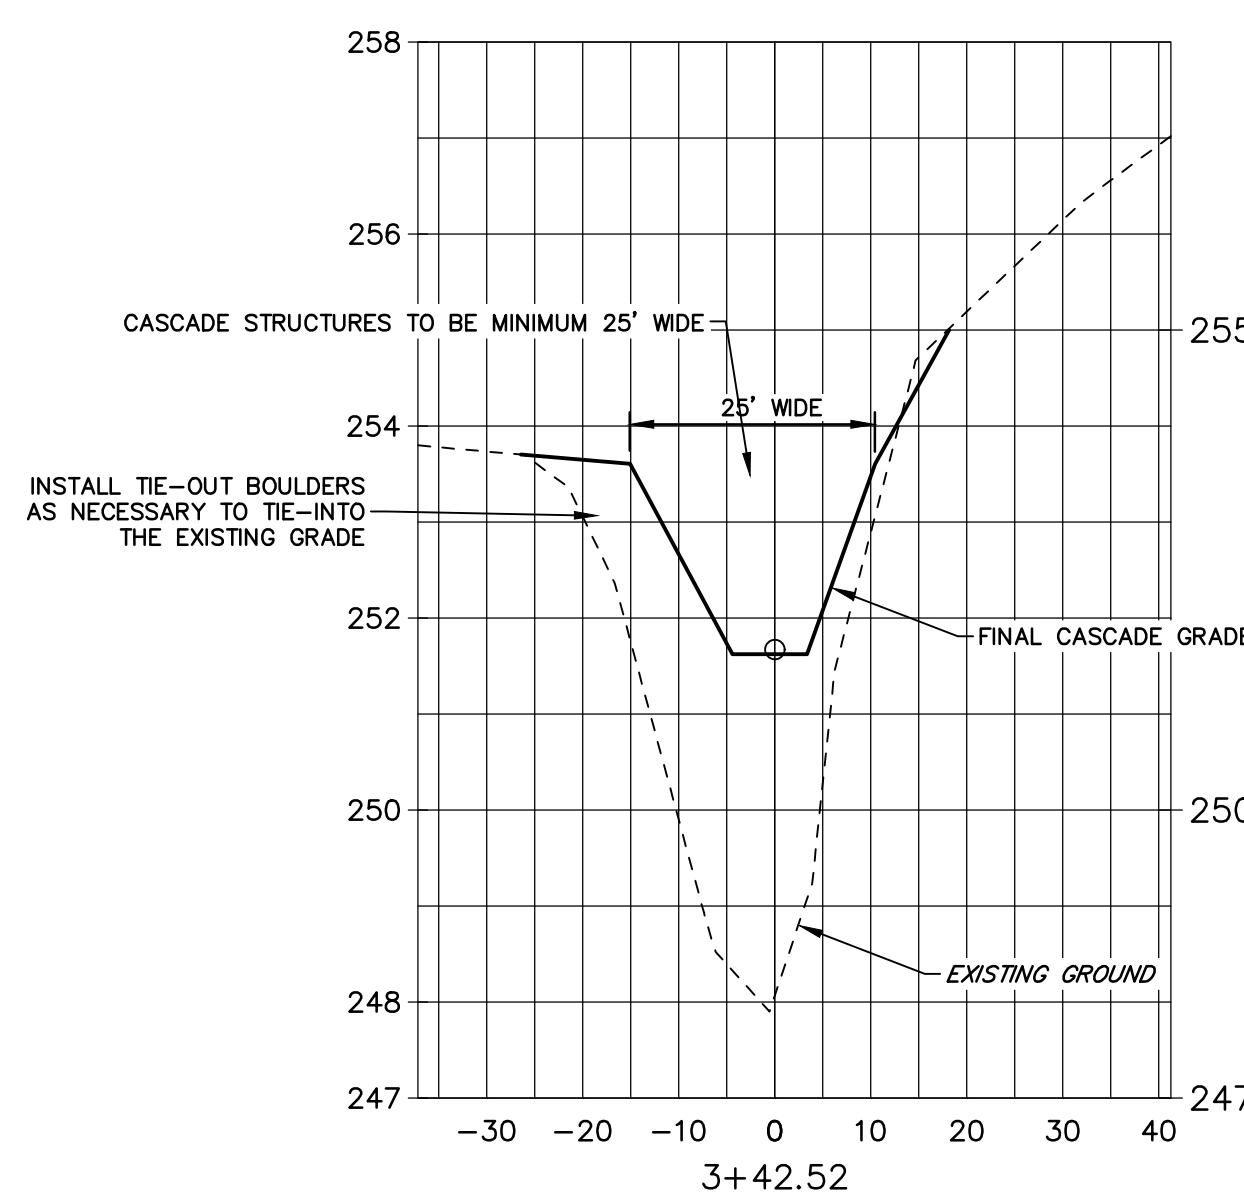


CROSS SECTION 1 - C.29

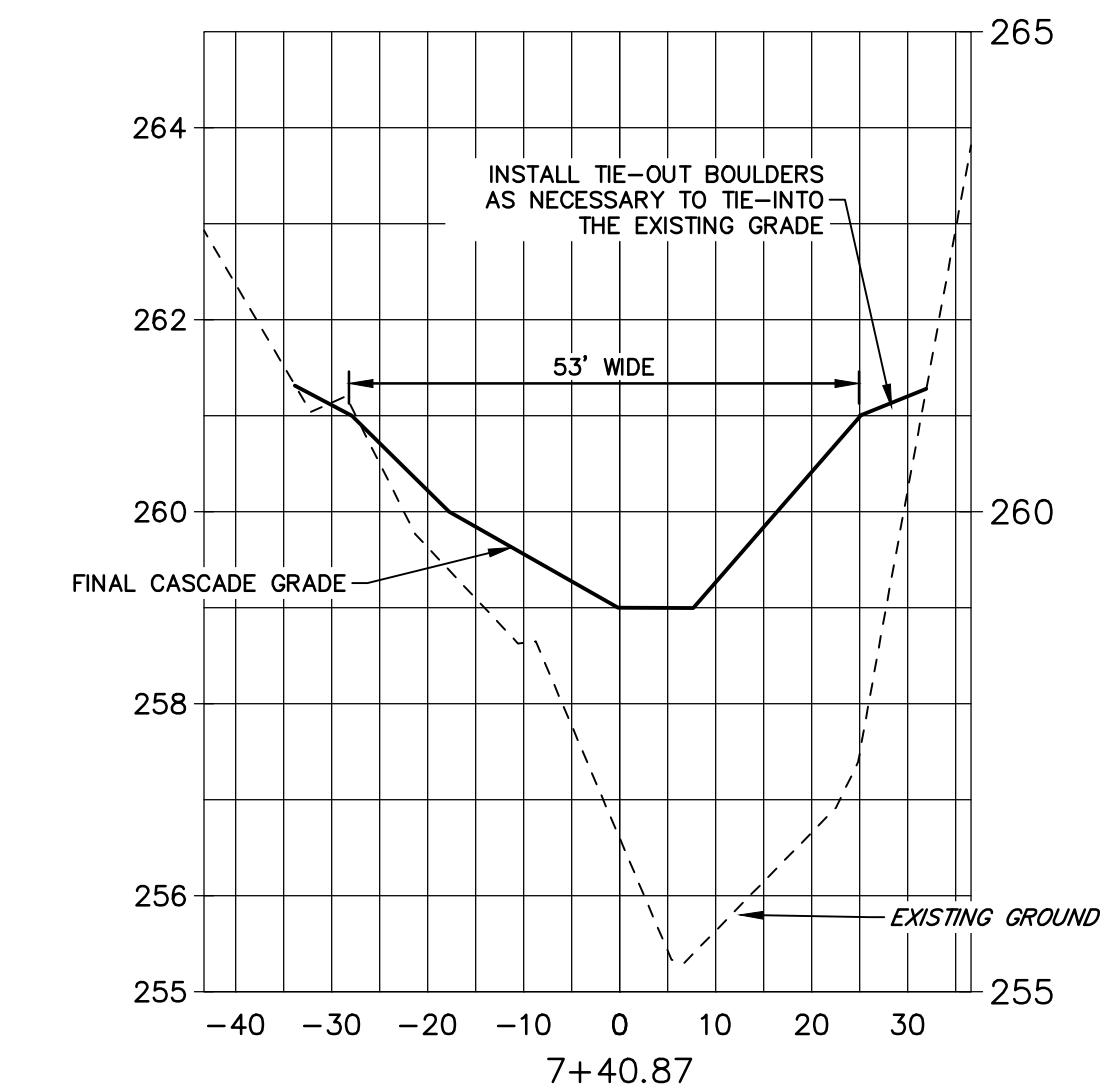

CROSS SECTION 2 - C.24

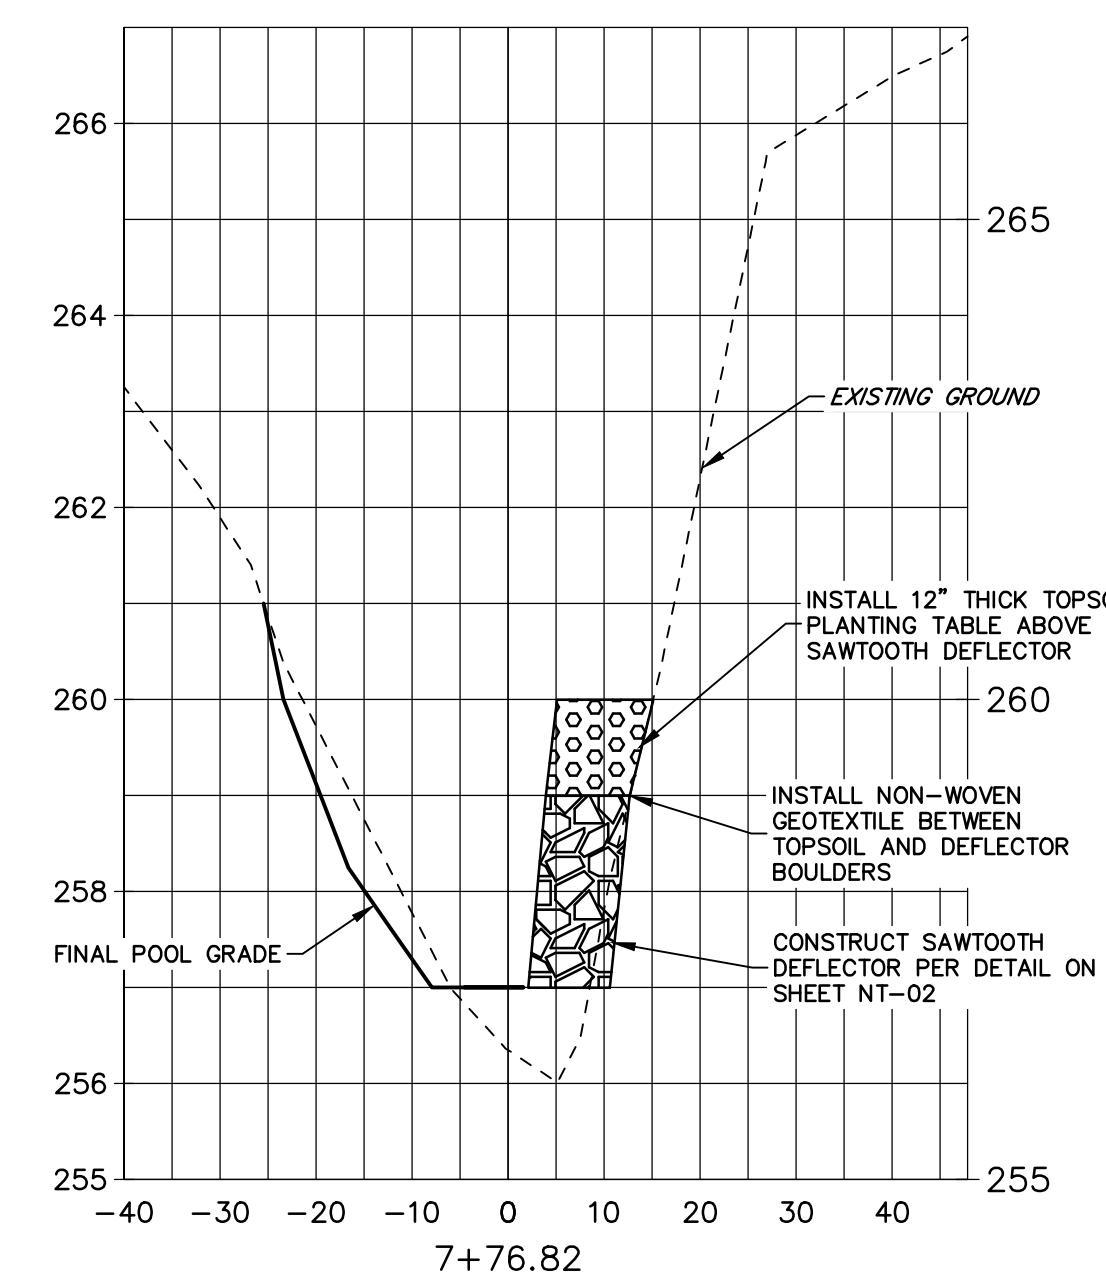


CROSS SECTION 3 - D.5

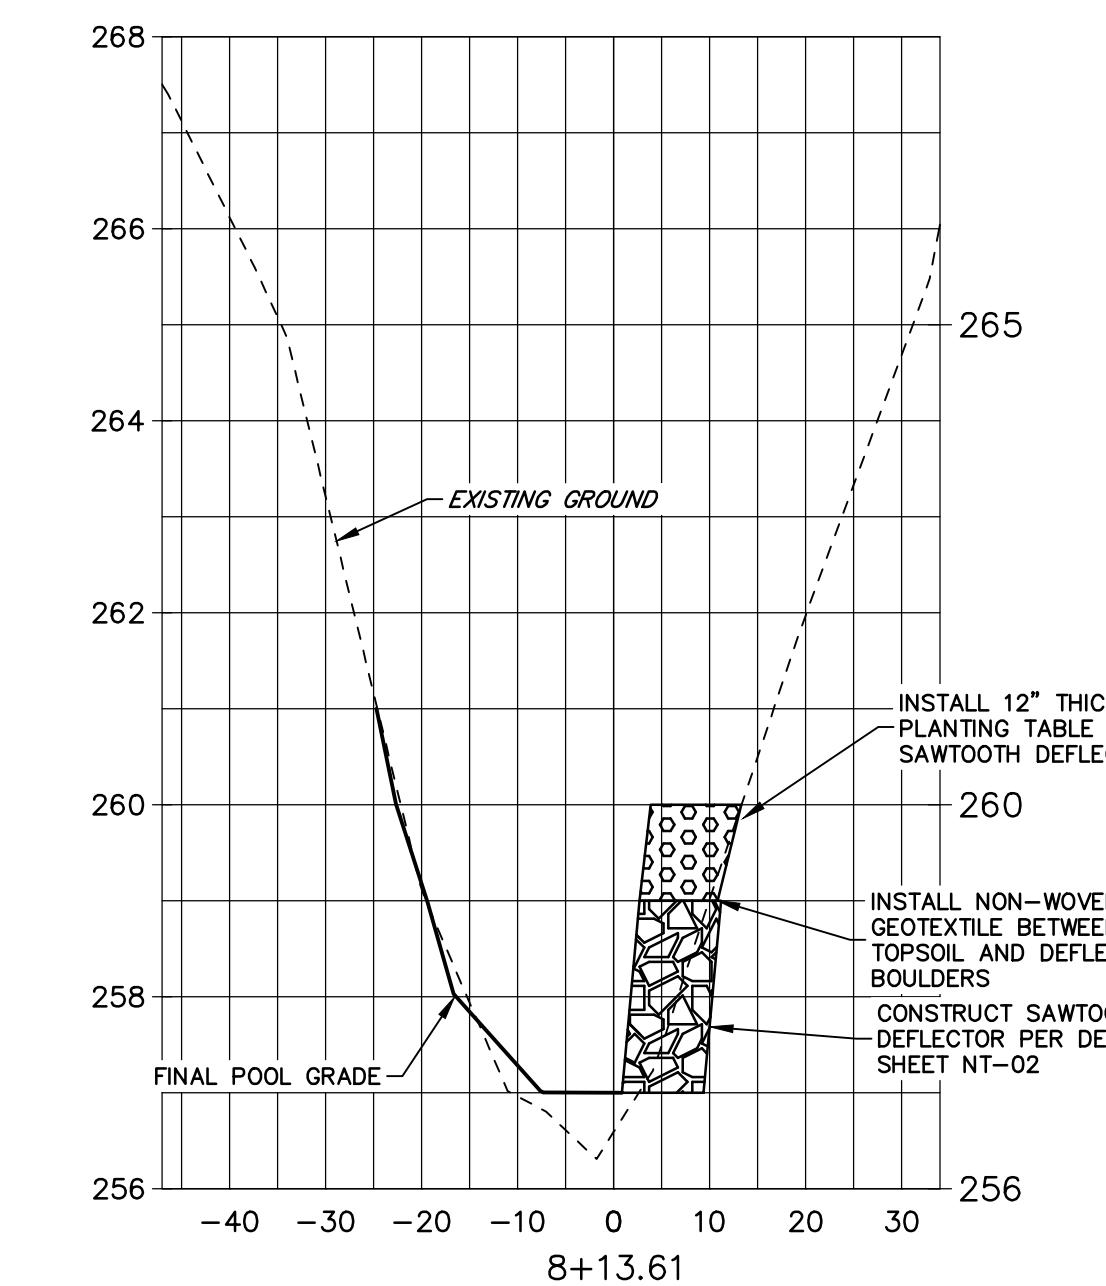


CROSS SECTION 4 - D.4


CONSTRUCT CASCADE STRUCTURES PER DETAIL ON SHEET DT-01. REFERENCE CASCADE STRUCTURE TABLE ON SHEET SR-OVR FOR DIMENSIONS OF EACH CASCADE WEIR.

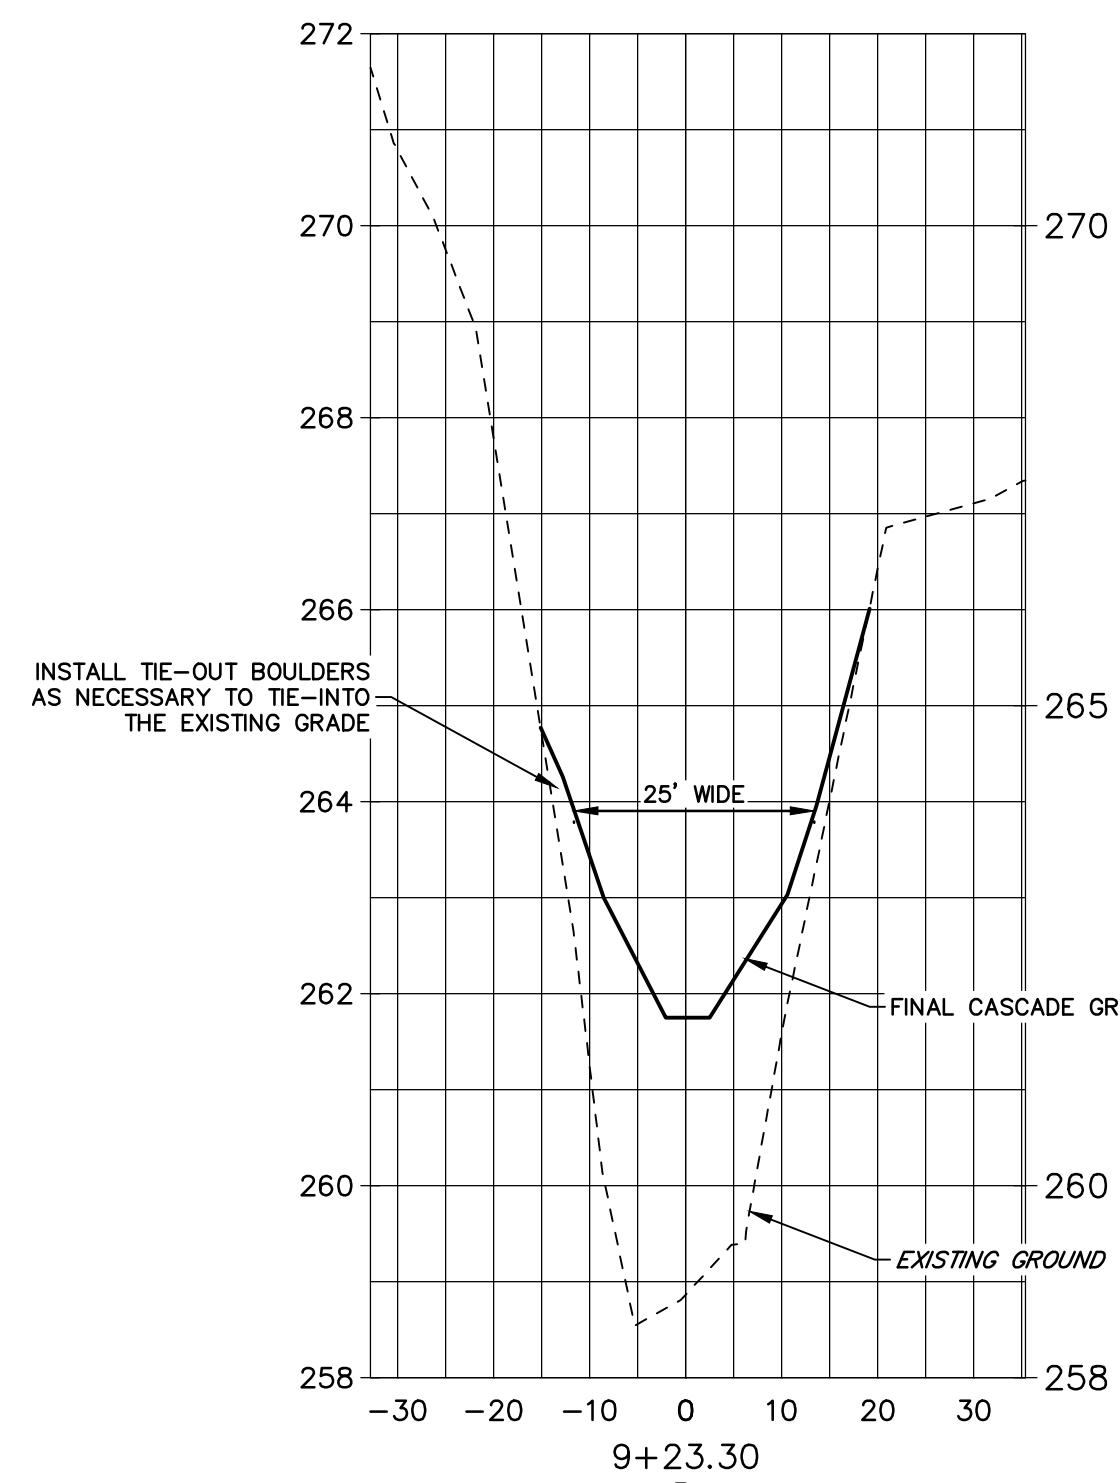


CROSS SECTION 5 - C.22

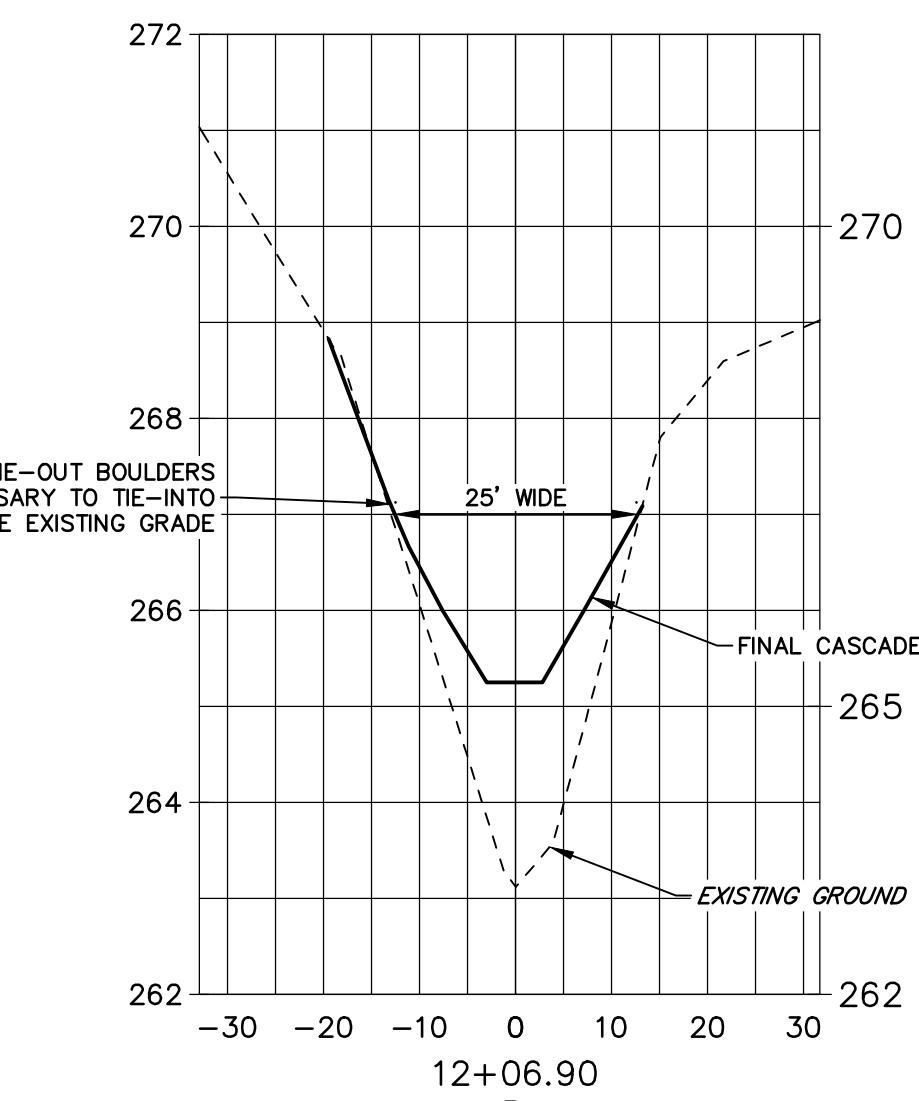

CROSS SECTION 6 - C.19

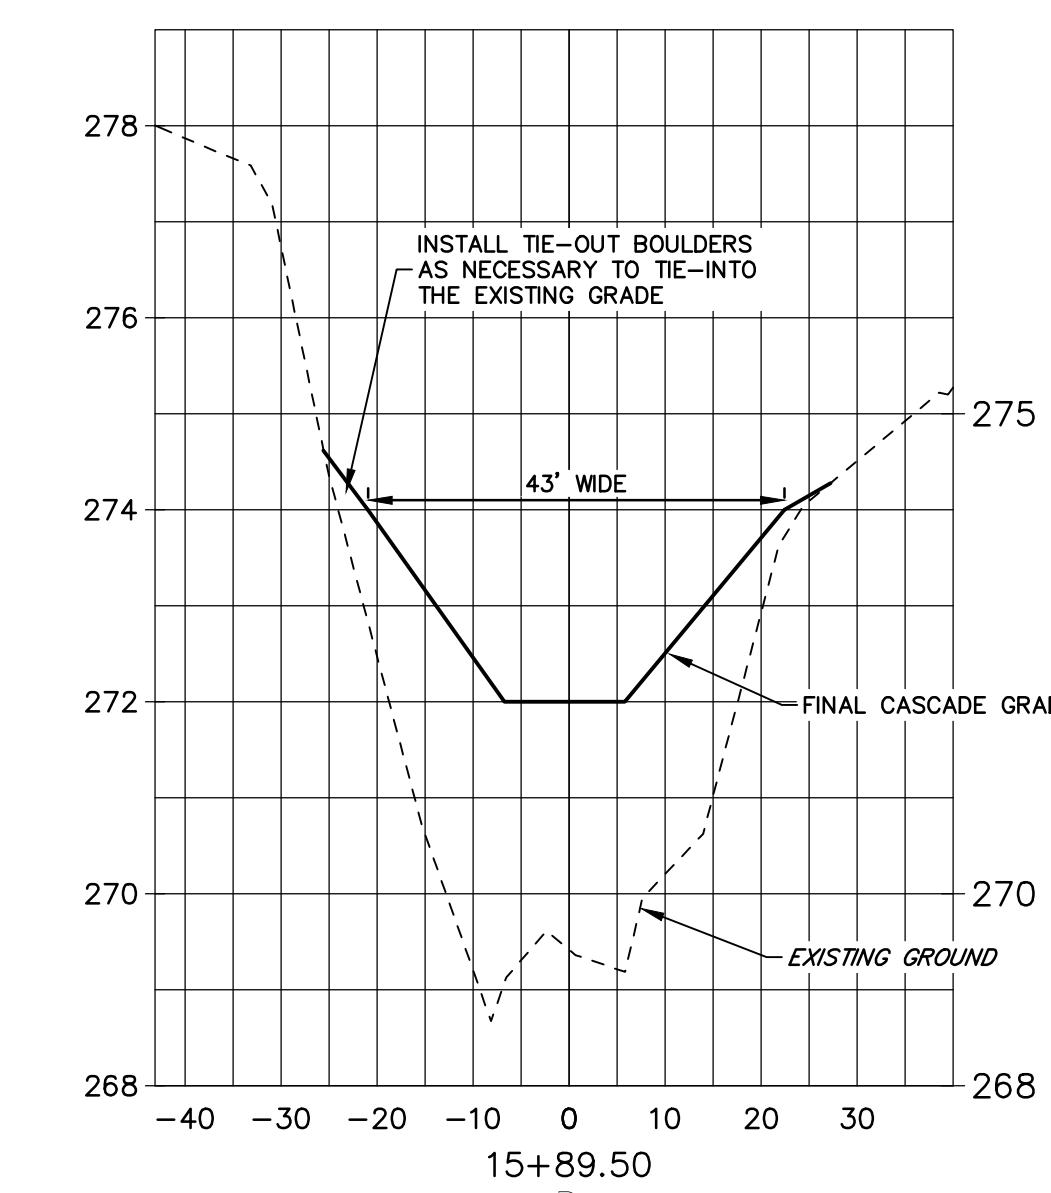

CROSS SECTION 7 - C.15

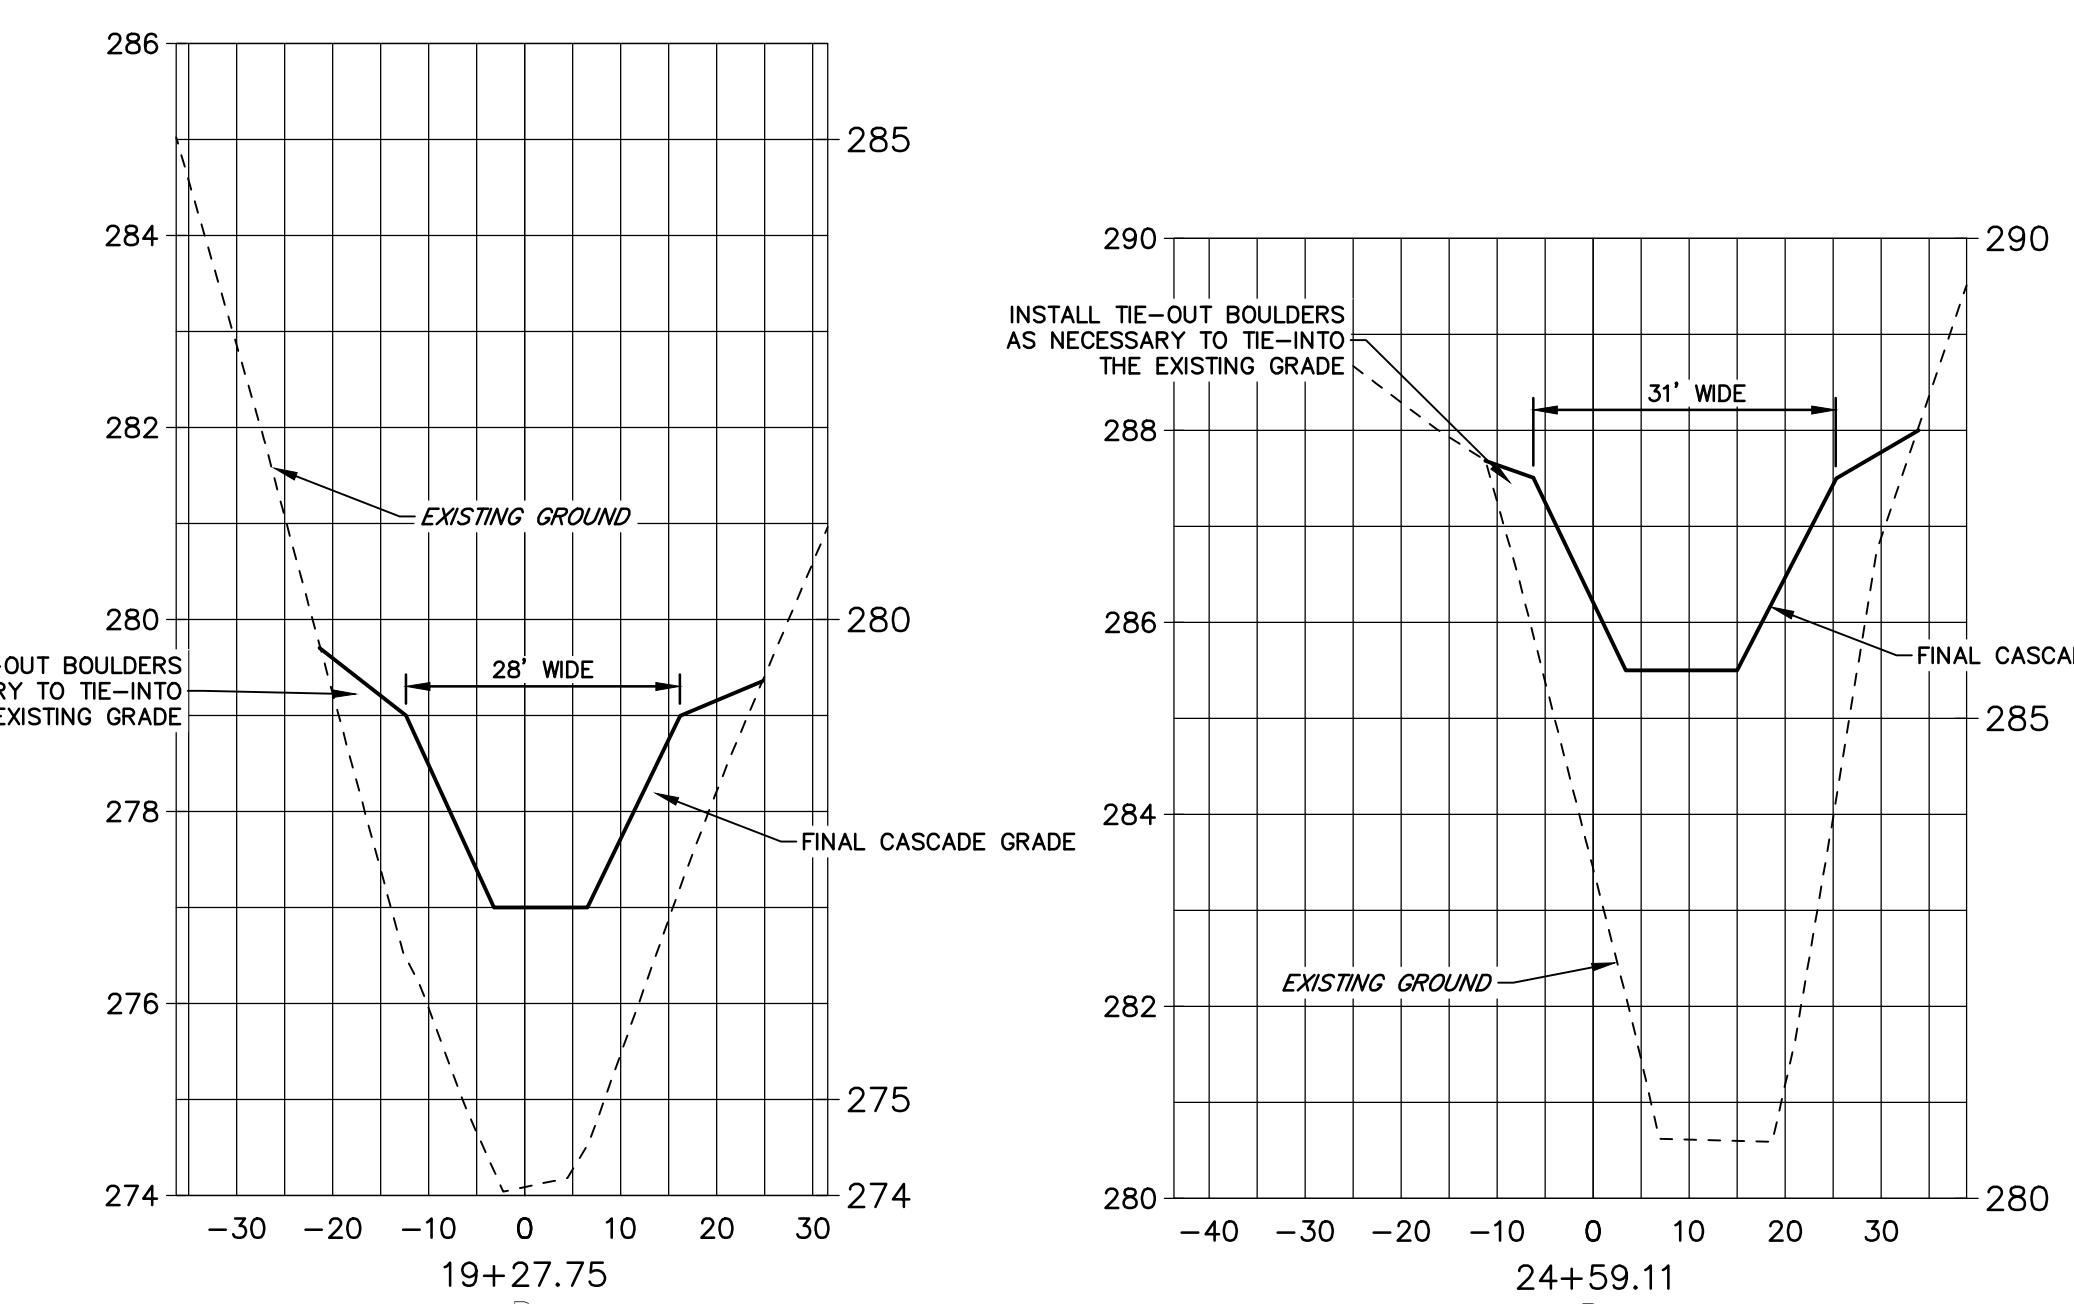

CROSS SECTION 9 - C.4

CROSS SECTION VIEW SCALE

A circular professional seal for James D. Powell, P.E. The seal features a rope-like outer border. The words "COMMONWEALTH OF PENNSYLVANIA" are written along the top inner edge, and "PROFESSIONAL" is written along the bottom inner edge. In the center, "REGISTERED" is written above "ENGINEER". Below "ENGINEER" is the date "10/29/2025". At the bottom, "PE094717" is printed. The name "JAMES D. POWELL" is written in a large, stylized, handwritten font across the center. The entire seal is rendered in red ink.

HRG PROJECT NUMBER:	R009170.043
PLAN DATE:	FEBRUARY 2024
DRAWING SCALE:	AS SHOWN
PROJ. MANAGER:	MATTHEW VANACKER

REVISIONS	DESCRIPTION	NCCD COMMENTS	CONSTRUCTABILITY REVIEW

SHEET TITLE:
**PROPOSED
STREAM CROSS
SECTIONS**

SHEET: **XS-01** 18

CONSTRUCTION AND EROSION CONTROL PLANS
FOR
SCULAC ROAD STREAM RESTORATION

4225 EASTON AVENUE
BETHLEHEM, PA 18020
BETHLEHEM TOWNSHIP, NORTHAMPTON COUNTY, PENNSYLVANIA

BETHLEHEM TOWNSHIP, NORTHAMPTON COUNTY, PENNSYLVANIA



HRG PROJECT NUMBER: R009170.0431
PLAN DATE: FEBRUARY 2025
DRAWING SCALE: AS SHOWN
PROJ. MANAGER: MATTHEW VANASKE

REVISIONS
DESCRIPTION


NO.	DATE	REVISIONS REVISED PER NCCD COMMENTS REVISED PER CONSTRUCTABILITY REVIEW
1	03/05/25	
2	10/29/25	
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IN-STREAM
STRUCTURE
DETAILS

IN-STREAM
STRUCTURE
DETAILS

DT-01

19

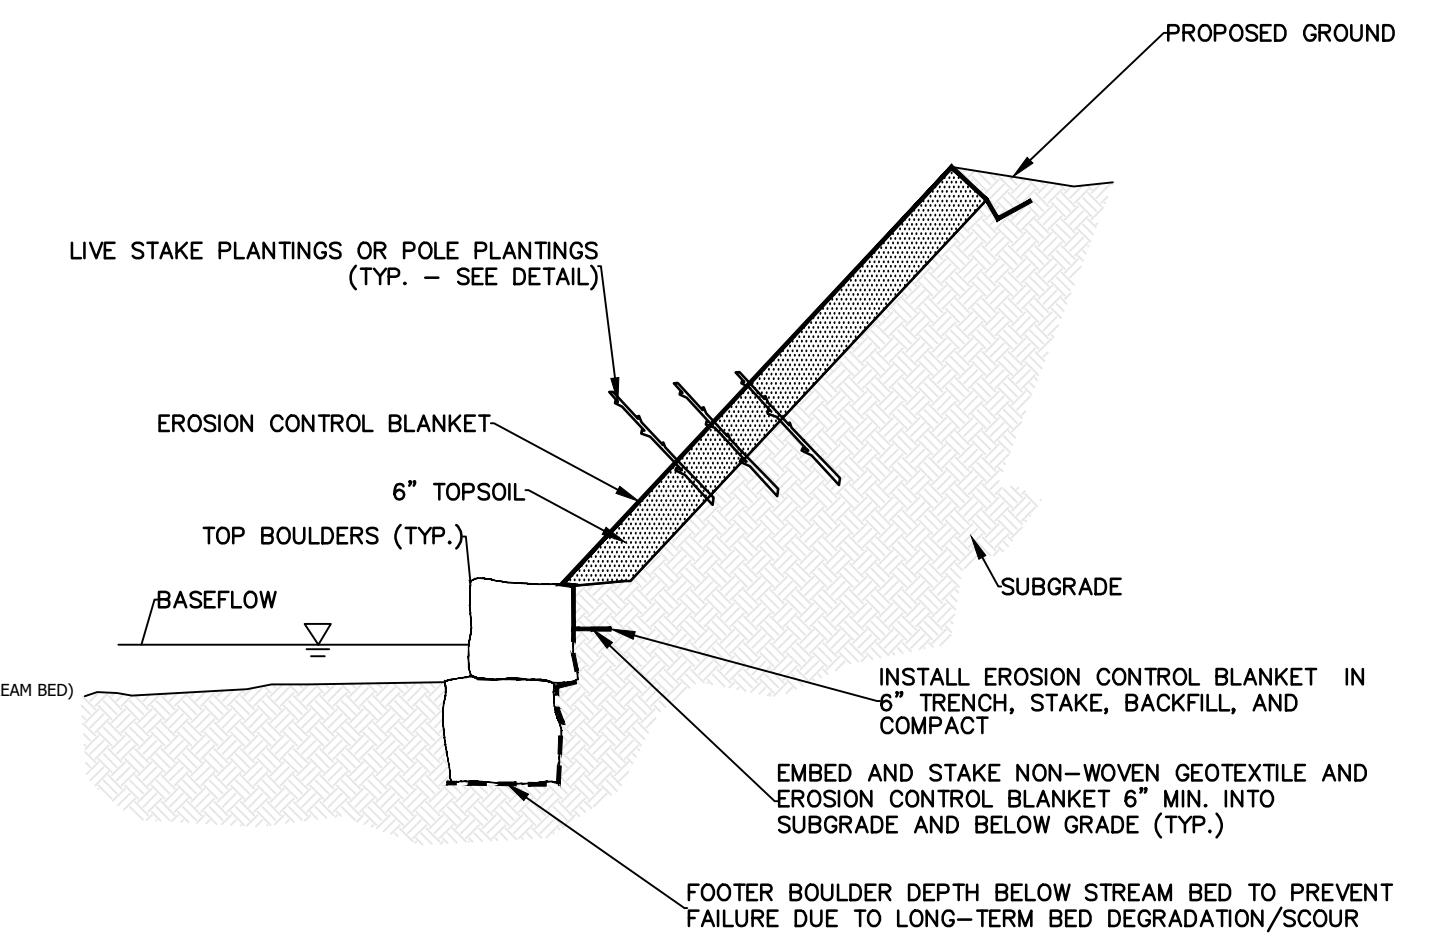


BENDWAY WEIR MATERIAL NOTES

1. GEOTEXTILE FABRIC SHALL BE A BLACK NON-WOVEN GEOTEXTILE COMPOSED OF POLYPROPYLENE FIBERS THAT MEET THE FOLLOWING SPECIFICATIONS:

MECHANICAL PROPERTIES	ASTM STANDARD
GRAB TENSILE STRENGTH	D 4632
GRAB TENSILE ELONGATION	D 4632
TRAPEZOID TEAR STRENGTH	D 4533
CBR PUNCTURE STRENGTH	D 6241
APPARENT OPENING SIZE	D 4751
PERMITTIVITY	D 4491
UV RESISTANCE	D 4491
UV RESISTANCE (AT 500 HOURS)	D 4355


2. STONE RIPRAP UTILIZED SHALL HAVE A MINIMUM SPECIFIC GRAVITY OF 2.5 ACCORDING TO AASHTO T85, Bulk Saturation, BUT SURFACE-DRY BASIS. GRADATIONS UTILIZED SHALL CONFORM TO NEN-1 PUBLICATION 408, SECTION B50.2(A).

3. SOIL STABILIZATION MATTING SHALL BE A BLACK, NON-WOVEN GEOTEXTILE CONSISTING OF MACHINE TWISTED TWINES AND BE 100 PERCENT BIODEGRADABLE. STABILIZATION MATTING SHALL BE RESISTANT TO THE TRACTIVE FORCES OF THE STREAM CHANNEL DURING HIGH FLOW EVENTS. STABILIZATION MATTING WHICH USES PLASTICS, METALS, OR OTHER MAN-MADE MATERIALS IN THE CONSTRUCTION OF THE MATERIAL WILL NOT BE PERMITTED. APPARENT OPENING SIZE SHALL BE SUFFICIENT TO FOSTER THE SPROUTING OF STABILIZATION/RESTORATION SEED MIXES.

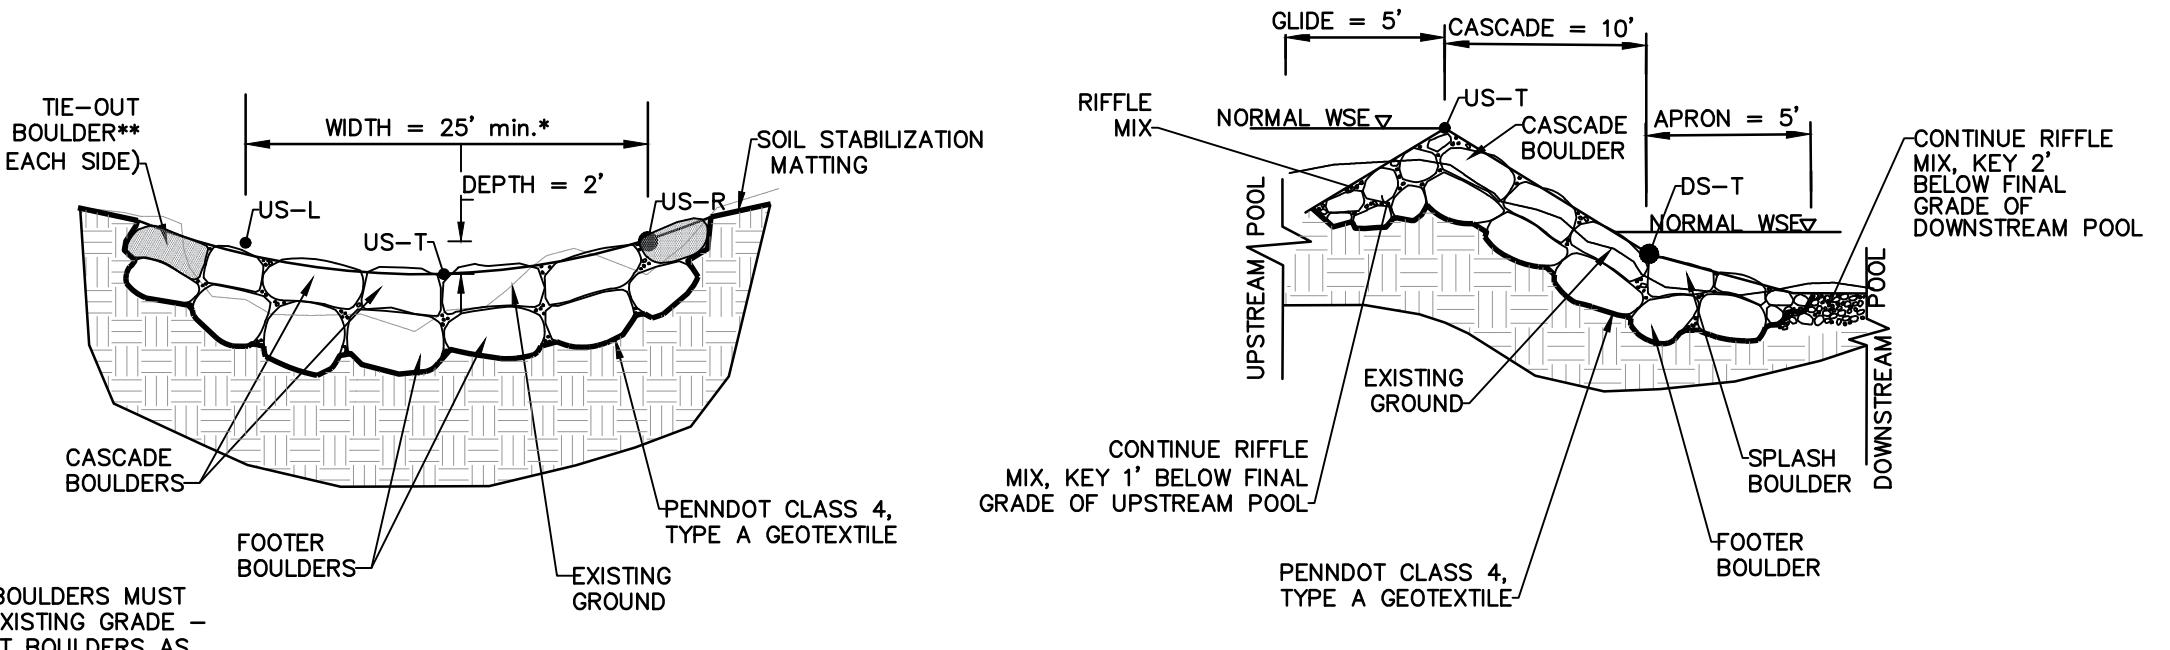


CASCADE CROSS SECTION - CUT
NOT TO SCALE


CASCADE CROSS PROFILE - CUT
NOT TO SCALE

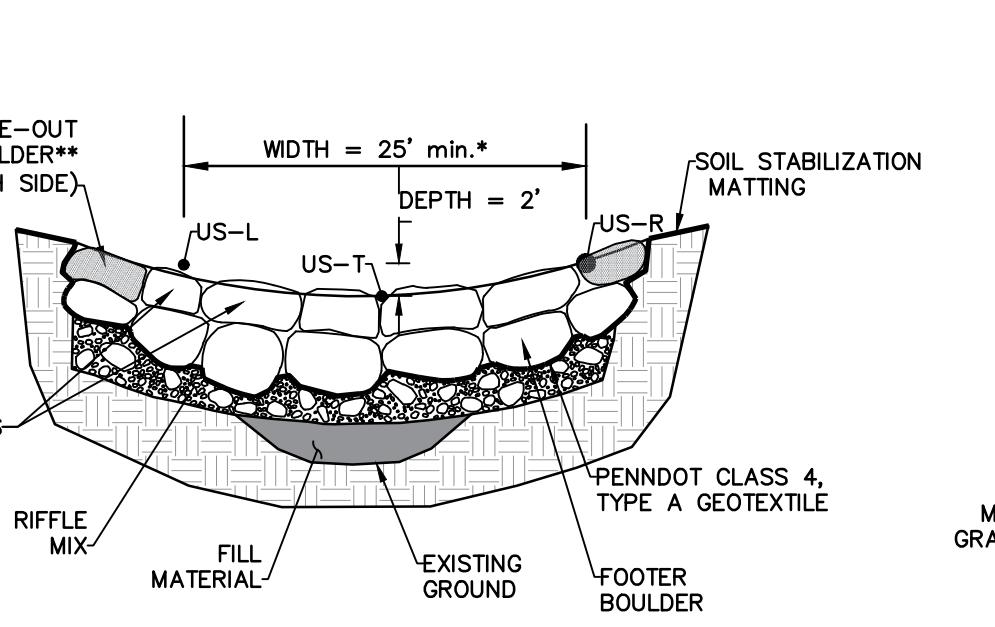


CASCADE CROSS SECTION - FILL
NOT TO SCALE

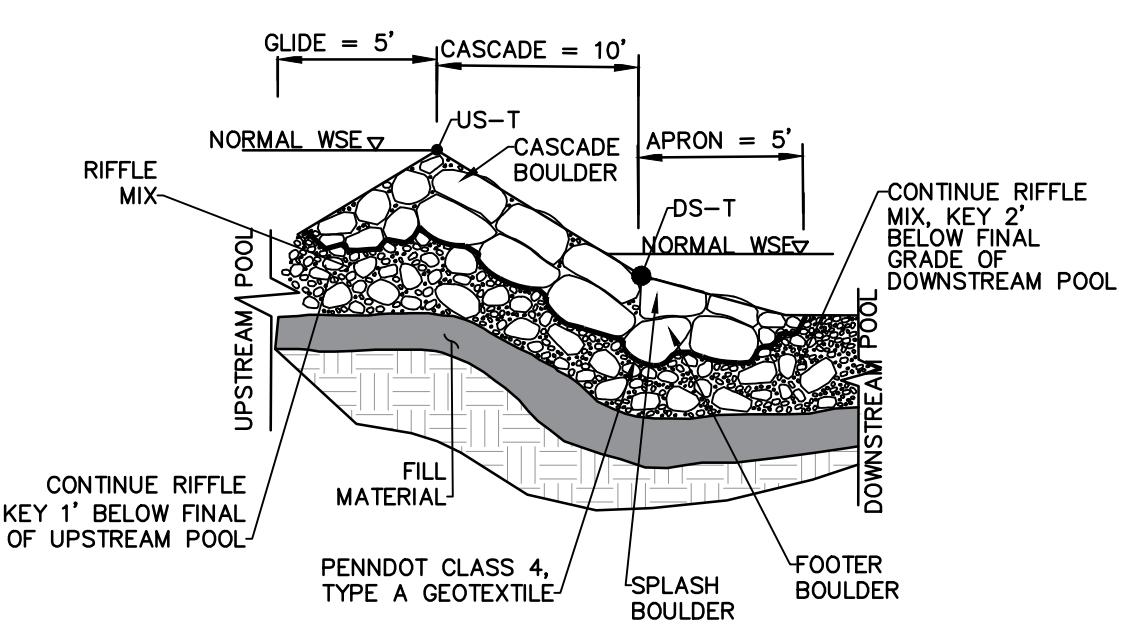


CASCADE CROSS PROFILE - FILL
NOT TO SCALE

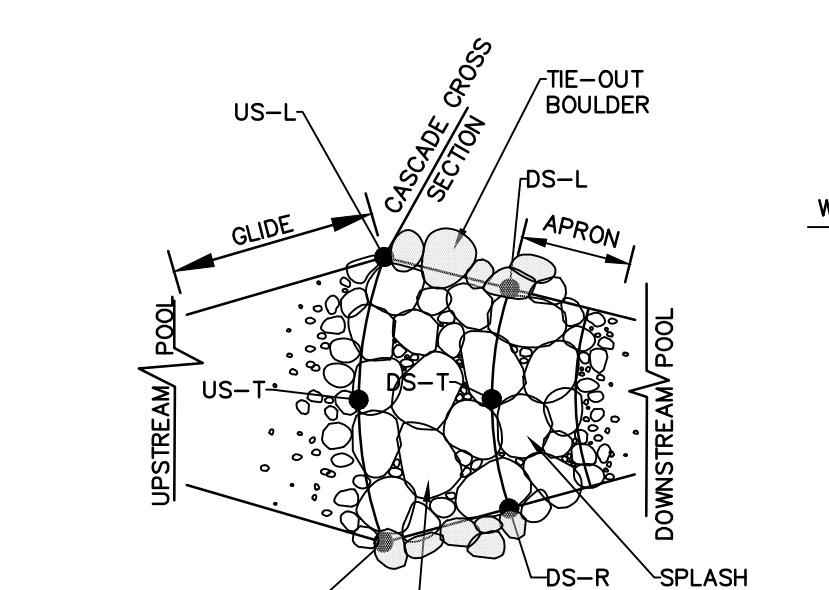

CASCADE PLAN VIEW
NOT TO SCALE

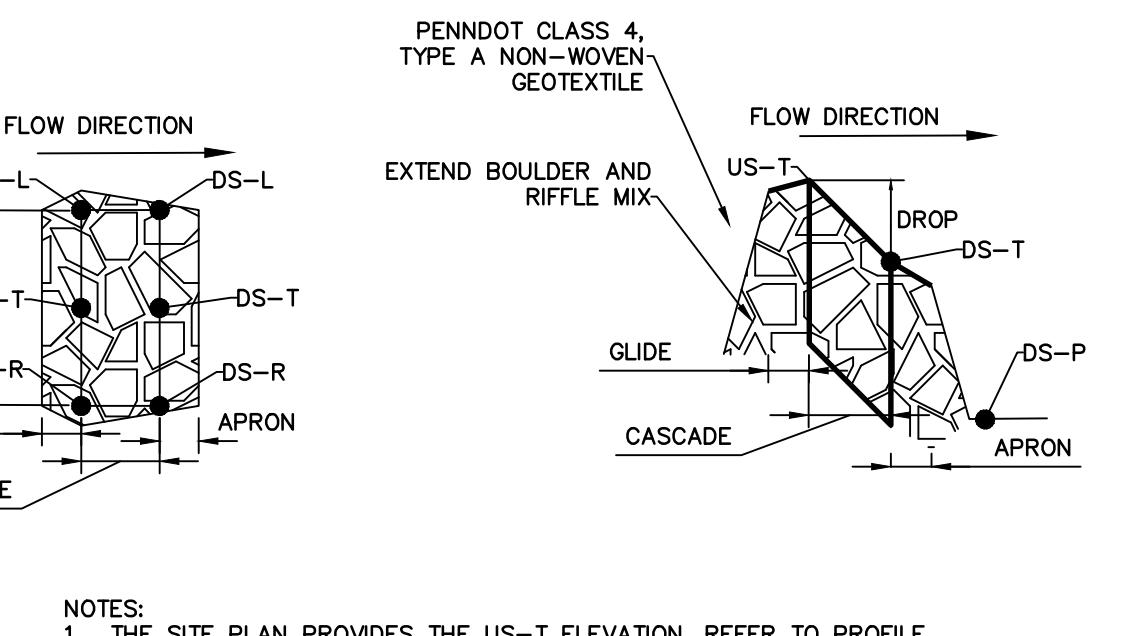


CASCADE PLAN VIEW
NOT TO SCALE

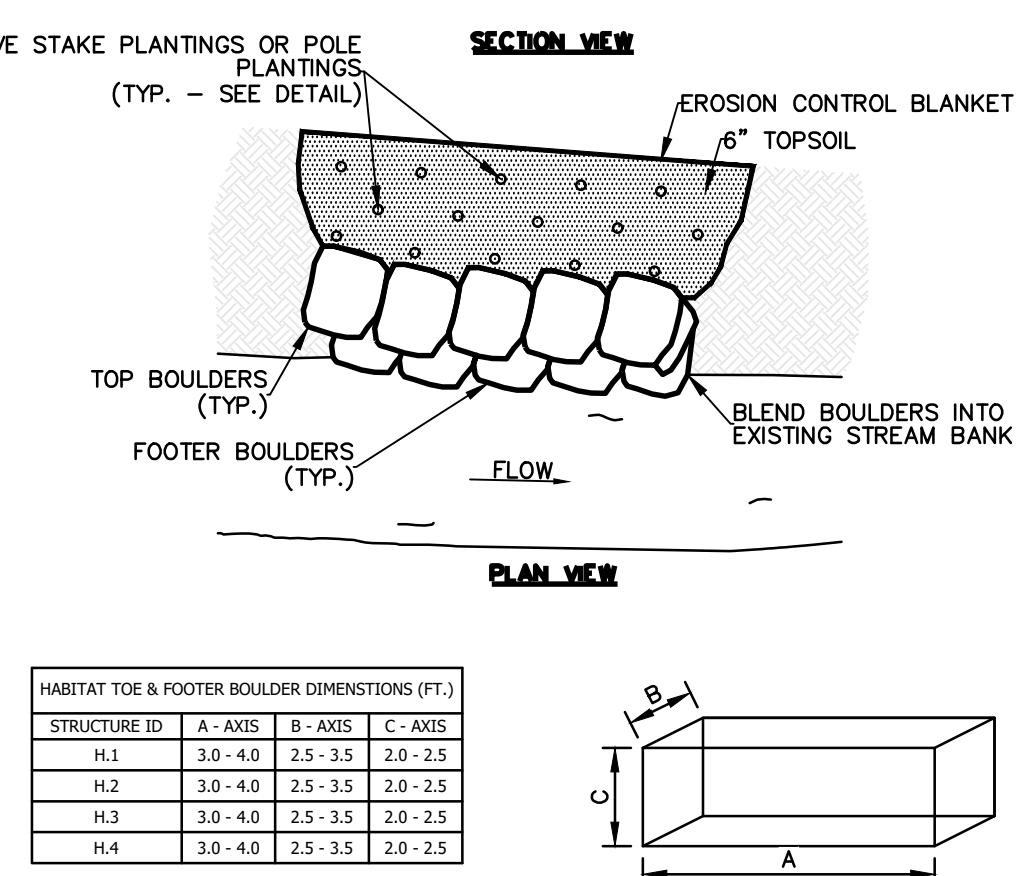

BOULDER SIZING DETAIL

1 HABITAT BOULDER TOE REVETMENT
WITH LIVING WALL STABILIZATION
NOT TO SCALE

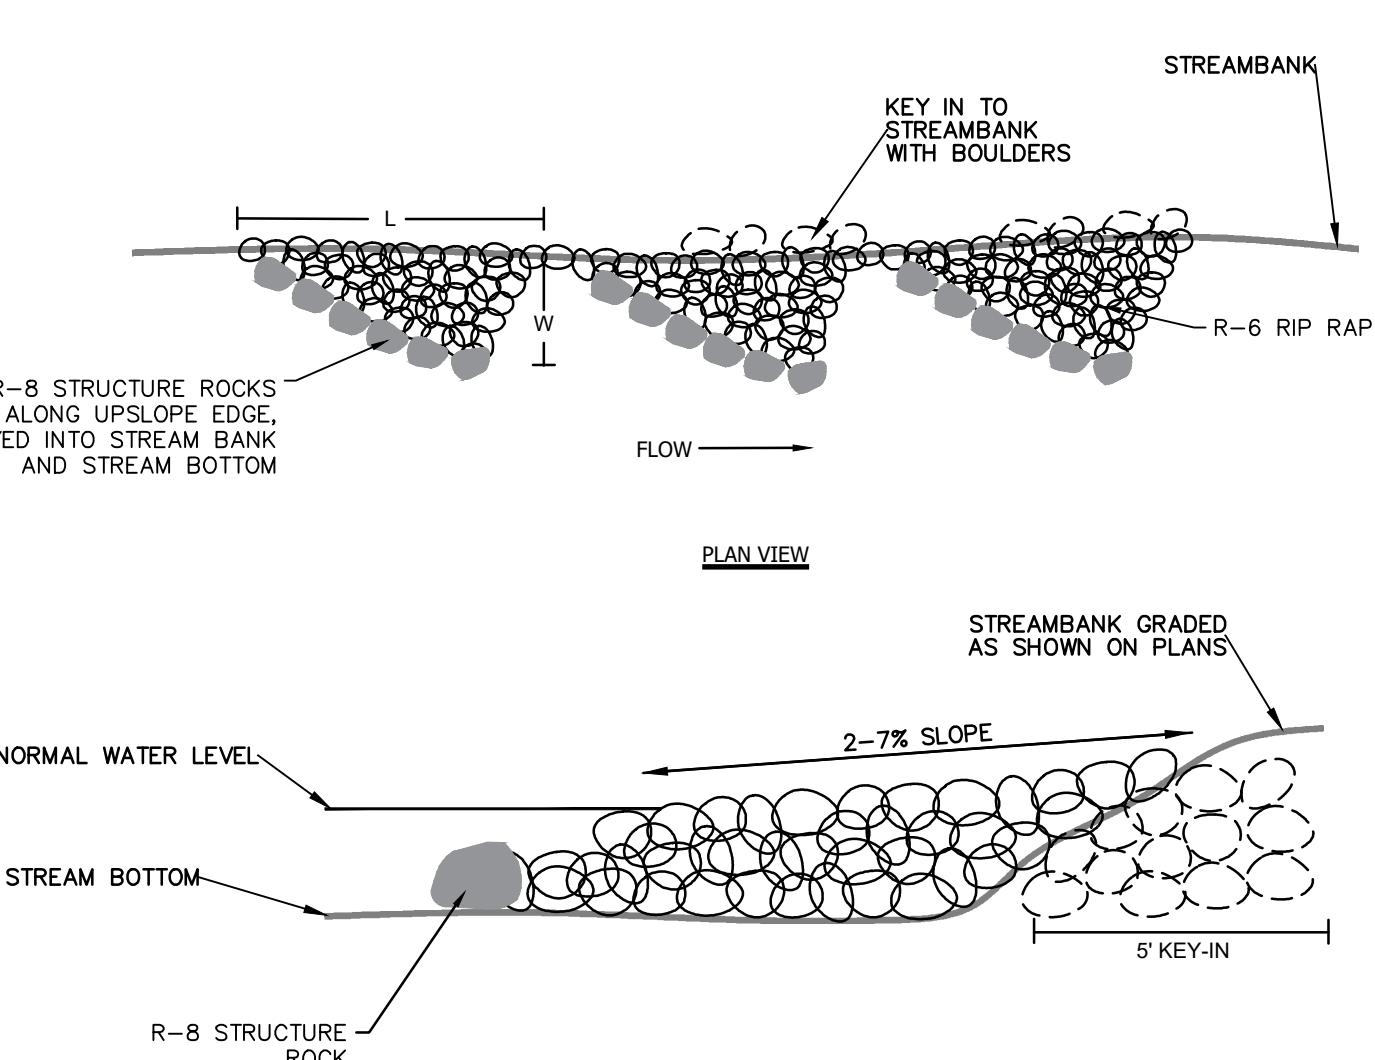

SAWTOOTH DEFLECTOR STRUCTURES TABLE				
STRUCTURES ID	MIN. # STRUCTURES	STRUCTURE LENGTH (FT.)	STRUCTURE WIDTH (FT.)	NOTES
D.1	2	10	4	
D.2	2	25	10	
D.3	4	10	4	
D.4	1	25	10	
D.5	1	32	13	SOIL LIFT W/ PLANTING BED
D.6	1	28	8.5	SOIL LIFT W/ PLANTING BED
D.7	2	25	10	

SAWTOOTH STONE DEFLECTOR STRUCTURE NOTES

1. DEFLECTOR SIZES MAY VARY; REFER TO STRUCTURES TABLE
2. SAWTOOTH STONE DEFLECTOR STRUCTURES SHALL BE CONSTRUCTED W/ R-6 RIP RAP WITH SELECT R-8 BOULDERS PLACED AS STRUCTURE ROCKS AT THE UPSTREAM EDGE OF STRUCTURES

STRUCTURE ID	TOP ELEVATION	WEIR TYPE	WIDTH (FEET)	SPACING (FEET)
W.1	271.0	STANDARD	10	15
W.2	271.0	STANDARD	10	15
W.3	271.0	STANDARD	10	15
W.4	264.0	STANDARD	10	30
W.5	264.0	ANGLED	10	30

BENDWAY WEIR CONSTRUCTION NOTES

1. BENDWAY WEIR STRUCTURES SHALL BE CONSTRUCTED W/ R-6 RIP RAP WITH SELECT R-8 BOULDERS PLACED AS STRUCTURE ROCKS AT THE UPSTREAM EDGE OF STRUCTURES
2. ALL EROSION AND SEDIMENT CONTROL DEVICES SHALL BE INSTALLED IN ACCORDANCE WITH AN APPROVED EROSION AND SEDIMENT POLLUTION CONTROL PLAN (ESPCP).
3. HABITAT FLOW SHOULD BE DIVERTED AWAY FROM THE WORK AREA IN ACCORDANCE WITH THE APPROVED ESPCP, AND THE SITE SHOULD BE Dewatered.
4. PLACE GEOTEXTILE ON AN EVEN FOOTING IN THE STREAM CHANNEL, KEY IN GEOTEXTILE A MINIMUM OF 2 FEET.
5. STONE SHALL BE PLACED BY MECHANICAL OR OTHER ACCEPTABLE METHODS WITH A MINIMUM OF Voids. THE STONE SHALL BE PLACED TO FORM A NEAT AND UNIFORM SURFACE AREA. NO MORTAR IS PERMITTED.
6. PLACE STONE AT THE DESIGN DIMENSIONS AND APPROPRIATE STRUCTURE SPACING.
7. INSTALL AND STABILIZE ANY DISTURBANCES ALONG THE STREAMBANK WITH SOIL STABILIZATION MATTING IN ACCORDANCE WITH THE SPECIFICATION.
8. REMOVE APPROVED ESPCP DEVICES UPON STABILIZATION OF THE CHANNEL IN ACCORDANCE WITH THE APPROVED PLAN.
9. STREAMBANKS IMMEDIATELY UPSTREAM AND DOWNSTREAM OF THE BENDWAY WEIR MAY REQUIRE ADDITIONAL STREAMBANK PROTECTION MEASURES AND SHOULD BE MONITORED CLOSELY.

02 SAWTOOTH STONE DEFLECTOR DETAIL
NOT TO SCALE

03 BENDWAY WEIR DETAIL
NOT TO SCALE

04 CASCADE STRUCTURE DETAIL
NOT TO SCALE


CASCADE NOTES:

1. CASCADE SHALL BE A MINIMUM OF 25' WIDE, AND SHALL BE INSTALLED WIDER AS NECESSARY TO KEY IN EDGE OF CASCADE WEIR INTO THE EXISTING GRADE. SEE CASCADE STRUCTURES TABLE ON SHEET XXX.
2. IMPORTED GRAVEL COMPONENTS CAN BE REPLACED W/ NATIVE STREAMBED SUBSTRATE, IF AVAILABLE.
3. REFER TO SHEET 01-05 AND PROFILE FOR ADDITIONAL ELEVATION AND LOCATION INFORMATION FOR CASCADE PLACEMENT.
4. THE CROSS SECTION SHOULD BE TRANSLATED INTO A PARABOLIC SHAPE.
5. FOR ALL MATERIAL SIZES, REFER TO SPECIFICATIONS AND TABLES PROVIDED ON THIS DETAIL.
6. NATURAL CHANNEL MATERIAL MAY BE HARVESTED ON-SITE PRIOR TO INSTALLATION OF CASCADE IF IT MEETS THE SPECIFICATIONS.
7. RIFFLE MIX SHALL BE A MINIMUM THICKNESS OF TWICE THE SPECIFIED D50 OF THE MATERIAL OR 2', WHICHEVER IS LARGER. TAPER UPSTREAM AND DOWNSTREAM LIMITS AS SHOWN.
8. THE NUMBER OF BOULDERS VARIES DEPENDING ON TYPICAL SECTION WIDTH AND BOULDER DIMENSIONS.
9. IN AREAS OF CUT, CHANNEL FILL MATERIAL UNDER RIFFLE MIX IS NOT REQUIRED; IN AREAS OF FILL, EXISTING STREAM CHANNEL TO BE FILLED IN 8" LIFTS WITH CHANNEL FILL MATERIAL TO ELEVATION SPECIFIED ON PROFILE.
10. AS NEEDED, EXCAVATE THE DOWNSTREAM TIE OUT AREA FOR SPLASH BOULDERS AND INSTALL THE SPLASH AND CASCADE BOULDERS, LAYING A CONTINUOUS SHEET OF GEOTEXTILE UNDER ALL BOULDERS. TOP OF CASCADE BOULDERS SHALL BE INSTALLED IN A MANNER CONFORMING TO THE PARABOLIC CASCADE SHAPE, SHOWN IN THE DETAIL, AND SHALL MEET FINISHED GRADE.
11. RIFFLE MIX OR CHANNEL MATERIAL SHALL BE REGULARLY WORKED INTO THE FULL DEPTH OF CASCADE TO FILL Voids BETWEEN BOULDERS.
12. THE BOULDERS SHALL BE TILLED DOWNSTREAM AS SHOWN ON THE DETAIL AND NOT STACKED. STAGGER SEAMS OF BOULDERS BETWEEN EACH ROW. INSTALL RIFFLE MIX APRON TO BLEND INTO EXISTING STREAM POOL AS SHOWN ON DETAIL.
13. TIE-OUT BOULDER SHALL EXTEND PAST THE CORNER NODES DS-L & DS-R A MIN. OF ONE BOULDER LENGTH (B-AXIS) INTO EXISTING BANK, WHERE THIS CONFLICTS WITH EXISTING TREE ROOTS OR BEDROCK. TIE-OUT BOULDER MAY BE ELIMINATED OR ADJUSTED AT DIRECTION OF ENGINEER, WHEN THE CASCADE STRUCTURE IS ADJACENT TO A BOLSTER WALL OR TOE STRUCTURE, CASCADE TIE-OUT BOULDERS SHALL BE EXTENDED TO THE BOLSTER WALL OR TOE STRUCTURE.
14. PLACEMENT OF RIFFLE MIX IS TO BE DIFFERENT UPSTREAM AND DOWNSTREAM OF THE CASCADE TO ADJUST TO THE CHANNEL CROSS SECTION, COMPRESSING MATERIALS TO MAINTAIN PARABOLIC CROSS SECTION SHAPE.
15. SALVAGED NATURAL CHANNEL MATERIAL SHALL BE REPEATEDLY WORKED INTO FULL DEPTH OF THE RIFFLE MIX TO FILL Voids.
16. EXCAVATE UPSTREAM POOL AND INSTALL RIFFLE MIX GUIDE AS SHOWN ON DETAIL.
17. TRIM ALL GEOTEXTILE AT OR BELOW FINISHED GRADE.
18. ONCE CASCADE IS CONSTRUCTED, STABILIZE ALL DISTURBED TIE-IN LOCATIONS AS SPECIFIED.

04 CASCADE STRUCTURE DETAIL
NOT TO SCALE

**CONSTRUCTION AND EROSION CONTROL PLANS
FOR
SCULAC ROAD STREAM RESTORATION**

BETHLEHEM TOWNSHIP MUNICIPAL AUTHORITY
BETHLEHEM, PA 18020
4225 EASTON AVENUE
NORTHAMPTON COUNTY, PENNSYLVANIA

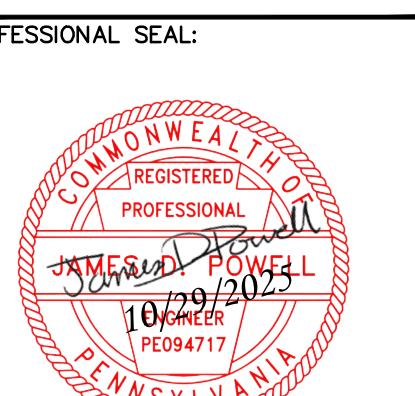

HRG PROJECT NUMBER: R009170.0431
PLAN DATE: FEBRUARY 2025
DRAWING SCALE: AS SHOWN
PROJ. MANAGER: MATTHEW VANASKE


REVISIONS

NO.	DATE	DESCRIPTION
1	03/05/25	REVISED PER NCCD COMMENTS
2	10/01/25	REVISED PER CONSTRUCTABILITY REVIEW
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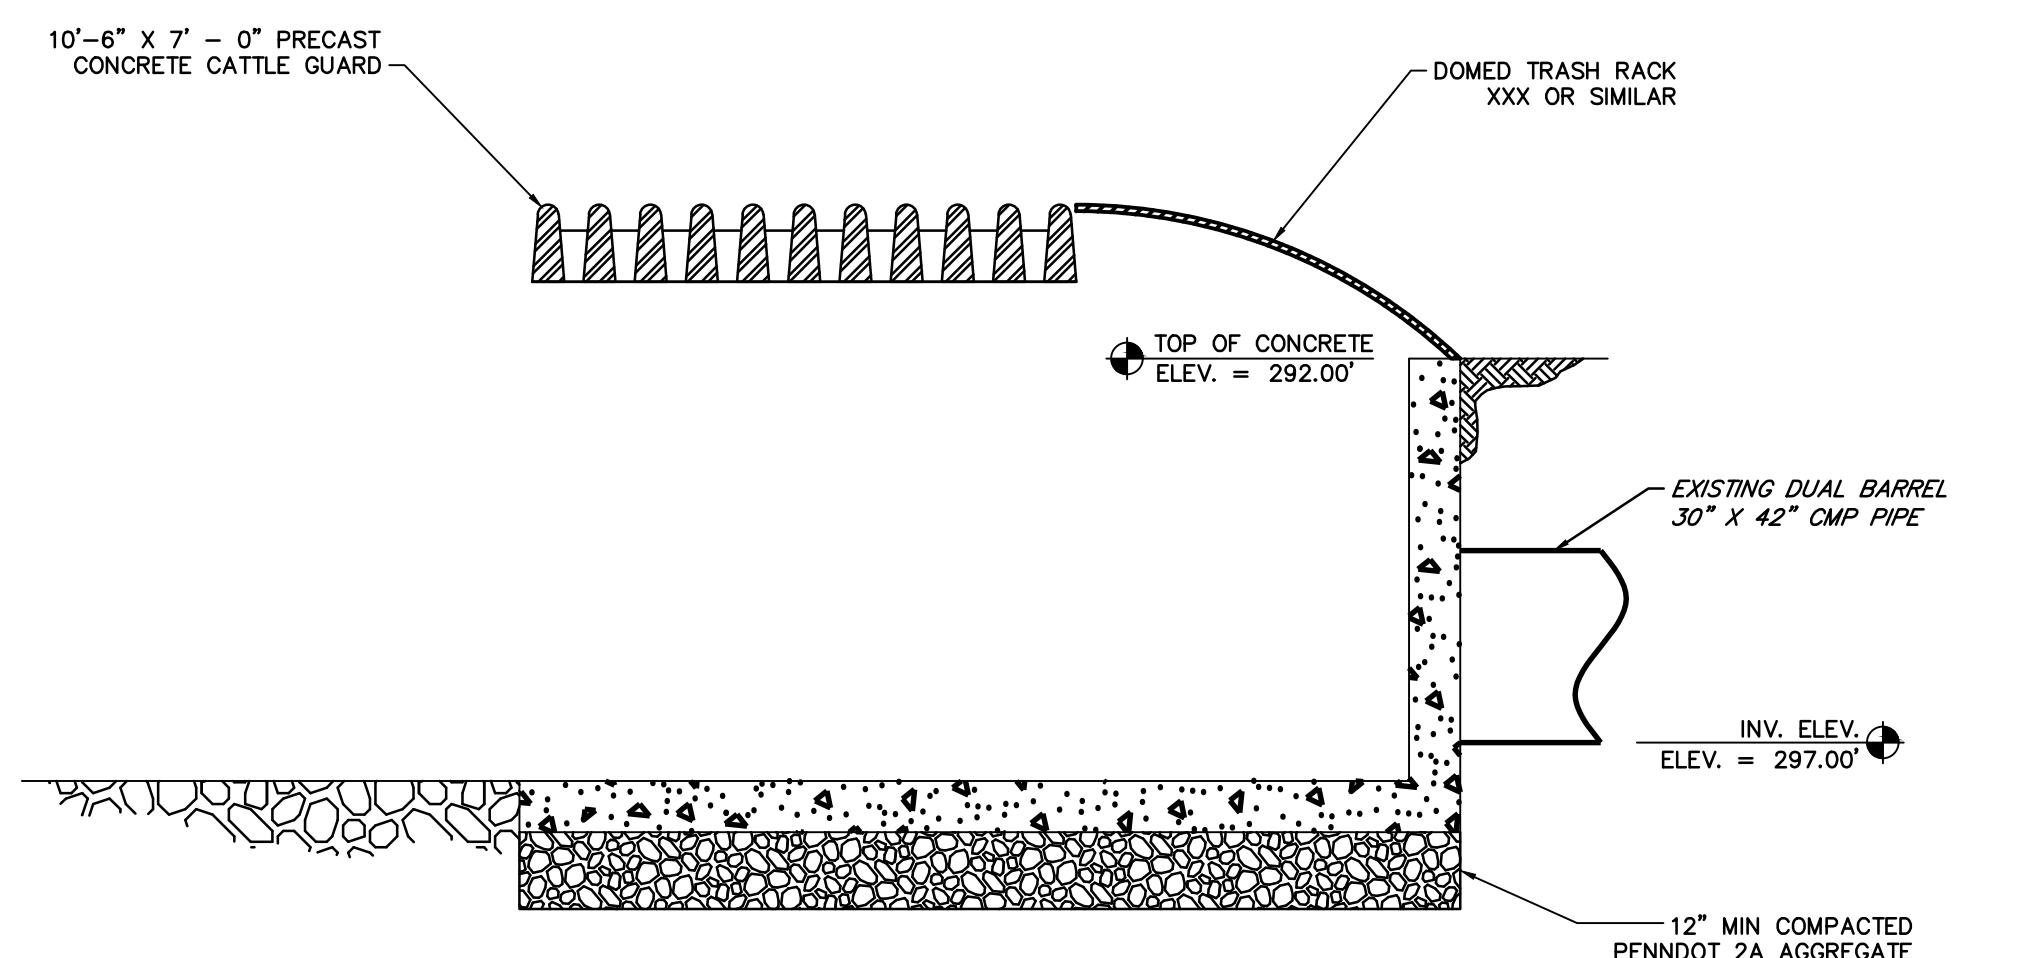
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ENERGY
DISSIPATER
DETAILS**

SHEET: DT-03


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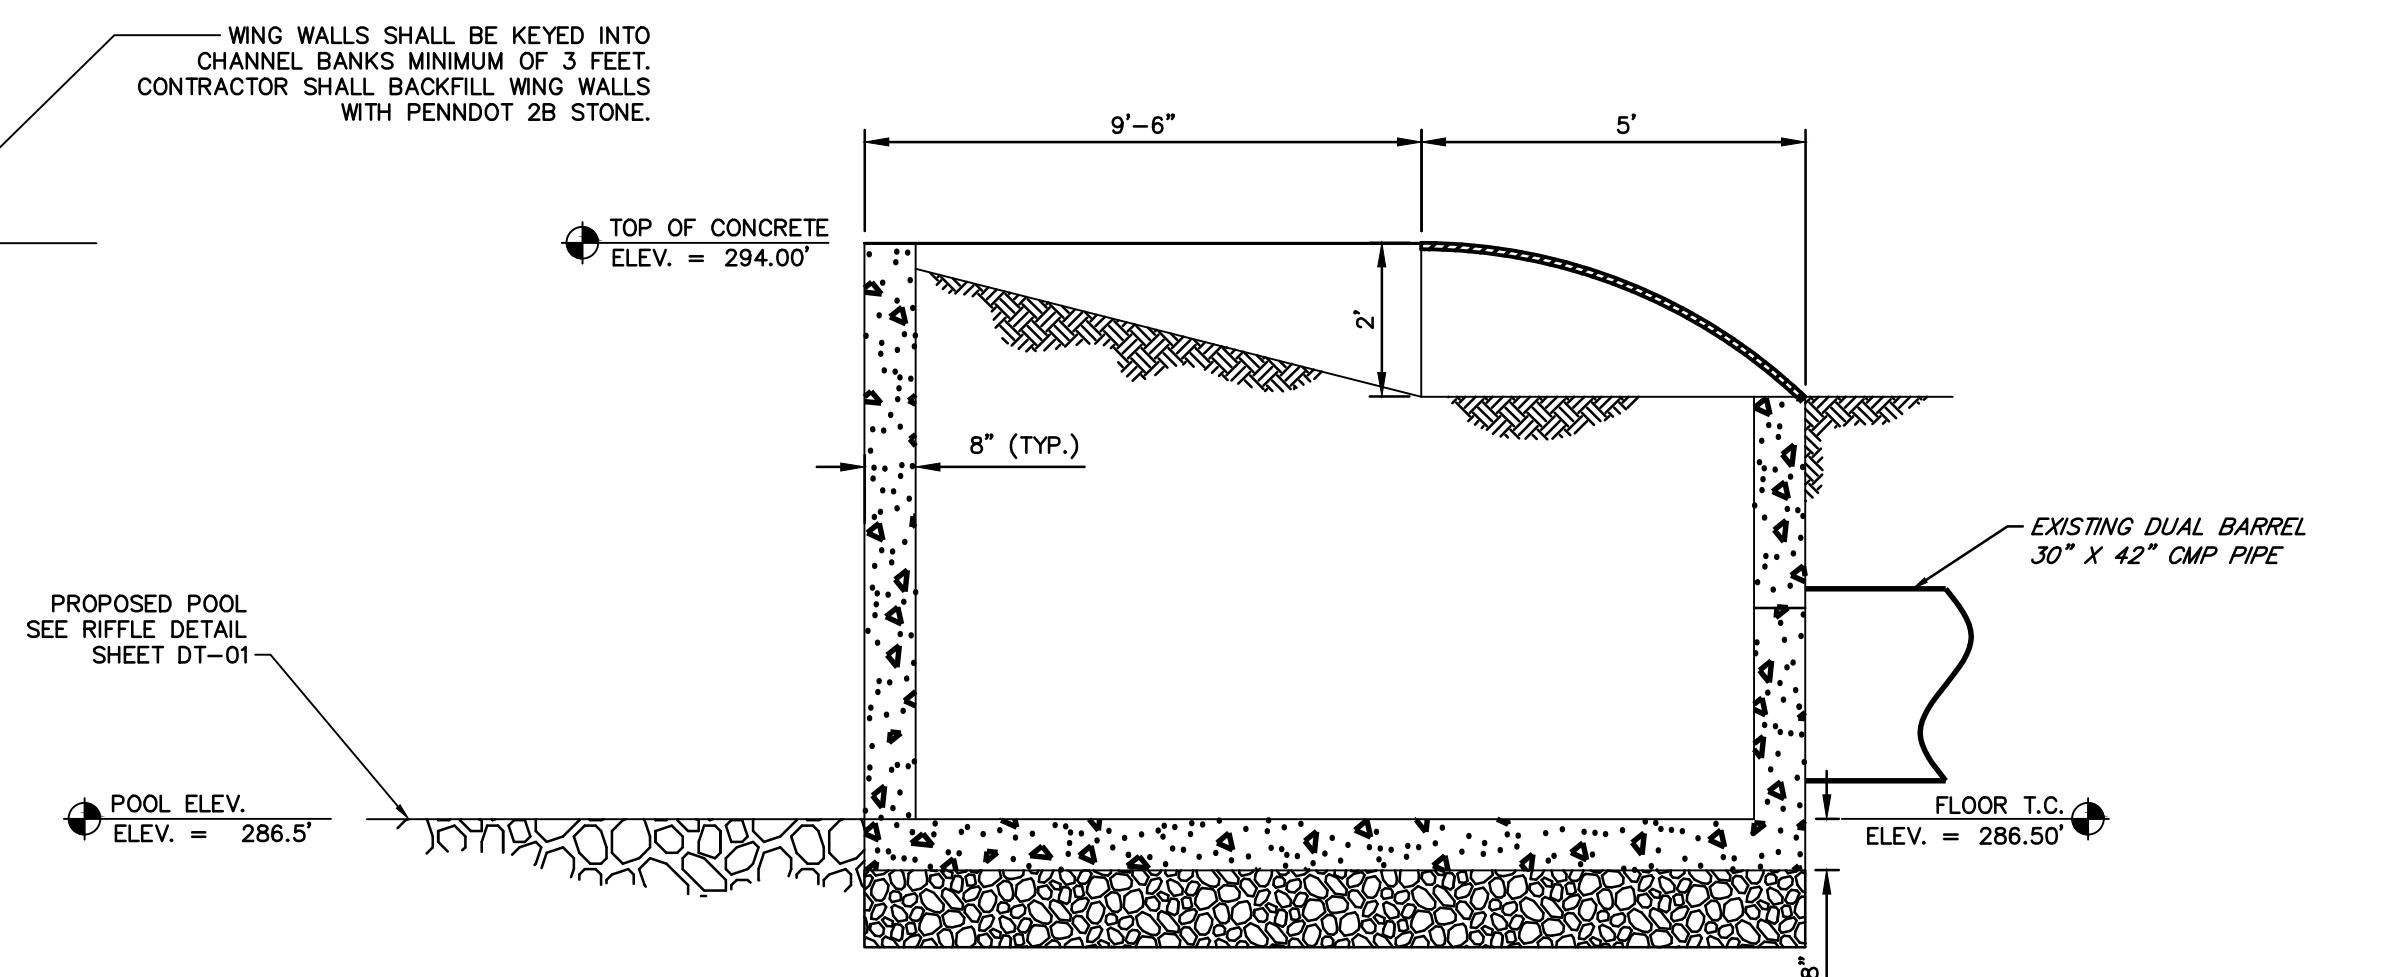
PLAN VIEW
NOT TO SCALE

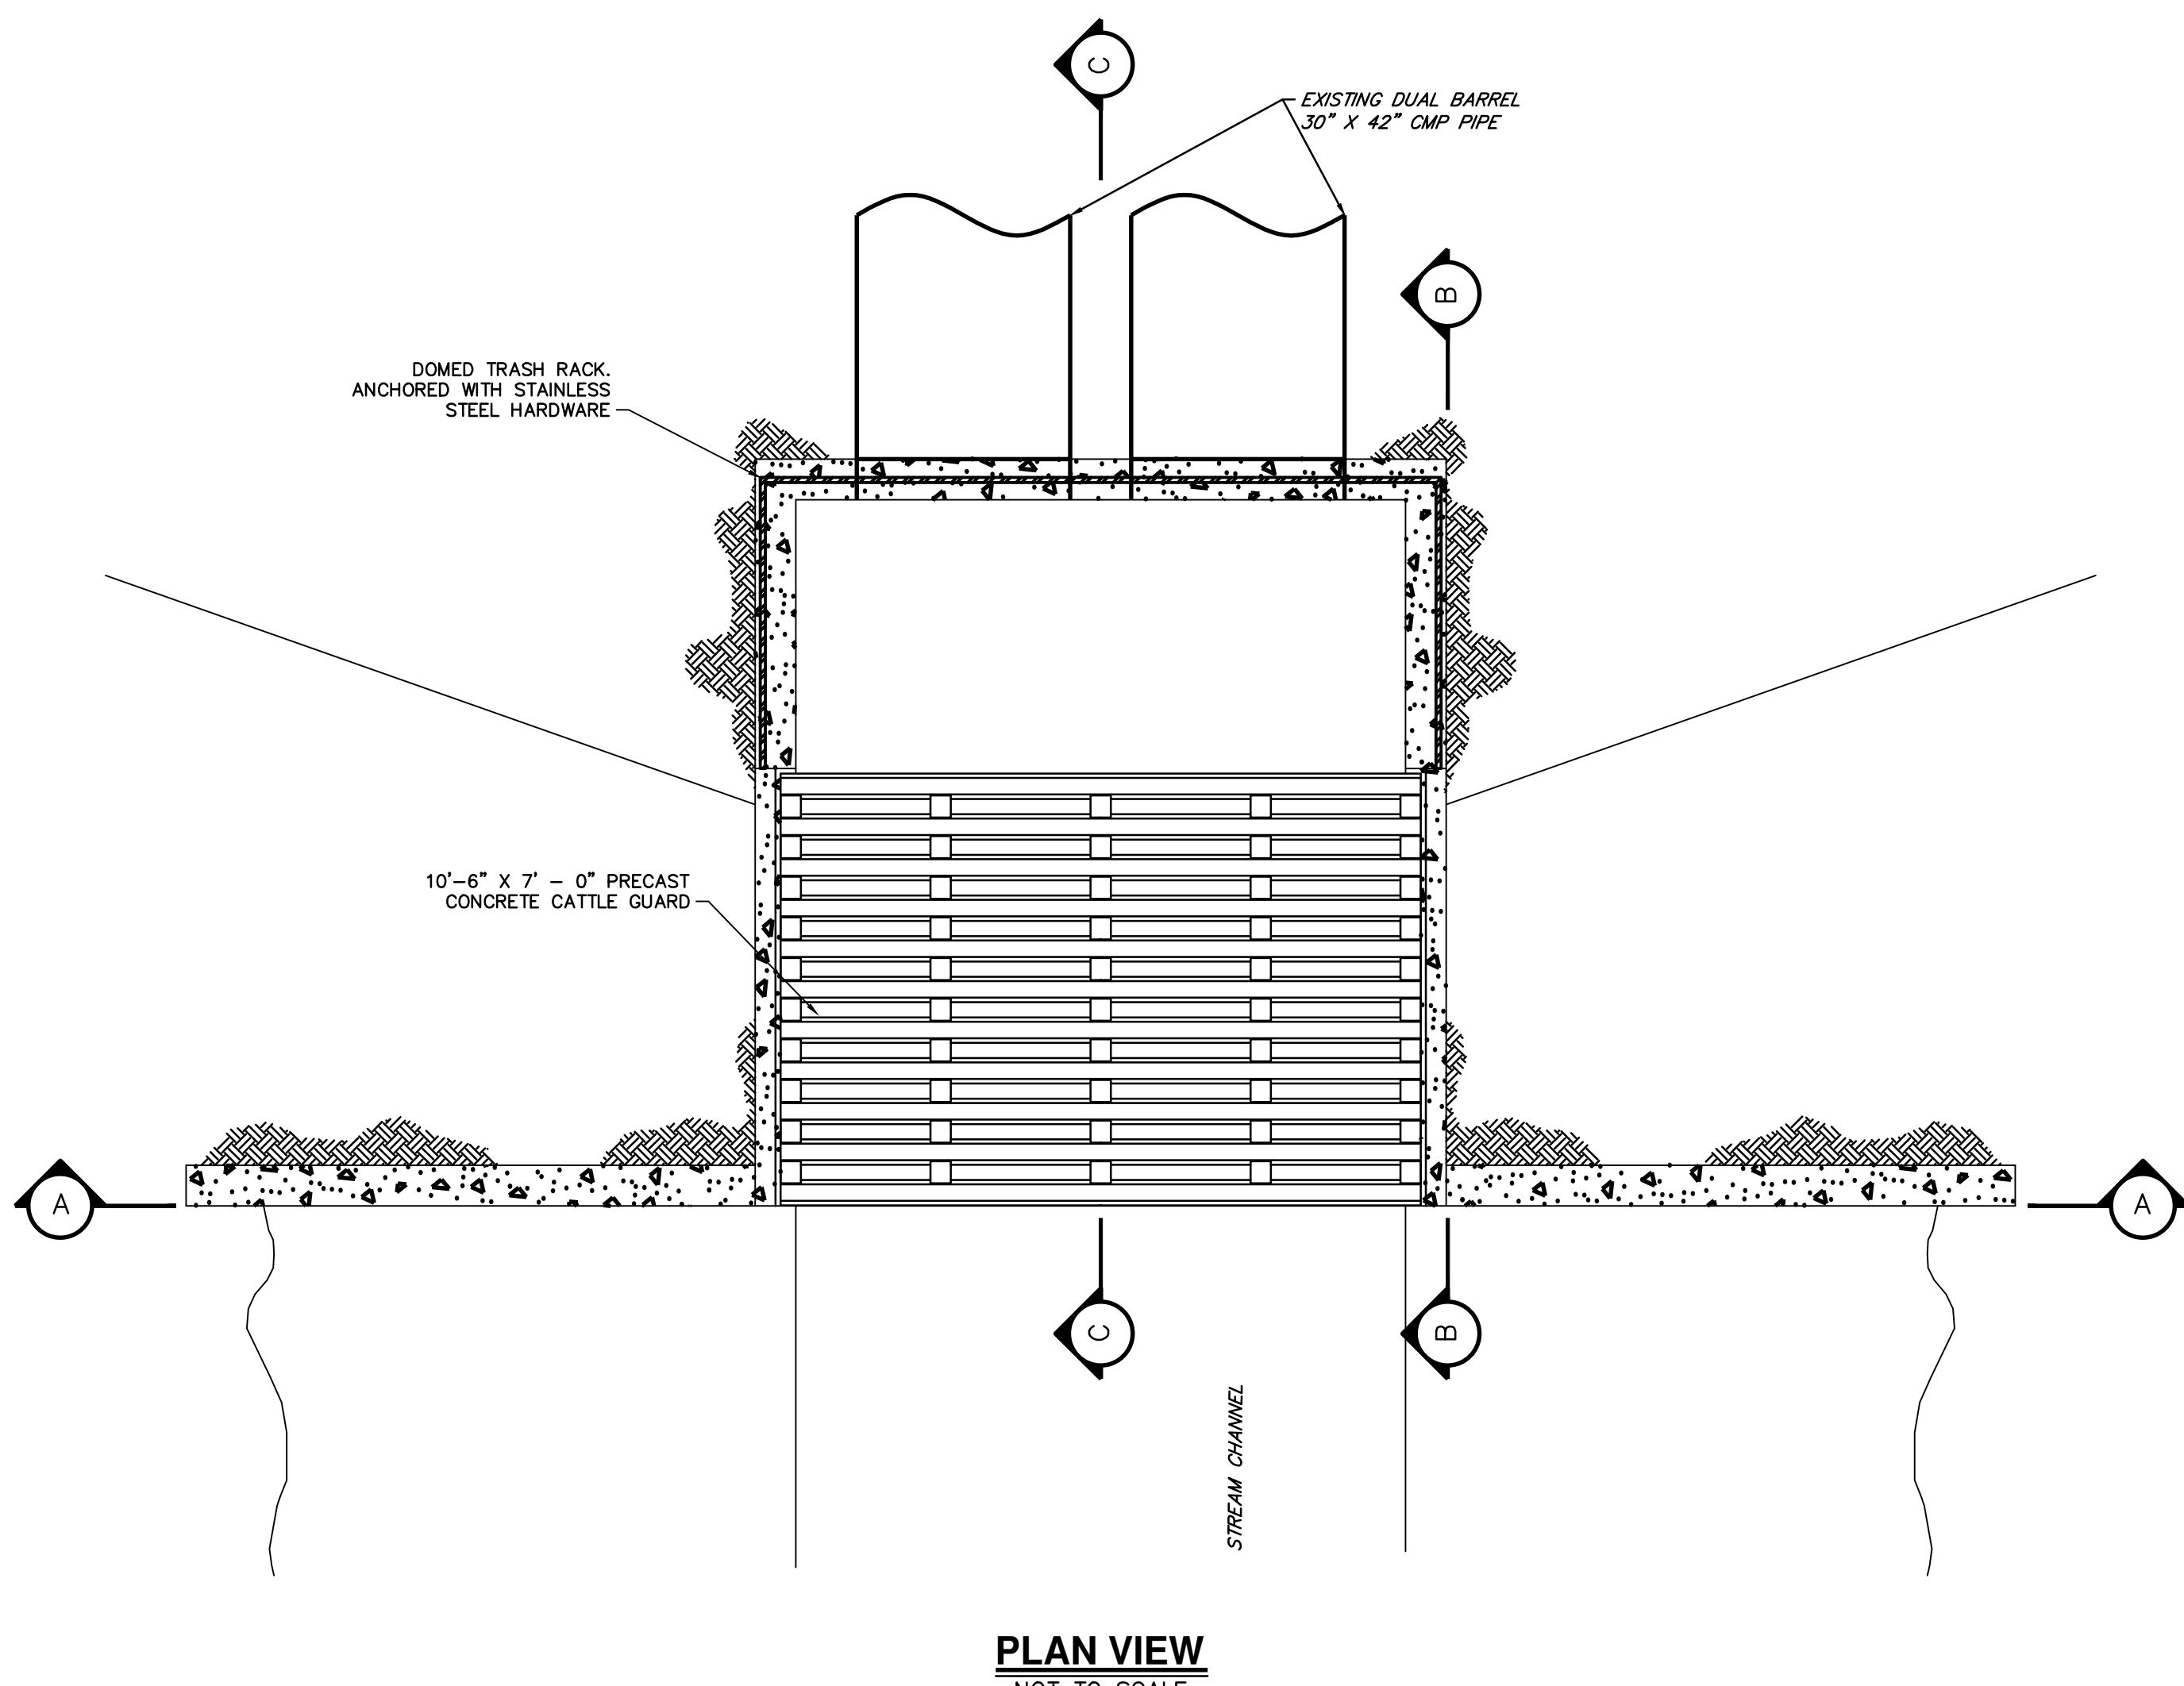

SECTION VIEW C-C
NOT TO SCALE



SECTION VIEW A-A
NOT TO SCALE

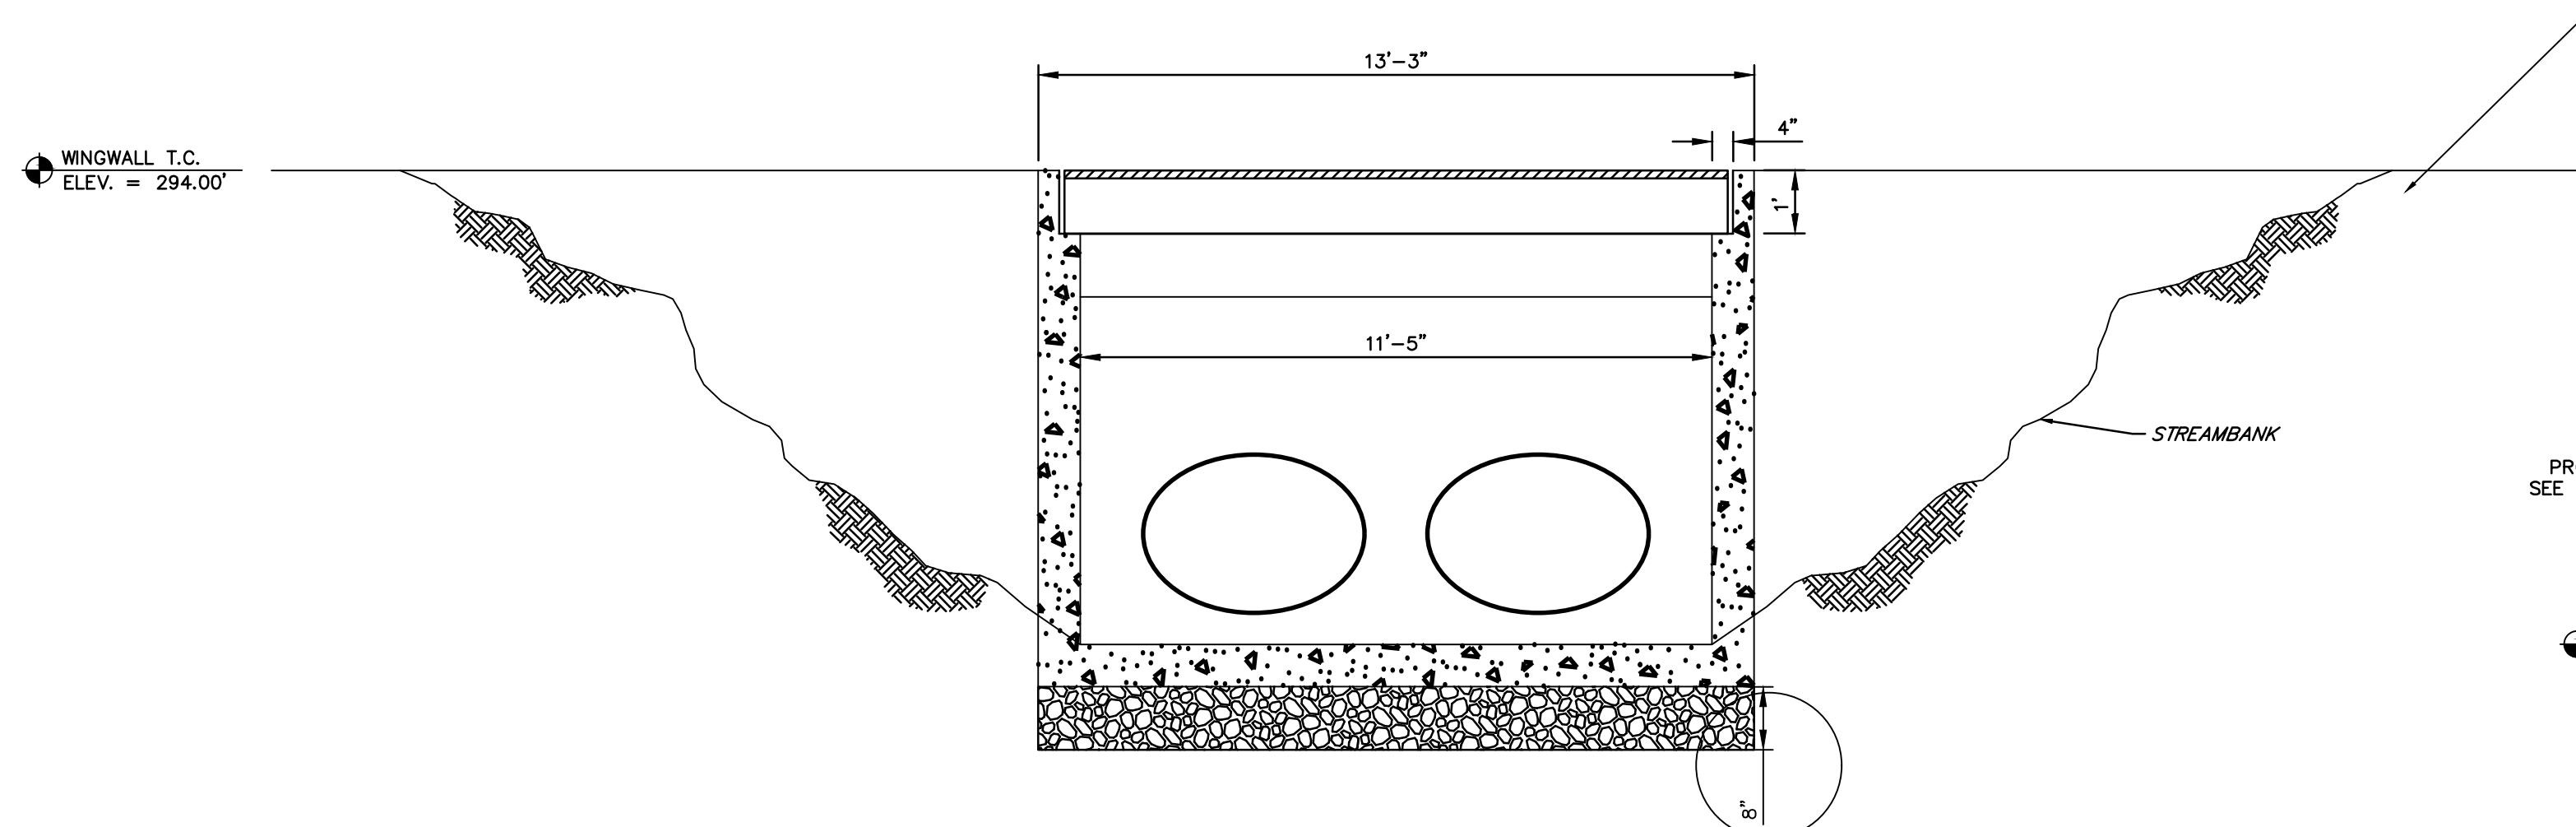

SECTION VIEW B-B
NOT TO SCALE

CONSTRUCTION AND EARTHWORKS CONTRACT
FOR
SCULAC ROAD STREAM RESTORATION

4225 EASTON AVENUE
BETHLEHEM, PA 18020

The seal is circular with a rope-like border. The words "COMMONWEALTH OF PENNSYLVANIA" are written in a circle at the top. In the center, "REGISTERED" is above "PROFESSIONAL". Below that is a signature of "JAMES D. POWELL" over "10/29/2025". At the bottom, "ENGINEER" is above "PE094717".

PROJECT NUMBER: R009170.043
N DATE: FEBRUARY 2024
WING SCALE: AS SHOWN
J. MANAGER: MATTHEW VANASKI

DESCRIPTION	COMMENTS	STRUCTABILITY	REVIEW

ET TITLE:
**ROSION
ONTROL PLAN**

ET: **ESC-01** | **22**



LIMIT OF DISTURBANCE LEGEND

----- LIMIT OF CHAPTER 105 DISTURBANCE

—LOD— LIMIT OF DISTURBANCE

ACCESS ROAD NOTES

1. FOR ACCESS ROADS IN FIELDS, TOPSOIL IS TO BE STRIPPED, STOCKPILED AND MAINTAINED IN A CLEANLY SEGREGATED MANNER FOR RESPREADING. ACCESS ROAD SHALL HAVE PERIMETER CONTROLS APPROPRIATE TO THE SPECIFIC SITE CONDITIONS. IF POSSIBLE, CONTRACTOR SHALL USE STOCKPILED SOIL AS DIVERSION BERMS TO PREVENT CONTAMINATION.
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3. FOR SPECIFIC AREAS AS CALLED OUT ON PLANS, INSTALL TIMBER MATTING PER DETAIL ON SHEET DT-02..

GRAPHIC SCALE

20' 10' 0'


SCALE: 1" = 20'

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ET: **ESC-01** | **22**

**CONSTRUCTION AND EROSION CONTROL PLANS
FOR
SCULAC ROAD STREAM RESTORATION**

4223 EASTON AVENUE
BETHLEHEM, PA 18020
BETHLEHEM TOWNSHIP NORTHAMPTON COUNTY PENNSYLVANIA

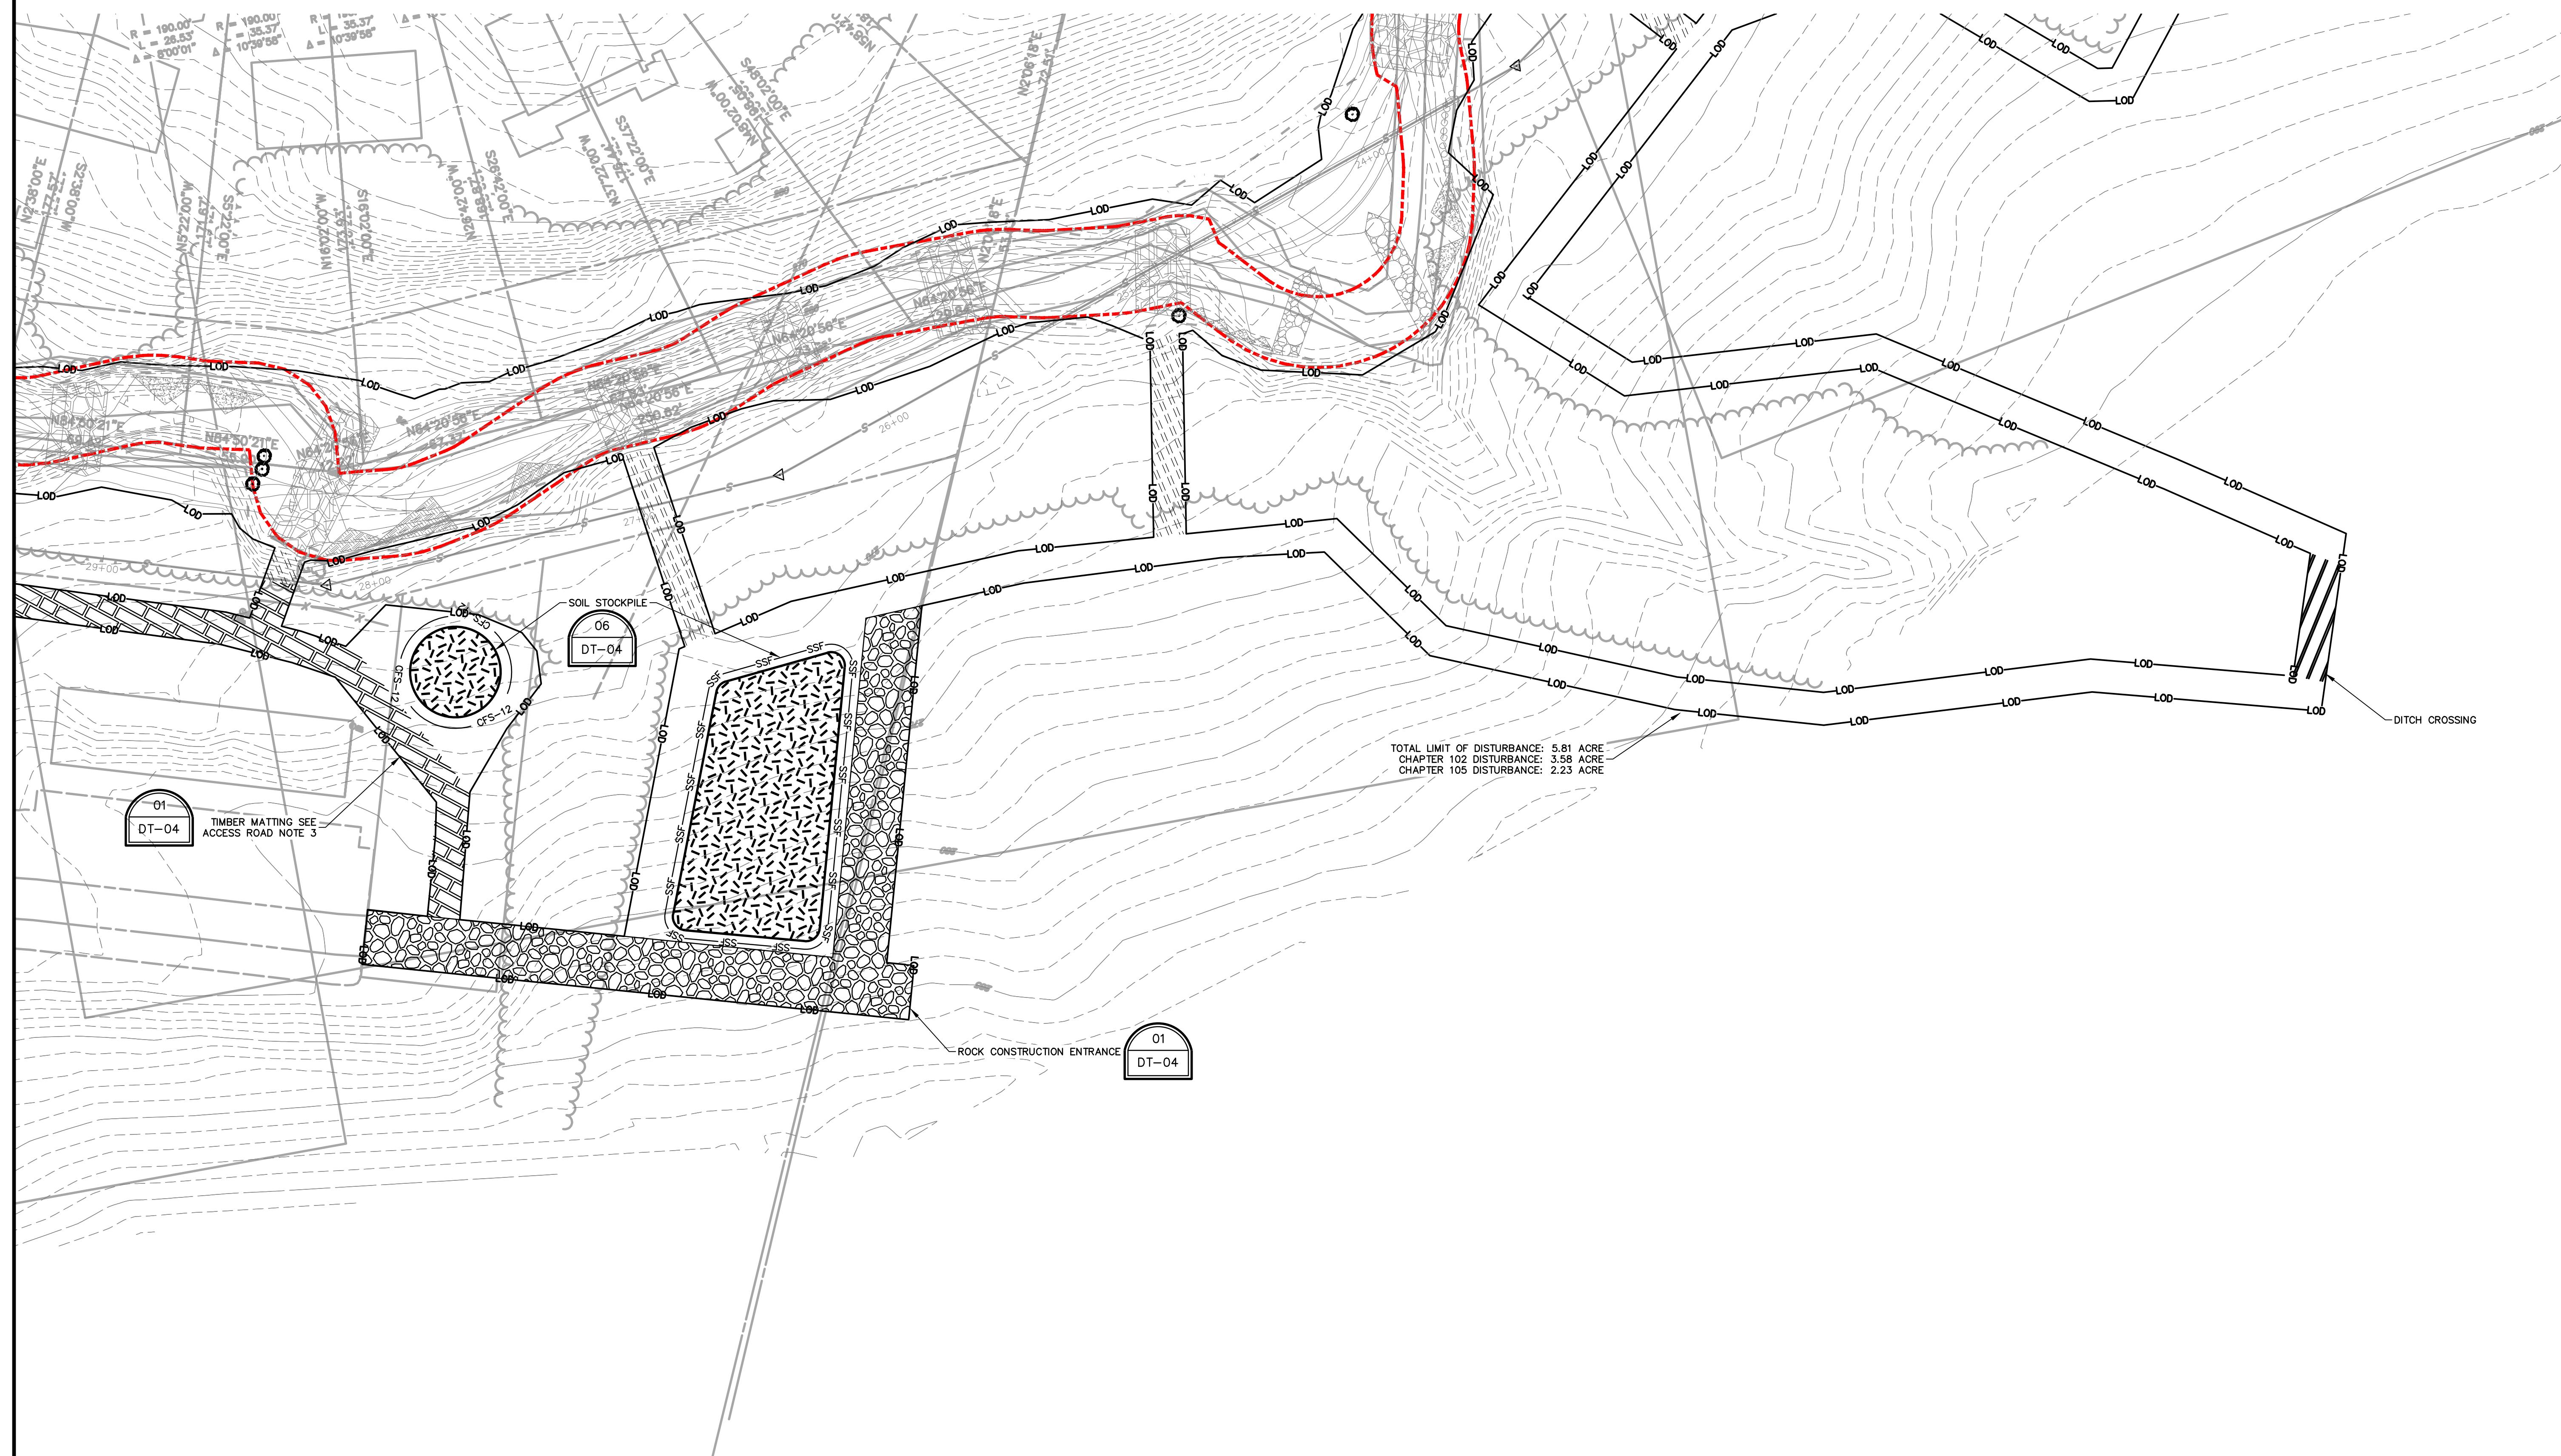

LIMIT OF DISTURBANCE LEGEND

----- LIMIT OF CHAPTER 105 DISTURBANCE

LCP LIMIT OF DISTURBANCE

ACCESS ROAD NOTES

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3. FOR SPECIFIC AREAS AS CALLED OUT ON PLANS, INSTALL TIMBER MATTING PER DETAIL ON SHEET DT-02.

GRAPHIC SCALE

20' 10' 0'

SCALE 1" = 20'

SHEET: **ESC-01**

23

A circular red seal with a rope-like border. The outer ring contains the text "COMMONWEALTH OF PENNSYLVANIA" at the top and "PROFESSIONAL ENGINEER" at the bottom. The inner circle contains "REGISTERED" at the top and "JAMES D. POWELL" in the center. Below the name is the date "10/29/2025". At the bottom of the inner circle is the identifier "PE094717". The seal is stamped on a white background.

HRG PROJECT NUMBER: R009170.0431
PLAN DATE: FEBRUARY 2025
DRAWING SCALE: AS SHOWN
PROJ. MANAGER: MATTHEW VANASKIE

REVISIONS		
REV.	DATE	DESCRIPTION
1	03/05/25	REVISED PER NCCD COMMENTS
2	10/01/25	REVISED PER CONSTRUCTABILITY REVIEW
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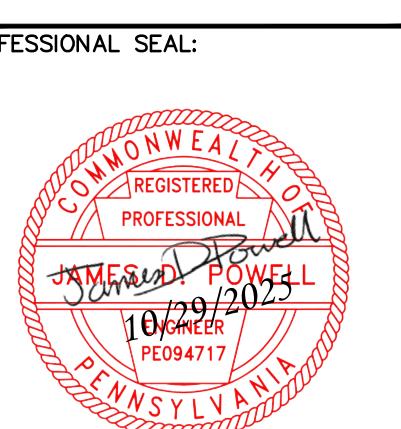
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SHEET TITLE:
**EROSION
CONTROL PLAN**

SHEET: **ESC-01**

23

CONSTRUCTION AND EROSION CONTROL PLANS
FOR
SCULAC ROAD STREAM RESTORATION

BETHLEHEM TOWNSHIP MUNICIPAL AUTHORITY
4225 EASTON AVENUE
BETHLEHEM, PA 18020
NORTHAMPTON COUNTY, PENNSYLVANIA



HRG PROJECT NUMBER: R009170.04.31
PLAN DATE: FEBRUARY 2025
DRAWING SCALE: AS SHOWN
PROJ. MANAGER: MATTHEW VANASKE

REVISIONS


NO.	DATE	DESCRIPTION
1	03/05/25	REVISED PER NCCD COMMENTS REVISED PER CONSTRUCTIONABILITY REVIEW
2	10/01/25	
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EROSION
CONTROL PLAN

SHEET TITLE:

ESC-02

24

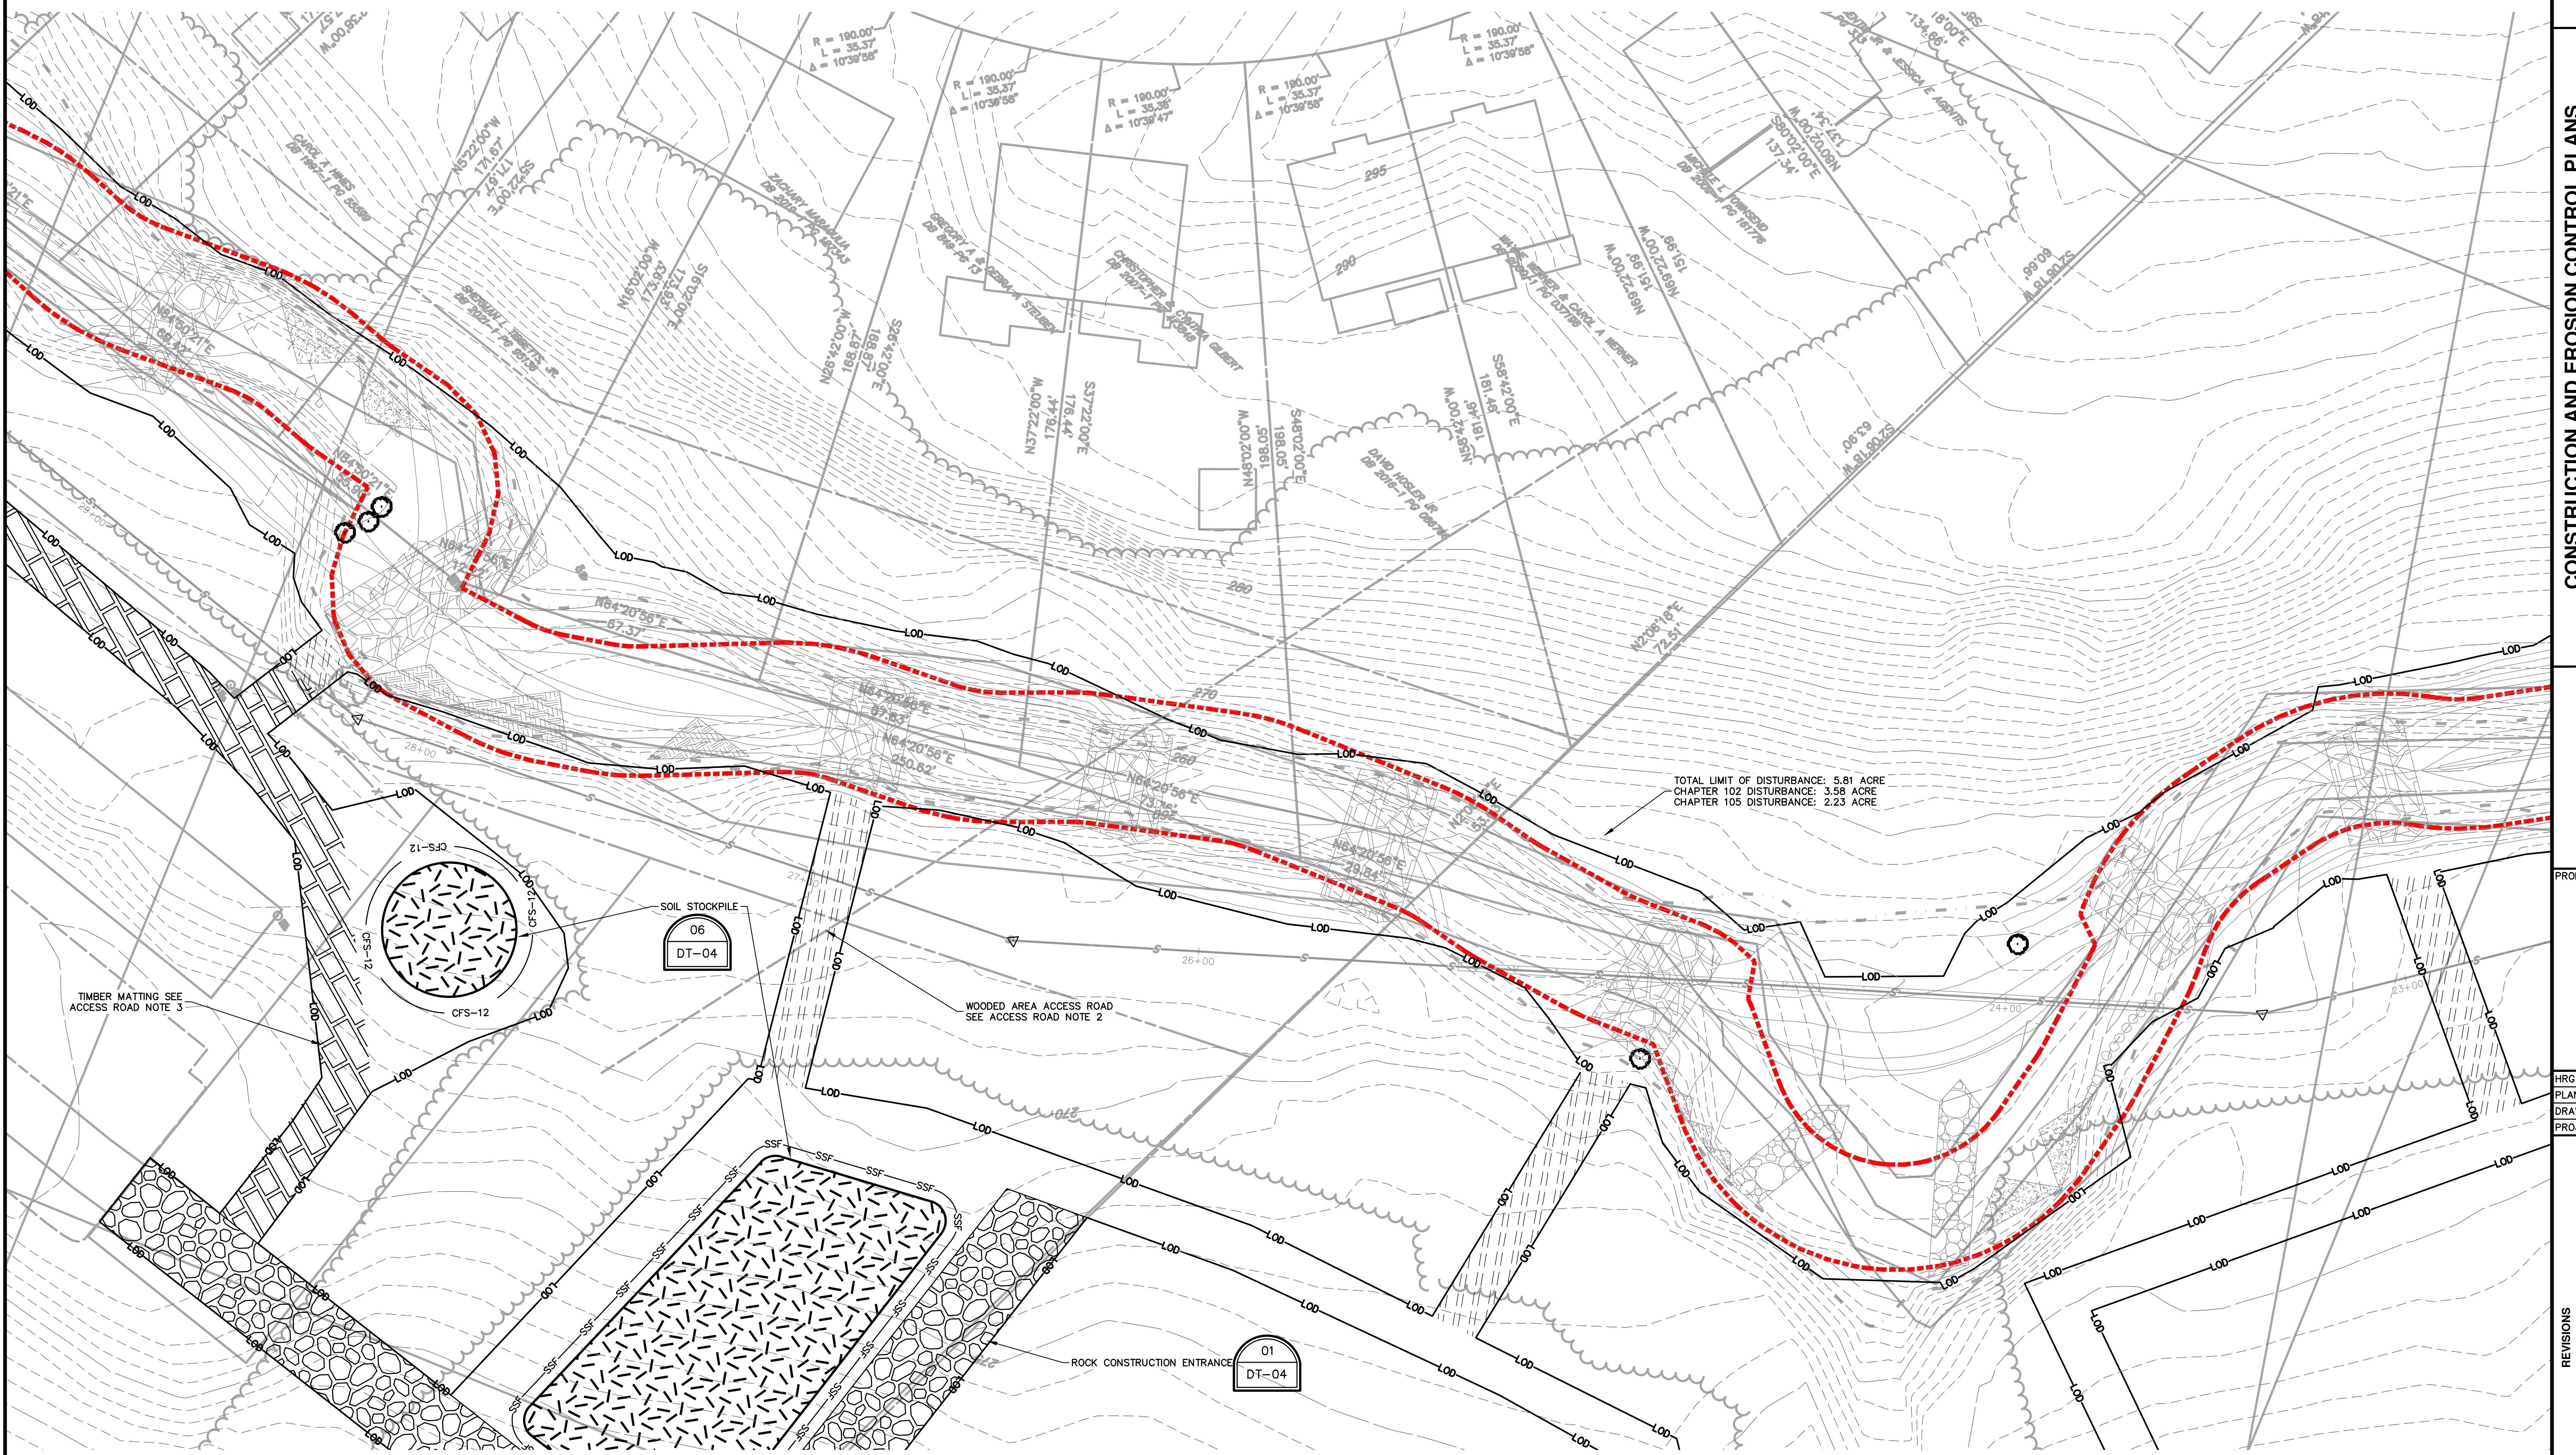


LIMIT OF DISTURBANCE LEGEND

— LIMIT OF CHAPTER 105 DISTURBANCE

— LOD — LIMIT OF DISTURBANCE

ACCESS ROAD NOTES

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3. FOR SPECIFIC AREAS AS CALLED OUT ON PLANS, INSTALL TIMBER MATTING PER DETAIL ON SHEET DT-02.

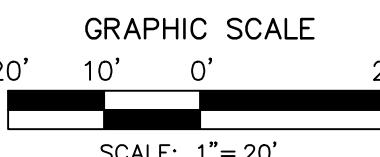


SCALE: 1" = 20'

SHEET:

ESC-02

24

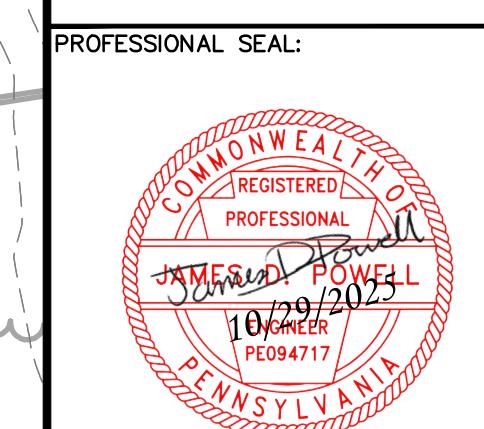


HRG PROJECT NUMBER: R009170.04.31
PLAN DATE: FEBRUARY 2025
DRAWING SCALE: AS SHOWN
PROJ. MANAGER: MATTHEW VANASKE

REVISIONS	DESCRIPTION
1	03/05/25 REVISED PER NCCD COMMENTS
2	10/10/25 REVISED PER CONSTRUCTION REVIEW
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EROSION
CONTROL PLAN

FILE NAME: R009170.04.31.DWG | LAST UPDATED: 02/29/2025 | 11:59 AM | BY: SPOTW

25

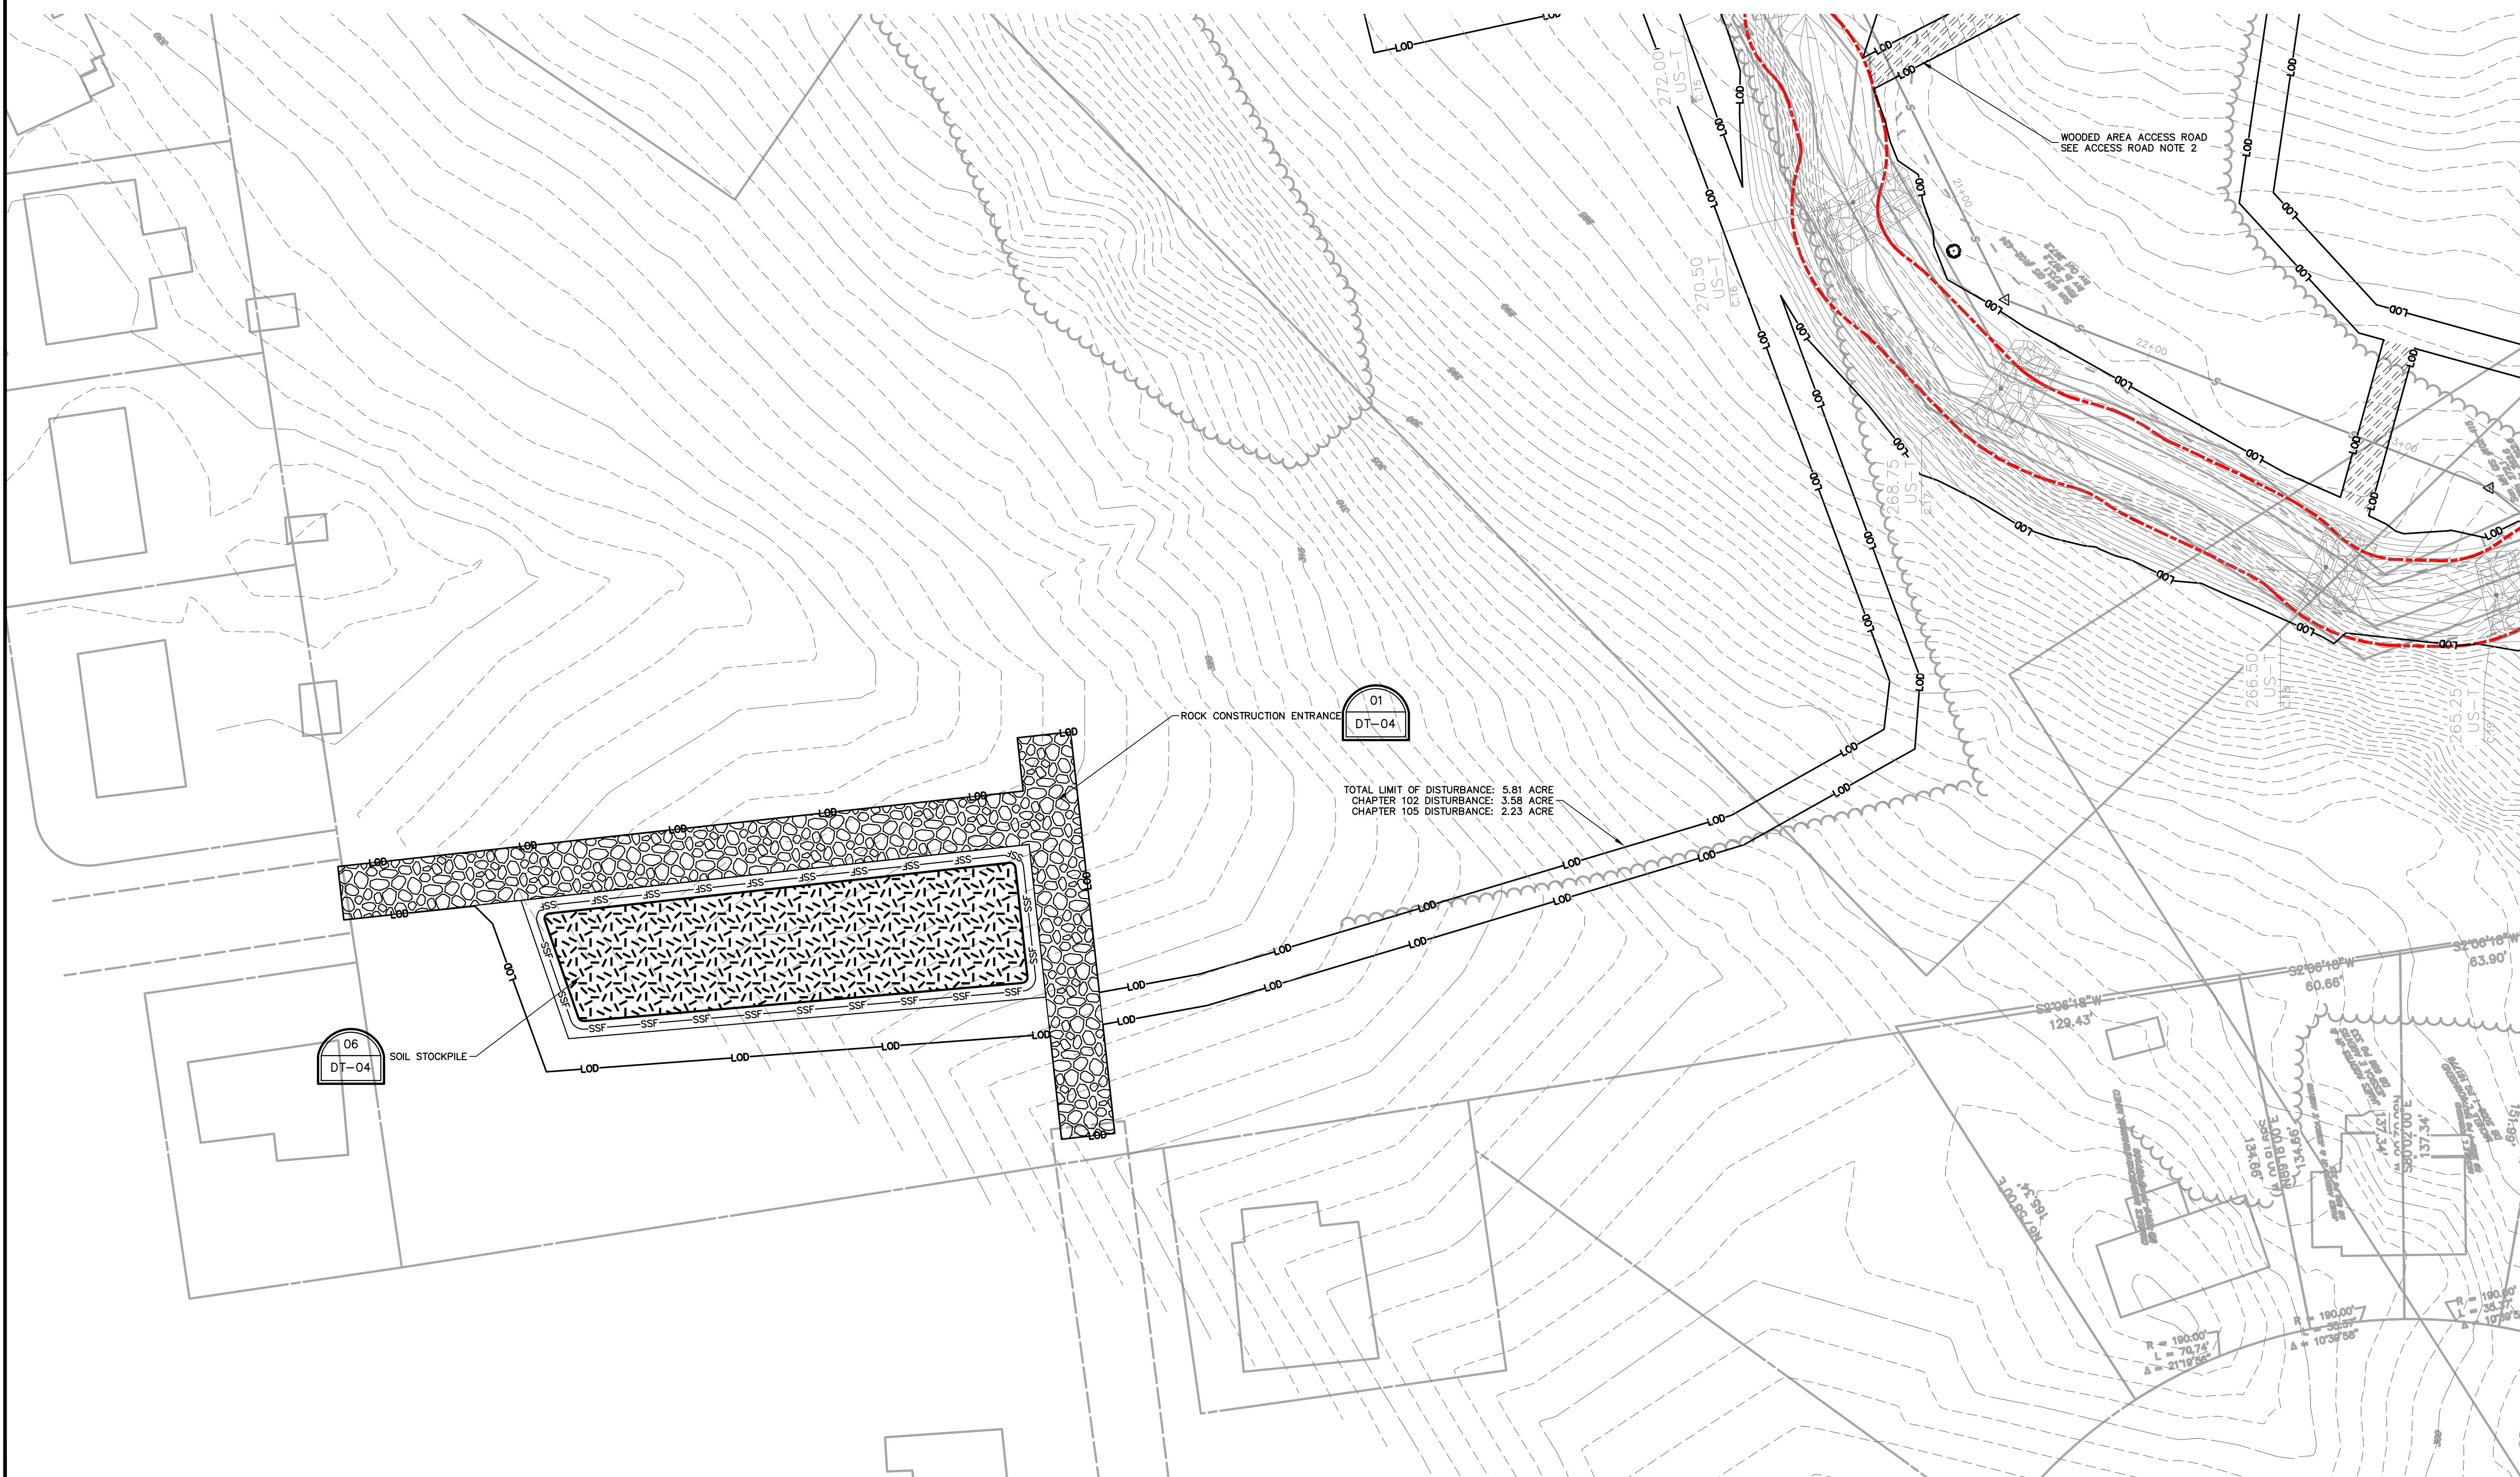

LIMIT OF DISTURBANCE LEGEND

----- LIMIT OF CHAPTER 105 DISTURBANCE

— L0D — LIMIT OF DISTURBANCE

ACCESS ROAD NOTES

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GRAPHIC SCALE
30' 15' 0' 30'
SCALE: 1" = 30'

FILE NAME: R009170.04.31.DWG | LAST UPDATED: 02/29/2025 | 11:59 AM | BY: SPOTW

25

CONSTRUCTION AND EARTHWORKS CONTRACT
FOR
SCULAC ROAD STREAM RESTORATION

4223 EASTON AVENUE
BETHLEHEM, PA 18020
NORTHAMPTON COUNTY
PENNSYLVANIA


The seal is circular with a rope-like border. The words "COMMONWEALTH OF PENNSYLVANIA" are written in a circle at the top. In the center, "REGISTERED" is above "PROFESSIONAL". Below that is a signature of "JAMES D. POWELL" over "10/29/2025". At the bottom, "ENGINEER" is above "PE094717".

PROJECT NUMBER:	R009170.043
DATE:	FEBRUARY 2022
WING SCALE:	AS SHOWN
MANAGER:	MATTHEW VANASKI

DESCRIPTION	CCCD COMMENTS	INSTRUCTABILITY REVIEW

NO.	DATE	REVISED	PEM
1	03/05/25		
2	10/01/25		
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ONTROL PLAN

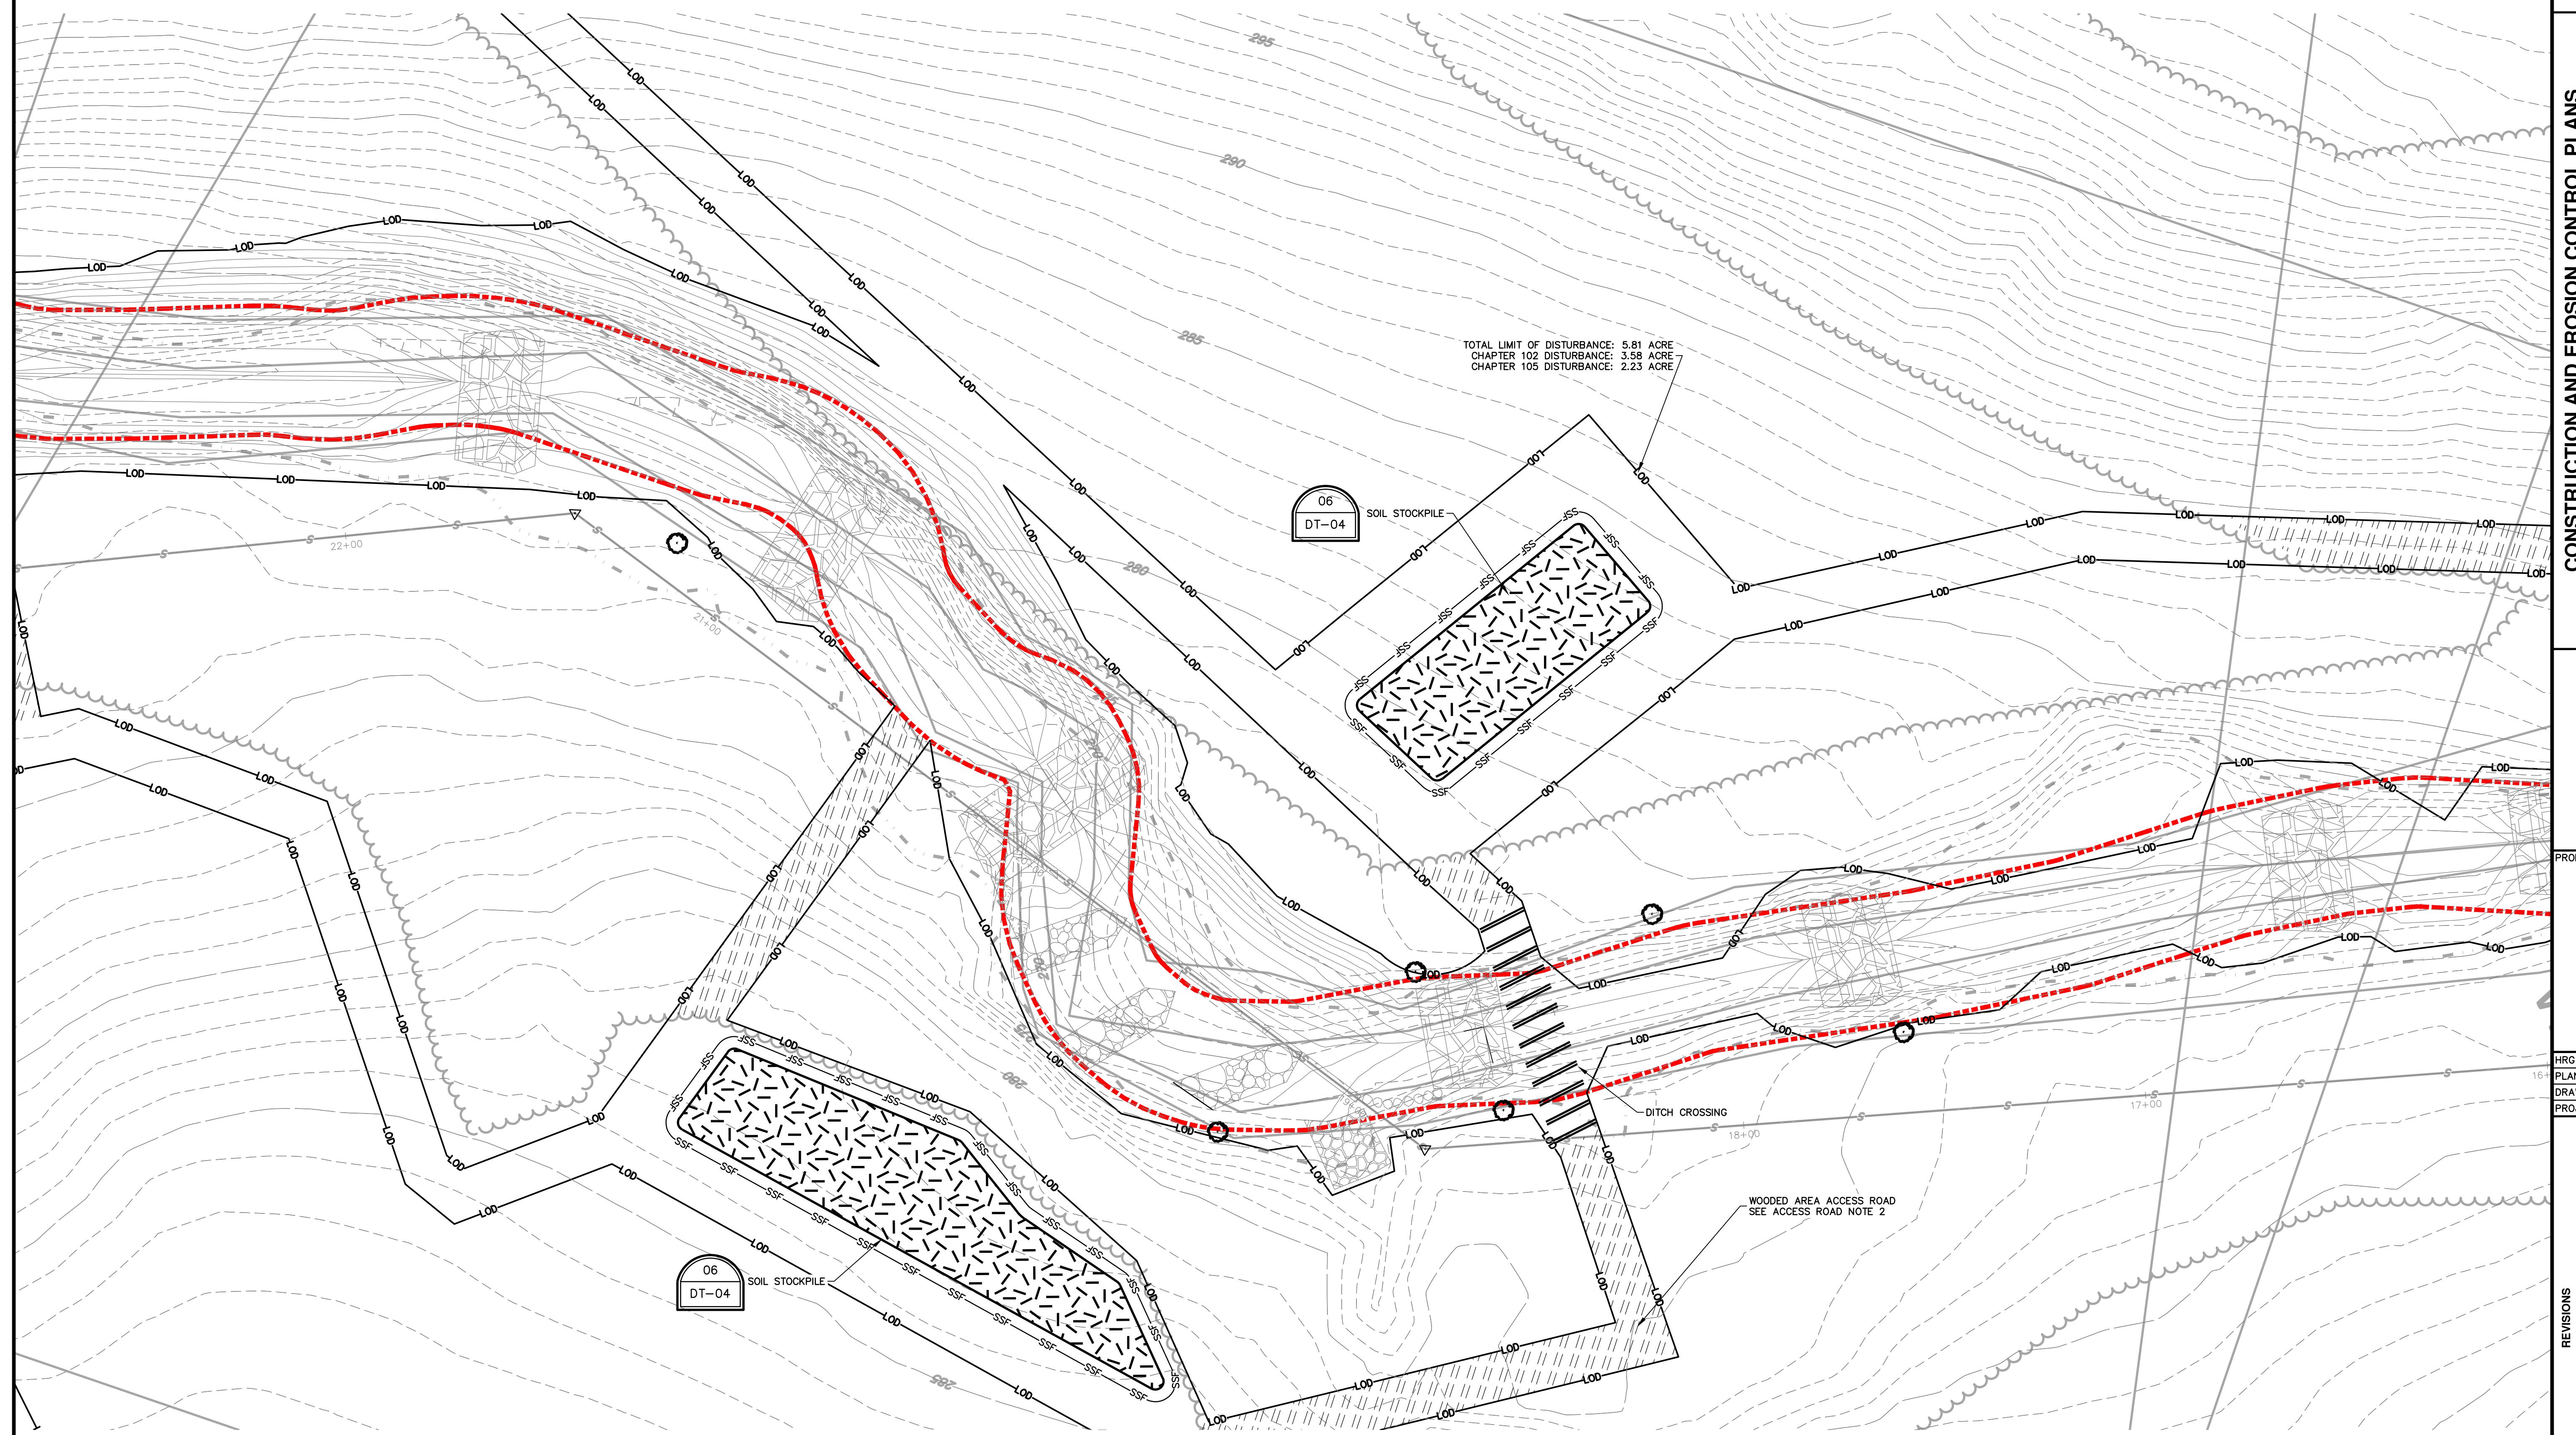

LIMIT OF DISTURBANCE LEGEND

----- LIMIT OF CHAPTER 105 DISTURBANCE

—LOD— LIMIT OF DISTURBANCE

ACCESS ROAD NOTES

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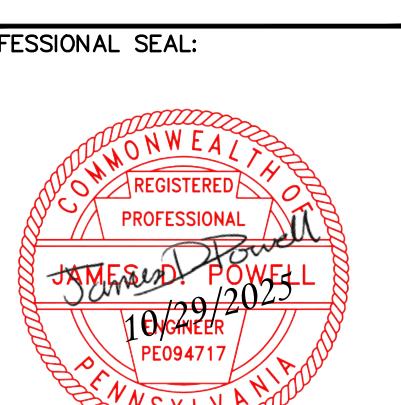
GRAPHIC SCALE

20' 10' 0' 20'

SCALE: 1" = 20'

SHEET: **ESC-03**

26




HRG PROJECT NUMBER: R009170.0431
PLAN DATE: FEBRUARY 2025
DRAWING SCALE: AS SHOWN
PROJ. MANAGER: MATTHEW VANASKIE

REVISIONS	NO.	DATE	DESCRIPTION
	1	03/05/25	REVISED PER NCCD COMMENTS
		10/01/25	REVISED PER CONSTRUCTIONABILITY REVIEW
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EROSION
CONTROL PLAN

SCHEET: ESC-04

27

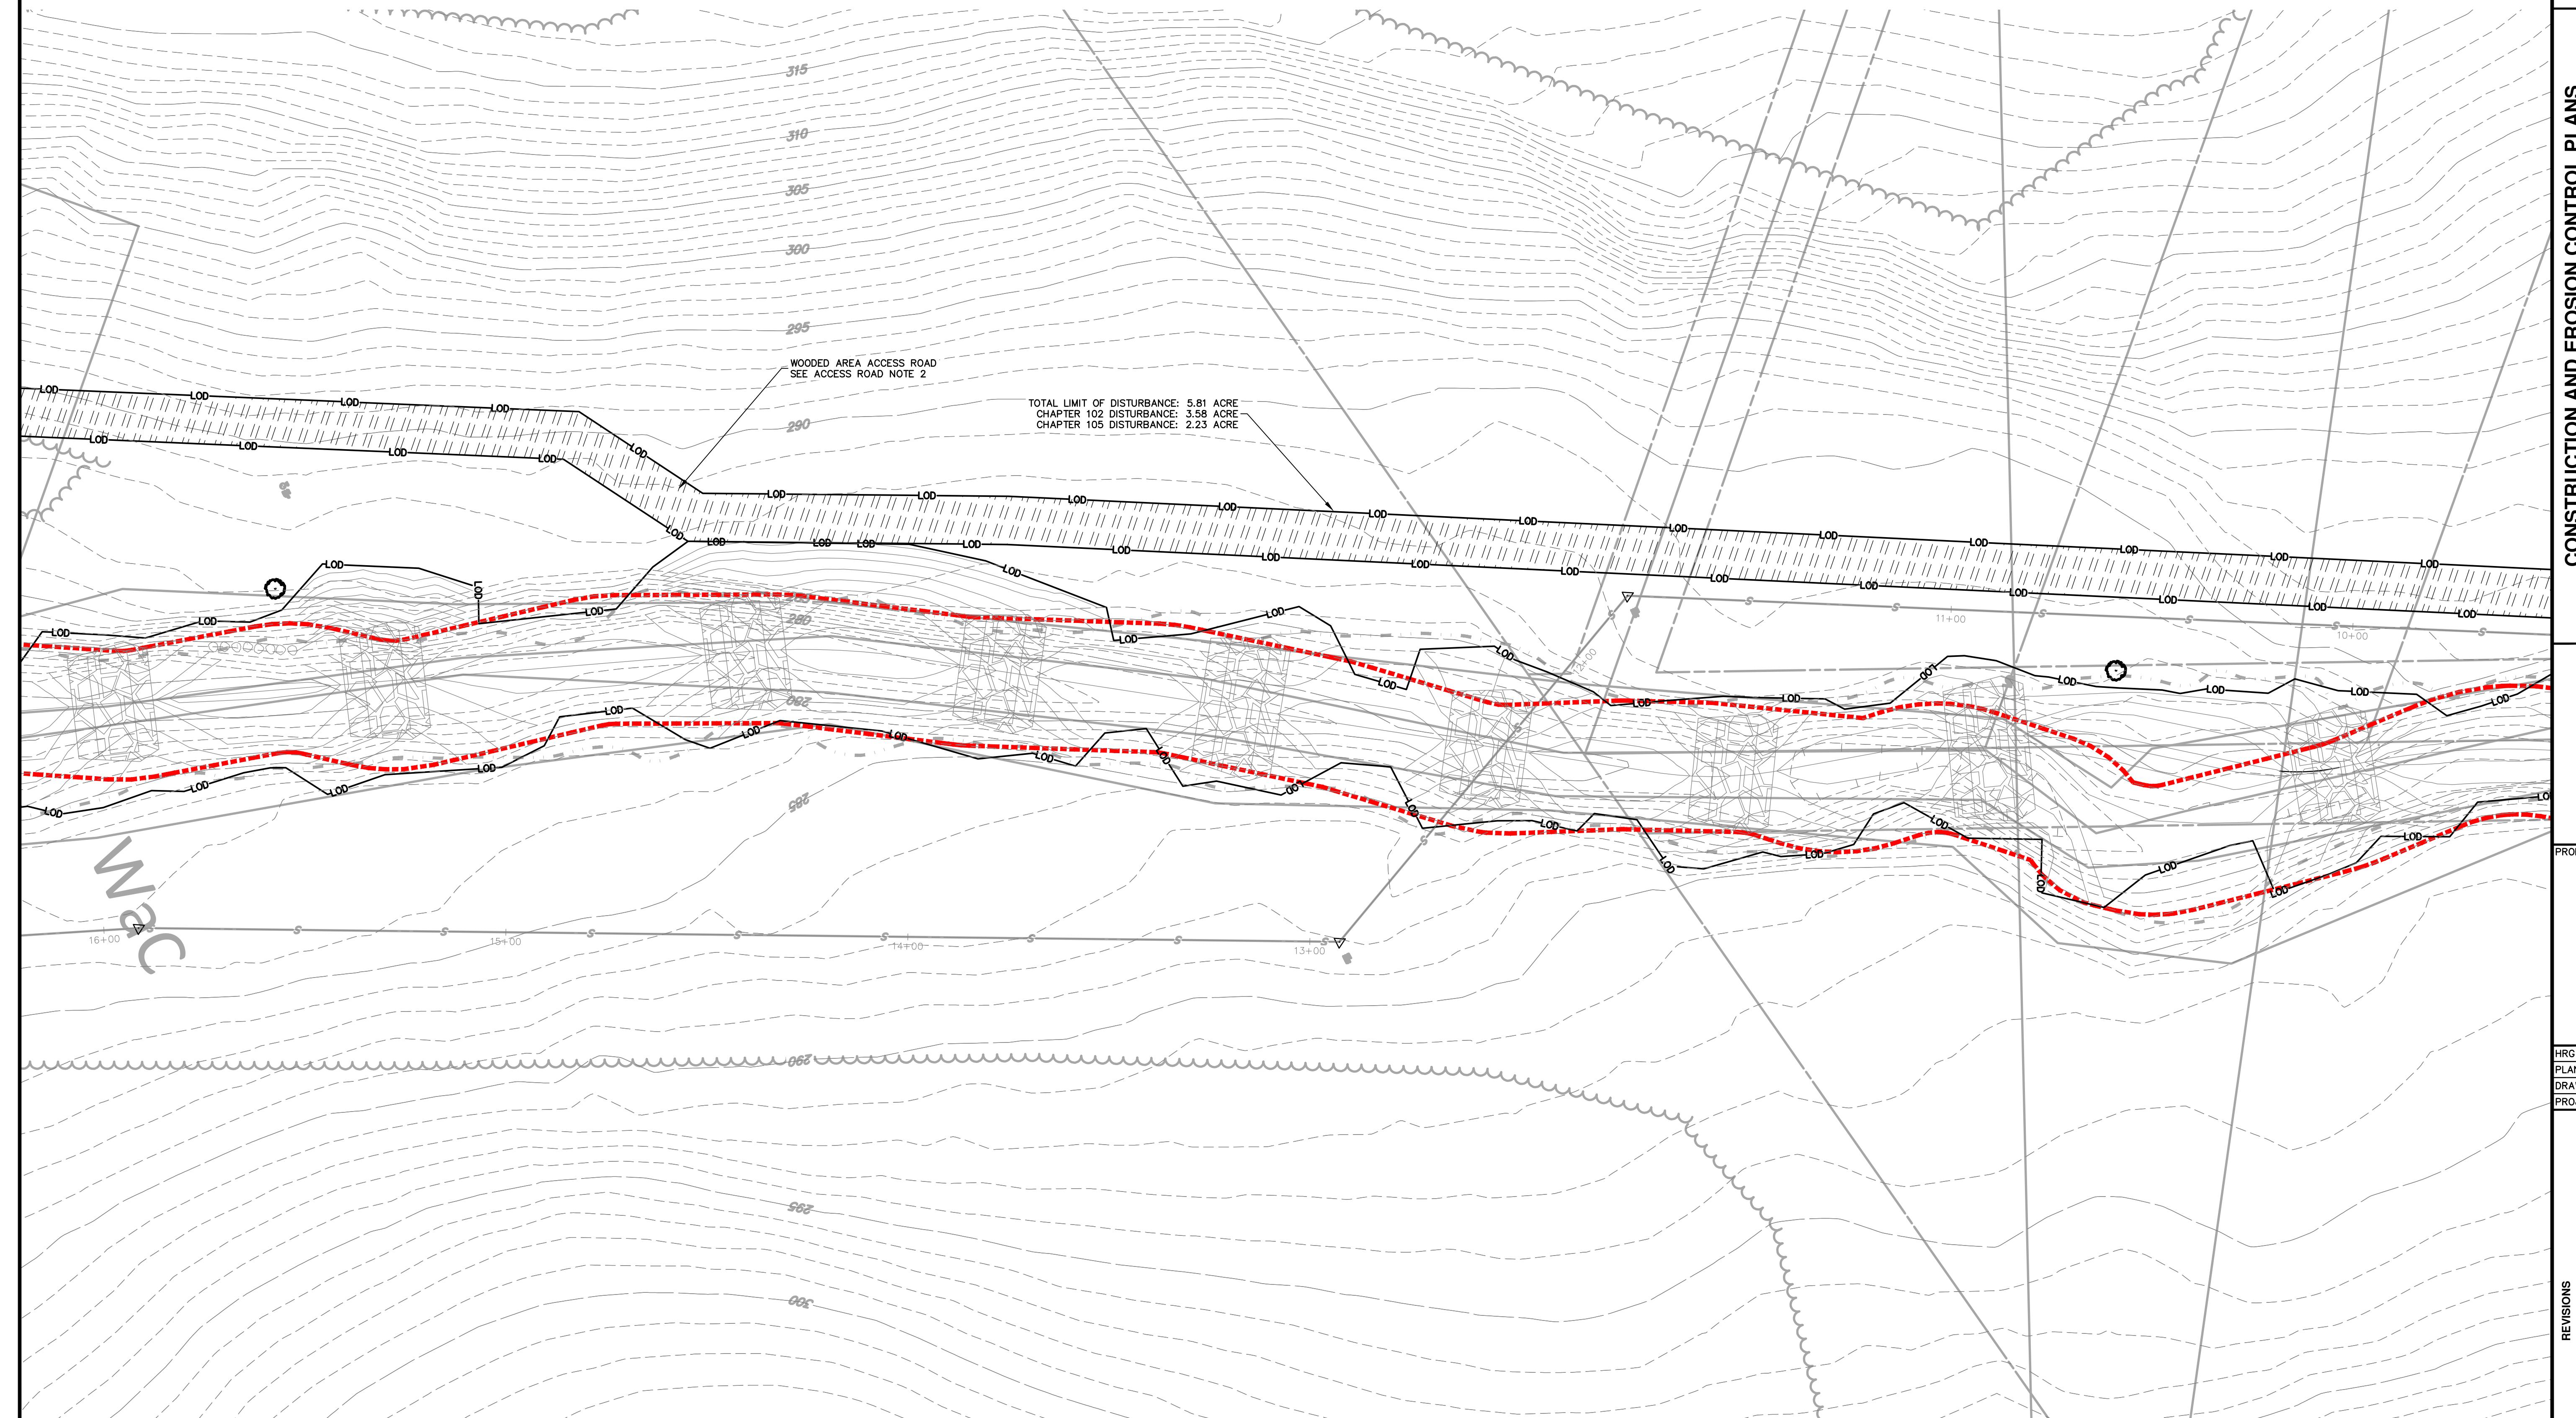

LIMIT OF DISTURBANCE LEGEND

----- LIMIT OF CHAPTER 105 DISTURBANCE

— LOD — LIMIT OF DISTURBANCE

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3. FOR SPECIFIC AREAS AS CALLED OUT ON PLANS, INSTALL TIMBER MATTING PER DETAIL ON SHEET DT-02.

GRAPHIC SCALE
20' 10' 0' 20'
SCALE: 1" = 20'

FILE NAME: ESC-04.DWG LAST PLACED 02/29/2025 11:59 AM BY SPINNELL

SCULAC ROAD STREAM RESTORATION
FOR
CONSTRUCTION

4225 EASTON AVENUE
BETHLEHEM, PA 18020

The seal is circular with a rope-like border. The words "COMMONWEALTH OF PENNSYLVANIA" are written in a circle at the top. In the center, "REGISTERED" is above "PROFESSIONAL". Below that is a signature of "JAMES D. POWELL" over "10/29/2025". At the bottom, "ENGINEER" is above "PE094717".


PROJECT NUMBER: R009170.043
DATE: FEBRUARY 2024
WING SCALE: AS SHOWN
MANAGER: MATTHEW VANASKIE

DESCRIPTION	CCD COMMENTS	CONSTRUCTABILITY REVIEW			

ET TITLE:
ROSION

ET: **ESC-05** | 28

28

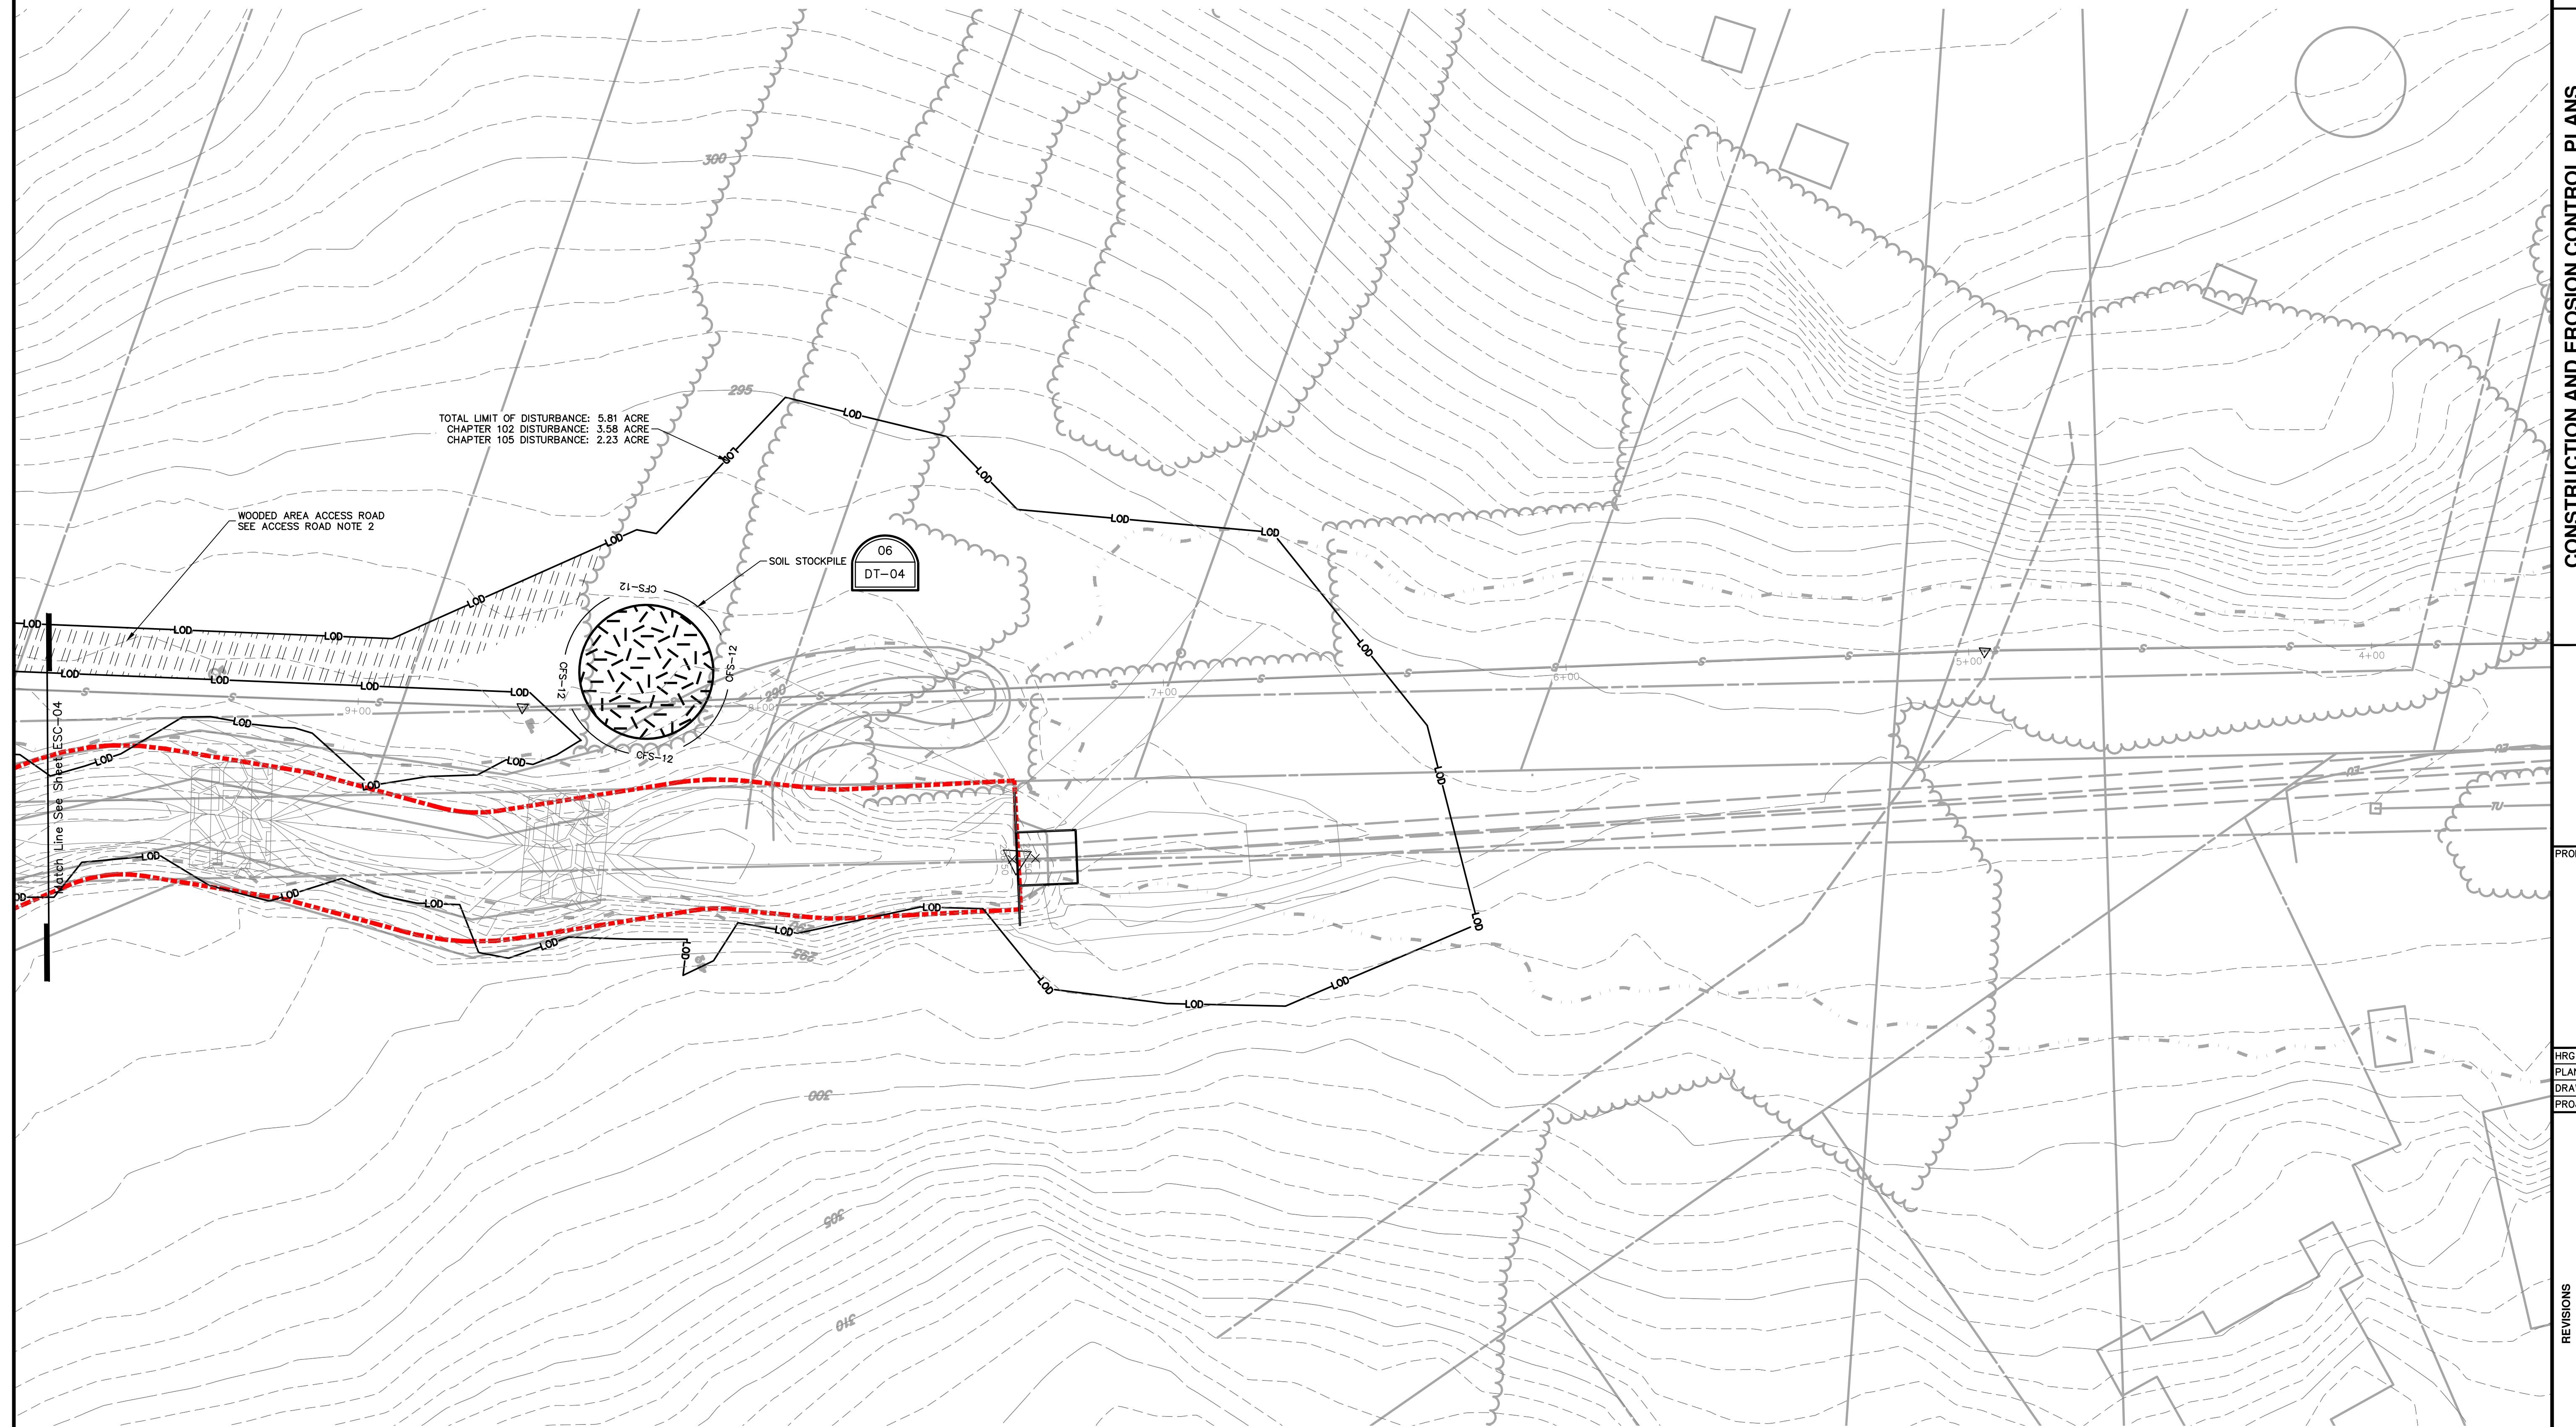

LIMIT OF DISTURBANCE LEGEND

----- LIMIT OF CHAPTER 105 DISTURBANCE

—LOD— LIMIT OF DISTURBANCE

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20' 10' 0'

SCALE: 1" = 20'

SHEET TITLE:
EROSION

SHEET: **ESC-05**

28

GENERAL EROSION CONTROL NOTES

- EROSION AND SEDIMENTATION CONTROLS MUST BE CONSTRUCTED, STABILIZED, AND FUNCTIONAL BEFORE GENERAL SITE DISTURBANCE WITHIN THE TRIBUTARY AREAS OF THESE CONTROLS.
- E&S BMPs SHALL REMAIN FUNCTIONAL AS SUCH UNTIL ALL AREAS TRIBUTARY TO THEM ARE PERMANENTLY STABILIZED OR UNTIL THEY ARE REPLACED BY ANOTHER BMP APPROVED BY THE NORTHAMPTON COUNTY CONSERVATION DISTRICT.
- ENVIRONMENTAL DUE DILIGENCE MUST BE PERFORMED TO DETERMINE IF THE FILL MATERIALS ASSOCIATED WITH THE PROJECT QUALIFY AS CLEAN FILL. ENVIRONMENTAL DUE DILIGENCE IS DEFINED AS: INVESTIGATIVE TECHNIQUES, INCLUDING, BUT NOT LIMITED TO, VISUAL PROPERTY INSPECTIONS, ELECTRONIC DATA BASE SEARCHES, REVIEW OF PROPERTY OWNERSHIP, REVIEW OF TITLE HISTORY, SANBORN MAPS, ENVIRONMENTAL ASSESSMENTS, TRANSPORTATION SYSTEM ANALYSIS, AND ENVIRONMENTAL ASSESSMENTS OR AUDITS. ANALYTICAL TESTING IS NOT A REQUIRED PART OF DUE DILIGENCE UNLESS VISUAL INSPECTION AND/OR REVIEW OF THE PAST LAND USE OF THE PROPERTY INDICATES THAT THE FILL MAY HAVE BEEN SUBJECTED TO A SPILL OR RELEASE OF A REGULATED SUBSTANCE. IF THE FILL MAY HAVE BEEN AFFECTED BY A SPILL OR RELEASE OF A REGULATED SUBSTANCE, IT MUST BE TESTED TO DETERMINE IF IT QUALIFIES AS CLEAN FILL. TESTING SHOULD BE PERFORMED IN ACCORDANCE WITH APPENDIX A OF THE DEPARTMENT'S POLICY "MANAGEMENT OF CLEAN FILL".
- AT LEAST 3 DAYS PRIOR TO STARTING ANY EARTH DISTURBANCE ACTIVITIES, OR EXPANDING INTO AN AREA PREVIOUSLY UNMARKED, THE PENNSYLVANIA ONE CALL SYSTEM INC. SHALL BE NOTIFIED AT 1-800-242-1776 FOR THE LOCATION OF EXISTING UNDERGROUND UTILITIES.
- ALL EARTH DISTURBANCE ACTIVITIES SHALL PROCEED IN ACCORDANCE WITH THE SEQUENCE PROVIDED ON THE PLAN DRAWINGS. DEVIATION FROM THAT SEQUENCE MUST BE APPROVED IN WRITING FROM THE REVIEWING AGENCY PRIOR TO IMPLEMENTATION.
- AREAS TO BE FILLED ARE TO BE CLEARED, GRUBBED, AND STRIPPED OF TOPSOIL TO REMOVE TREES, VEGETATION, ROOTS AND OTHER OBJECTIONABLE MATERIAL.
- CLEARING, GRUBBING, AND TOPSOIL STRIPPING SHALL BE LIMITED TO THOSE AREAS DESCRIBED IN EACH STAGE OF THE CONSTRUCTION SEQUENCE. GENERAL SITE CLEARING, GRUBBING AND TOPSOIL STRIPPING MAY NOT COMMENCE IN ANY STAGE OR PHASE OF THE PROJECT UNTIL THE E&S BMPS SPECIFIED BY THE BMP SEQUENCE FOR THAT STAGE OR PHASE HAVE BEEN INSTALLED AND ARE FUNCTIONING AS DESCRIBED IN THIS E&S PLAN.
- THE CONTRACTOR IS RESPONSIBLE FOR ENSURING THAT ANY MATERIAL BROUGHT ON SITE IS CLEAN FILL. FORM FP-001 MUST BE RETAINED BY THE PROPERTY OWNER FOR ANY FILL MATERIAL AFFECTED BY A SPILL OR RELEASE OF A REGULATED SUBSTANCE BUT QUALIFYING AS CLEAN FILL DUE TO ANALYTICAL TESTING.
- CLEAN FILL IS DEFINED AS: UNCONTAMINATED, NON-WATER SOLUBLE, NON-DECOMPOSABLE, INERT, SOLID MATERIAL. THE TERM INCLUDES SOIL, ROCK, STONE, DREDGED MATERIAL, USED ASPHALT, AND BRICK, BLOCK OR CONCRETE FROM CONSTRUCTION AND DEMOLITION ACTIVITIES THAT IS SEPARATE FROM OTHER WASTE AND IS RECOGNIZABLE AS SUCH. THE TERM DOES NOT INCLUDE MATERIALS PLACED IN OR ON THE WATERS OF THE COMMONWEALTH UNLESS OTHERWISE AUTHORIZED. (THE TERM USED ASPHALT DOES NOT INCLUDE MILLED ASPHALT OR ASPHALT THAT HAS BEEN PROCESSED FOR RE-USE.)
- ALL FILLS SHALL BE COMPACTION AS REQUIRED TO REDUCE EROSION, SLIPPAGE, SETTLEMENT, SUBSIDENCE OR OTHER RELATED PROBLEMS. FILL INTENDED TO SUPPORT BUILDINGS, STRUCTURES AND CONDUITS, ETC. SHALL BE COMPACTION IN ACCORDANCE WITH LOCAL REQUIREMENTS OR CODES.
- ALL EARTHER FILLS SHALL BE PLACED IN COMPACTION LAYERS NOT TO EXCEED 8 INCHES IN THICKNESS.
- FILL MATERIALS SHALL BE FREE OF FROZEN PARTICLES, BRUSH, ROOTS, SOD, LARGE STONES OR OTHER FOREIGN OR OBJECTIONABLE MATERIALS THAT WOULD INTERFERE WITH OR PREVENT CONSTRUCTION OF SATISFACTORY FILLS.
- FROZEN MATERIALS OR SOFT, MUCKY, OR HIGHLY COMPRESSIBLE MATERIALS SHALL NOT BE INCORPORATED INTO FILLS.
- FILL SHALL NOT BE PLACED ON SATURATED OR FROZEN SURFACES.
- SEEPS OR SPRINGS ENCOUNTERED DURING CONSTRUCTION SHALL BE HANDLED IN ACCORDANCE WITH THE STANDARD AND SPECIFICATION FOR SUBSURFACE DRAIN OR OTHER APPROVED METHOD.
- AFTER FINAL SITE STABILIZATION HAS BEEN ACHIEVED, TEMPORARY EROSION AND SEDIMENTATION CONTROL MUST BE REMOVED. AREAS DISTURBED DURING REMOVAL OF THE CONTROLS MUST BE STABILIZED.
- VEHICLES MAY ONLY ENTER AND EXIT WITHIN THE PROJECT LIMIT OF DISTURBANCE.
- STOCK PILE HEIGHTS MUST NOT EXCEED 35 FEET NOR SHALL THE SITE SLOPES EXCEED 2:1. STOCK PILES SHALL BE LOCATED ON SITE BY THE CONTRACTOR AT LOCATIONS APPROVED BY THE COUNTY CONSERVATION DISTRICT.
- UNTIL THE SITE IS STABILIZED, ALL EROSION AND SEDIMENTATION CONTROLS MUST BE MAINTAINED PROPERLY. MAINTENANCE MUST INCLUDE INSPECTIONS OF ALL EROSION AND SEDIMENTATION CONTROLS AFTER EACH STORM EVENT AND ON A WEEKLY BASIS. ALL PREVENTATIVE AND REMEDIAL MAINTENANCE WORK, INCLUDING CLEANOUT, REPAIR, REPLACEMENT, REGRADING, RESEEDING, REMULCHING, AND RETENNETING MUST BE PERFORMED IMMEDIATELY.
- IMMEDIATELY AFTER EARTH DISTURBANCE ACTIVITIES CEASE IN ANY AREA OR SUBAREA OF THE PROJECT, OPERATOR SHALL STABILIZE ALL DISTURBED AREAS DURING NON-GERMINATING MONTHS. MULCH OR PROTECTIVE BLANKETING SHALL BE APPLIED AS DESCRIBED IN THE DRAWING, AREAS NOT AT FINISHED GRADE, WHICH WILL BE REACTIVATED WITHIN 1 YEAR, MAY BE STABILIZED IN ACCORDANCE WITH THE TEMPORARY STABILIZATION SPECIFICATIONS. THOSE AREAS WHICH WILL NOT BE REACTIVATED WITHIN 1 YEAR SHALL BE STABILIZED IN ACCORDANCE WITH THE PERMANENT STABILIZATION SPECIFICATIONS.
- THE CONTRACTOR WILL BE RESPONSIBLE FOR THE PROPER CONSTRUCTION, STABILIZATION, AND MAINTENANCE OF ALL EROSION AND SEDIMENTATION CONTROLS AND RELATED ITEMS INCLUDED ON THIS PLAN.
- SHOULD ANY MEASURES CONTAINED WITHIN THIS PLAN PROVE INCAPABLE OF ADEQUATELY REMOVING SEDIMENT FROM ON-SITE FLOWS PRIOR TO DISCHARGE OR STABILIZING THE SURFACES INVOLVED, ADDITIONAL MEASURES MUST BE IMMEDIATELY IMPLEMENTED BY THE APPLICANT TO ELIMINATE ALL SUCH PROBLEMS.
- SHOULD UNFORESEEN EROSION CONDITIONS DEVELOP DURING CONSTRUCTION, THE CONTRACTOR SHALL TAKE ACTION TO REMEDY SUCH CONDITIONS AND TO PREVENT DAMAGE TO ADJACENT PROPERTIES AS A RESULT OF INCREASED RUNOFF AND/OR SEDIMENT DISPLACEMENT. STOCKPILES OF WOOD CHIPS, HAY BALES, CRUSHED STONE AND OTHER MULCHES SHALL BE HELD IN READINESS TO DEAL IMMEDIATELY WITH EMERGENCY PROBLEMS OF EROSION.
- THE CONTRACTOR SHALL BE RESPONSIBLE FOR PROTECTION OF EXISTING TREES AND SHRUBS TO REMAIN FROM UNNECESSARY DAMAGE.
- A COPY OF THE APPROVED EROSION AND SEDIMENTATION CONTROL PLANS MUST BE POSTED AT THE CONSTRUCTION SITE AT ALL TIMES IN ACCORDANCE WITH THE LAWS OF THE COMMONWEALTH OF PENNSYLVANIA.
- THE CONTRACTOR IS ADVISED TO BECOME THOROUGHLY FAMILIAR WITH THE REGULATIONS OF APPENDIX 64, EROSION CONTROLS AND REGULATIONS, TITLE 25, PART 1, DEPARTMENT OF ENVIRONMENTAL RESOURCES, SUB-PART A, PROTECTION OF NATURAL RESOURCES, ARTICLE III, WATER RESOURCES, CHAPTER 102, EROSION CONTROL.
- THE EROSION AND SEDIMENT CONTROL PLAN AND PLAN NARRATIVE ARE FOR THE INSTALLATION, MAINTENANCE, AND MEASURES TO CONTROL EROSION AND SEDIMENTATION ONLY. REFER TO APPROPRIATE PLAN SHEETS FOR ALL UTILITY, STORMWATER, SITE IMPROVEMENT AND OTHER CONSTRUCTION INFORMATION.
- THE CONTRACTOR WILL BE RESPONSIBLE FOR THE REMOVAL OF ANY EXCESS MATERIAL AND MAKE SURE THE SITE MEETS THE EXIGENCIES OF AN APPROVED EROSION AND SEDIMENT CONTROL PLAN THAT MEETS THE CONDITIONS OF CHAPTER 102, AND/OR OTHER STATE OR FEDERAL REGULATIONS. THE DISPOSAL SITE SHALL BE LOCATED GREATER THAN 100 FEET FROM ANY WETLAND, LOCATED OUTSIDE THE FLOODPLAIN. IT IS THE CONTRACTOR'S RESPONSIBILITY TO CONTACT THE APPROPRIATE CONSERVATION DISTRICT TO ENSURE THAT THE DISPOSAL SITE IS AN APPROVED FACILITY.
- ALL BUILDING MATERIALS AND WASTES MUST BE REMOVED FROM THE SITE AND RECYCLED OR DISPOSED IN ACCORDANCE WITH THE DEPARTMENT'S SOLID WASTE MANAGEMENT REGULATIONS § AT 25 PA. CODE 260.1 ET. SEQ., § 287.1 ET. SEQ. § 271.1 ET. SEQ. NO BUILDING MATERIAL AND OR WASTES OR UNUSED BUILDING MATERIALS SHALL BE BURIED, DUMPED, OR DISCHARGED AT THE SITE.
- THE CONTRACTOR SHALL TAKE ALL REASONABLE STEPS TO MINIMIZE OR PREVENT ANY DISCHARGE IN VIOLATION OF THIS PERMIT WHICH HAS A REASONABLE LIKELIHOOD OF ADVERSELY AFFECTING HUMAN HEALTH OR ENVIRONMENT.

CONSTRUCTION SEQUENCE

- ALL MUD, DIRT AND DEBRIS TRACKED INTO EXISTING ROADS FROM THESE SITES SHALL BE PROMPTLY REMOVED BY THE CONTRACTOR. WASHING OF SUCH WITH WATER SHALL NOT BE PERMITTED.
- FAILURE TO CORRECTLY INSTALL E&S BMPs, FAILURE TO PREVENT SEDIMENT-LADEN RUNOFF FROM LEAVING THE CONSTRUCTION SITE, OR FAILURE TO TAKE IMMEDIATE CORRECTIVE ACTION TO RESOLVE FAILURE OF E&S BMPs MAY RESULT IN ADMINISTRATIVE, CIVIL AND/OR CRIMINAL PENALTIES BEING INSTITUTED BY THE DEPARTMENT AS DESCRIBED IN SECTION 609 OF THE PENNSYLVANIA CLEAN STREAMS LAW. THE CLEAN STREAMS LAW PROVIDES FOR UP TO \$10,000 PER DAY CIVIL PENALTIES, UP TO \$10,000 IN SUMMARY CRIMINAL PENALTIES, AND UP TO \$25,000 IN MISDEMEANOR CRIMINAL PENALTIES FOR EACH VIOLATION.
- ALL CHANNELS SHALL BE KEPT FREE OF OBSTRUCTIONS INCLUDING BUT NOT LIMITED TO, ROCKS, LEAVES, WOODY DEBRIS, ACCUMULATED SEDIMENT, EXCESS VEGETATION, AND CONSTRUCTION MATERIAL/WASTES.
- UNDERGROUND UTILITIES CUTTING THROUGH ANY ACTIVE CHANNEL SHALL BE IMMEDIATELY BACKFILLED AND THE CHANNEL RESTORED TO ITS ORIGINAL CROSS-SECTION AND PROTECTIVE LINING. ANY BASE FLOW WITHIN THE CHANNEL SHALL BE CONVEYED PAST THE WORK AREA IN THE MANNER DESCRIBED IN THIS PLAN UNTIL SUCH RESTORATION IS COMPLETE.
- ANY PLACEMENT OF CLEAN FILL THAT HAS BEEN AFFECTED BY A SPILL OR RELEASE OF A REGULATED SUBSTANCE MUST USE FORM FP-001 TO CERTIFY THE ORIGIN OF THE FILL MATERIAL AND THE RESULTS OF THE ANALYTICAL TESTING TO QUALIFY THE MATERIAL AS CLEAN FILL. FORM FP-001 MUST BE RETAINED BY THE OWNER OF THE PROPERTY RECEIVING THE FILL.
- ALL ACCESS TO THE WORK AREA SHALL BE ACCESSED FROM THE DESIGNATED ACCESS POINTS MARKED ON THE PLANS.
- AT THE END OF EACH CONSTRUCTION DAY, STABILIZE ANY DISTURBED AREAS. ALL STOCKPILED EXCAVATION MATERIAL SHALL BE HAULED OFFSITE AT THE END OF EACH WORKDAY TO AN APPROVED STOCKPILING LOCATION LOCATED OUTSIDE OF THE FLOODPLAIN OF ANY WATERWAY.
- CLEARING IS TO COMMENCE ONLY IN THE IMMEDIATE VICINITY OF PROPOSED GRADING TO LIMIT EARTH DISTURBANCE WITHIN THE CHANNEL TO GREATEST EXTENT POSSIBLE. CLEARING THAT MUST PROCEED PRIOR TO GRADING WORK REQUIRES STUMPS BE CUT AND REMAIN IN PLACE UNTIL PROPOSED GRADING WORK OCCURS IN THAT AREA. ANY DISTURBANCE IS TO BE STABILIZED IMMEDIATELY.
- INSTALL UPPER PORTION OF E&S AND ACCESS ROADS FROM LEHIGH AVE. TO MAIN CHANNEL CROSSING AND APPROXIMATELY STREAM SECTION 17+25. DO NOT PROCEED PAST THIS STREAM CROSSING TO CONSTRUCT CHANNEL UNTIL REMAINING PORTION OF E&S PLAN AND ACCESS HAS BEEN INSTALLED.
- BEGINNING AT UPPER LIMITS OF RESTORATION PLANS, SET-UP DEWATERING PRACTICE, DEMO AND PREPARED SUBGRADE AROUND PROPOSED DROP STRUCTURE. ALL CONSTRUCTION DEBRIS CREATED FROM DEMO OF EXISTING STRUCTURE SHALL BE PROMPTLY REMOVED FROM SITE AND DEPOSED AT AN APPROVED FACILITY.
- PREP TWIN PIPES AND INSTALL THE PRE-CAST DROUET STRUCTURE. PRIOR TO MOVING ON GRADE RETENTION BERM AND CATCHMENT AREA UPSTREAM OF STRUCTURE. ALL EARTH DISTURBANCE SHALL BE STABILIZED IMMEDIATELY AFTER INSTALLATION OF THE DROUET STRUCTURE.
- INSTALL PROPOSED SINKHOLE PROTECTION IN ACCORDANCE WITH DETAILS AND IMMEDIATELY STABILIZE THE AREA.
- RESET DEWATERING AND COFFERDAMS FROM STATION 28+00 DOWNSTREAM TO STATION 21+47. BEGIN CONSTRUCTION OF PROPOSED CHANNEL GRADING AND STRUCTURE INSTALLATION IN A DOWNSTREAM FASHION.
- UPON COMPLETION OF THIS SECTION PERMANENTLY STABILIZE ALL COMPLETED AREAS. REMOVE STOCKPILED MATERIALS ASSOCIATED WITH UPSTREAM WORK BUT MAINTAIN ACCESS ROADS UNTIL SUBSTANTIAL COMPLETION OF PROJECT.
- RESET DEWATERING SETUP FROM 21+47 UPSTREAM OF MAINSTREAM CROSSING AT STATION 17+25. PROCEED WITH INSTALLATION OF CHANNEL RESTORATION PLAN FROM 21+47 TO 17+25 IN DOWNSTREAM FASHION.
- ONCE COMPLETE PERMANENTLY STABILIZE ALL WORK IN THIS SECTION. STREAM CROSSING IS TO BE MAINTAINED THROUGH REMAINDER OF CONSTRUCTION.
- RESET THE REMAINDER OF PROPOSED E&S PLAN AND ACCESS ROAD UNTIL STATION 15+50. INSTALL THE ROADWAY FROM APPROXIMATELY STATION 15+50 UNTIL THE APPROXIMATELY STATION 15+50. IMPORT OTHER SOILS FOR E&S PLAN AND ACCESS ROAD UNTIL LATER.
- PROCEED WITH IMPLEMENTATION OF CHANNEL RESTORATION PLAN IN DEWATERING SET-UP IN PLACE BETWEEN STATION 17+25 TO 15+50. AFTER WORK IS COMPLETE IMMEDIATELY IMPLEMENT ALL PERMANENT STABILIZATION MEASURES.
- INSTALL CONCRETE ENCASEMENT OF THE SANITARY SEWER LINE IN THIS REACH AS PRESCRIBED ON PLANS AND BACKFILL PRIOR TO FINAL GRADING.
- RE-SET DEWATERING CONTROL FROM STATION 15+50 DOWNSTREAM TO APPROXIMATELY STATION 13+25. INSTALL CHANNEL RESTORATION PLAN IN DOWNSTREAM FASHION IMMEDIATELY AFTER IMPLEMENTATION OF PROPOSED CONDITIONS PERMANENTLY STABILIZE ALL DISTURBED AREAS IN THIS SECTION.
- RESET DEWATERING CONTROL FROM STATION 13+25 TO APPROXIMATELY STATION 13+25. PROCEED WITH IMPLEMENTATION OF PROPOSED CHANNEL RESTORATION PLANS IN DOWNSTREAM FASHION. ONCE COMPLETE PERMANENTLY STABILIZE ALL DISTURBED AREAS IN THIS SECTION.
- PRIOR TO PROCEEDING WITH DOWNSTREAM RESTORATION CLEAN UP AND REMOVE ALL STOCKPILED MATERIALS ASSOCIATED WITH PRIOR WORK AND DISPOSE OF AT AN APPROVED FACILITY.
- INSTALL THE TEMPORARY TIMBER MAT ACCESS ROAD AS PROPOSED TO ACCESS STREAM WORK FROM SECTION 8+50 TO 4+00. INSTALL BLAZE ORANGE CONSTRUCTION FENCE IMMEDIATELY TO PREVENT PEDESTRIAN ACCESS TO THE WORK AREA.
- PERFORM SELECT TREE REMOVAL OF TRIPLE SYCAMORES PRIOR TO DISTURBING ANY OF THE STREAM RESTORATION GRADING AREA. REMOVE OR STOCKPILE MATERIALS APPROPRIATE TO CONTRACTOR MATERIAL PLANNING.
- ONCE SELECT REMOVAL OF TRIPLE SYCAMORES IS COMPLETE, PROCEED WITH PROPOSED CHANNEL RESTORATION WORK FROM 8+50 THROUGH 4+00 IN DOWNSTREAM FASHION. PERMANENTLY STABILIZE ALL DISTURBED AREAS IMMEDIATELY AFTER IMPLEMENTATION.
- RE-SET DEWATERING AND FINISHED PROPOSED RESTORATION CONSTRUCTION FROM 4+50 TO 0+00.
- IMPLEMENT SANITARY SEWER ENCASEMENT ACTIVITIES AND BACKFILL PRIOR TO FINAL GRADING. PERMANENTLY STABILIZE ALL AREAS THROUGHOUT CHANNEL RESTORATION AREA.
- SCHEDULE A SUBSTANTIAL SITE INSPECTIONS WITH ENGINEER AND ADDRESS AND CORRECT DEFICIENCIES PRIOR TO REMOVAL OF E&S AND ACCESS ROADS.
- AT ACCEPTANCE OF STREAM RESTORATION REMOVE ALL STOCKPILED MATERIALS AND PROCEED WITH INSTALLATION OF THE FINAL LANDSCAPE PLAN. PRIOR TO INSTALLATION OF LANDSCAPE PLAN REVIEW SITE AND PLANTING AREAS WITH THE ENGINEER.
- ONCE FINAL LANDSCAPE HAS BEEN INSTALLED PROCEED WITH REMOVAL OF E&S AND ACCESS ROADS TO RESTORE TEMPORARY ACCESS AREAS TO ORIGINAL CONDITION. ANY MULCH OR TIMBER MATS NEED TO BE REMOVED FROM SITE AND DISPOSED OF IN AN APPROVED MANNER.
- ANY ACCESS ROADS IN AGRICULTURAL FIELDS MUST BE INSPECTED FOR COMPACTION AND RIPPED TO RESTORE SOIL CONDITIONS TO PRE-CONSTRUCTION STATE.
- STABILIZE ALL ACCESS ROADS IN ACCORDANCE WITH PLANS AND DEMOBILIZE FROM SITE.

STABILIZATION NOTES

- UPON FINAL COMPLETION OF AN EARTH DISTURBANCE ACTIVITY OR ANY STAGE OR PHASE OF AN ACTIVITY, THE SITE SHALL IMMEDIATELY HAVE TOPSOIL RESTORED, REPLACED, OR AMENDED, SEEDED, MULCHED OR OTHERWISE PERMANENTLY STABILIZED AND PROTECTED FROM ACCELERATED EROSION AND SEDIMENTATION.
- E&S BMPs SHALL BE IMPLEMENTED AND MAINTAINED UNTIL THE PERMANENT STABILIZATION IS COMPLETED. ONCE PERMANENT STABILIZATION HAS BEEN ESTABLISHED, THE TEMPORARY E&S BMPs SHALL BE REMOVED. ANY AREAS DISTURBED IN THE ACT OF REMOVING TEMPORARY E&S BMPs SHALL BE PERMANENTLY STABILIZED UPON COMPLETION OF THE TEMPORARY E&S BMP REMOVAL ACTIVITY.
- FOR AN EARTH DISTURBANCE ACTIVITY OR ANY STAGE OR PHASE OF AN ACTIVITY TO BE CONSIDERED PERMANENTLY STABILIZED, THE DISTURBED AREAS SHALL BE COVERED WITH A MINIMUM UNIFORM 70% PERENNIAL VEGETATIVE COVER, WITH A DENSITY CAPABLE OF RESISTING ACCELERATED EROSION AND SEDIMENTATION OR AN ACCEPTABLE BMP WHICH TEMPORARILY MINIMIZES ACCELERATED EROSION AND SEDIMENTATION.
- UPON TEMPORARY CESSION OF AN EARTH DISTURBANCE ACTIVITY OR ANY STAGE OR PHASE OF AN ACTIVITY WHERE A CESSION OF EARTH DISTURBANCE ACTIVITIES WILL EXIST, 40% OF THE SITE SHALL BE IMMEDIATELY SEDED, MULCHED OR OTHERWISE PROTECTED FROM ACCELERATED EROSION AND SEDIMENTATION PENDING FUTURE EARTH DISTURBANCE ACTIVITIES.
- FOR AN EARTH DISTURBANCE ACTIVITY OR ANY STAGE OR PHASE OF AN ACTIVITY TO BE CONSIDERED PERMANENTLY STABILIZED, THE DISTURBED AREAS SHALL BE COVERED WITH A MINIMUM UNIFORM 70% PERENNIAL VEGETATIVE COVER, WITH A DENSITY CAPABLE OF RESISTING ACCELERATED EROSION AND SEDIMENTATION OR AN ACCEPTABLE BMP WHICH TEMPORARILY MINIMIZES ACCELERATED EROSION AND SEDIMENTATION.
- AN EROSION CONTROL BLANKET WILL BE INSTALLED ON ALL DISTURBED SLOPES 3:1 OR STEEPER. ALL AREAS OF CONCENTRATED FLOWS, AND DISTURBED AREAS WITHIN 50' OF WATERS OF THE COMMONWEALTH.
- AREAS WHICH ARE TO BE TOPSOILED SHALL BE SCARIFIED TO A MINIMUM DEPTH OF 3 TO 5 INCHES AND 6 TO 12 INCHES ON COMPACTED SOILS PRIOR TO PLACEMENT OF TOPSOIL. AREAS TO BE VEGETATED SHALL HAVE A MINIMUM 6 INCHES OF TOPSOIL IN PLACE PRIOR TO SEEDING AND MULCHING.
- ALL GRADED AREAS SHALL BE PERMANENTLY STABILIZED IMMEDIATELY UPON REACHING FINISHED GRADE. CUT SLOPES IN COMPETENT BEDROCK AND ROCK FILLS NEED NOT BE VEGETATED.
- ALL EARTHWORK IS TO BE ACCOMPLISHED DURING DRY WEATHER DUE TO THE EPHERMAL NATURE OF THE TRIBUTARY. ALL DISTURBANCES SHALL BE STABILIZED BEFORE ANY EXPECTED FLOW IN THE TRIBUTARY.
- THE CONTRACTOR WILL BE RESPONSIBLE FOR THE PROPER CONSTRUCTION, STABILIZATION, AND MAINTENANCE OF ALL EROSION AND SEDIMENTATION CONTROLS AND RELATED ITEMS INCLUDED ON THIS PLAN.
- SHOULD ANY MEASURES CONTAINED WITHIN THIS PLAN PROVE INCAPABLE OF ADEQUATELY REMOVING SEDIMENT FROM ON-SITE FLOWS PRIOR TO DISCHARGE OR STABILIZING THE SURFACES INVOLVED, ADDITIONAL MEASURES MUST BE IMMEDIATELY IMPLEMENTED BY THE APPLICANT TO ELIMINATE ALL SUCH PROBLEMS.
- SHOULD UNFORESEEN EROSION CONDITIONS DEVELOP DURING CONSTRUCTION, THE CONTRACTOR SHALL TAKE ACTION TO REMEDY SUCH CONDITIONS AND TO PREVENT DAMAGE TO ADJACENT PROPERTIES AS A RESULT OF INCREASED RUNOFF AND/OR SEDIMENT DISPLACEMENT. STOCKPILES OF WOOD CHIPS, HAY BALES, CRUSHED STONE AND OTHER MULCHES SHALL BE HELD IN READINESS TO DEAL IMMEDIATELY WITH EMERGENCY PROBLEMS OF EROSION.
- THE CONTRACTOR SHALL BE RESPONSIBLE FOR PROTECTION OF EXISTING TREES AND SHRUBS TO REMAIN FROM UNNECESSARY DAMAGE.
- A COPY OF THE APPROVED EROSION AND SEDIMENTATION CONTROL PLANS MUST BE POSTED AT THE CONSTRUCTION SITE AT ALL TIMES IN ACCORDANCE WITH THE LAWS OF THE COMMONWEALTH OF PENNSYLVANIA.
- THE CONTRACTOR IS ADVISED TO BECOME THOROUGHLY FAMILIAR WITH THE REGULATIONS OF APPENDIX 64, EROSION CONTROLS AND REGULATIONS, TITLE 25, PART 1, DEPARTMENT OF ENVIRONMENTAL RESOURCES, SUB-PART A, PROTECTION OF NATURAL RESOURCES, ARTICLE III, WATER RESOURCES, CHAPTER 102, EROSION CONTROL.
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- THE CONTRACTOR WILL BE RESPONSIBLE FOR THE REMOVAL OF ANY EXCESS MATERIAL AND MAKE SURE THE SITE MEETS THE EXIGENCIES OF AN APPROVED EROSION AND SEDIMENT CONTROL PLAN THAT MEETS THE CONDITIONS OF CHAPTER 102, AND/OR OTHER STATE OR FEDERAL REGULATIONS. THE DISPOSAL SITE SHALL BE LOCATED GREATER THAN 100 FEET FROM ANY WETLAND, LOCATED OUTSIDE THE FLOODPLAIN. IT IS THE CONTRACTOR'S RESPONSIBILITY TO CONTACT THE APPROPRIATE CONSERVATION DISTRICT TO ENSURE THAT THE DISPOSAL SITE IS AN APPROVED FACILITY.
- ALL BUILDING MATERIALS AND WASTES MUST BE REMOVED FROM THE SITE AND RECYCLED OR DISPOSED IN ACCORDANCE WITH THE DEPARTMENT'S SOLID WASTE MANAGEMENT REGULATIONS § AT 25 PA. CODE 260.1 ET. SEQ., § 287.1 ET. SEQ. § 271.1 ET. SEQ. NO BUILDING MATERIAL AND OR WASTES OR UNUSED BUILDING MATERIALS SHALL BE BURIED, DUMPED, OR DISCHARGED AT THE SITE.
- THE CONTRACTOR SHALL TAKE ALL REASONABLE STEPS TO MINIMIZE OR PREVENT ANY DISCHARGE IN VIOLATION OF THIS PERMIT WHICH HAS A REASONABLE LIKELIHOOD OF ADVERSELY AFFECTING HUMAN HEALTH OR ENVIRONMENT.

SOIL LIMITATIONS




SOIL NAME	CUTBACKS CAVE	CORROSIVE TO CONCRETE \ STEEL*	DROUGHTY	EASILY ERODIBLE	FLOODING	DEPTH TO SATURATED ZONE \ SEASONAL HIGH WATER TABLE	HYDRIC/HYDRIC INCLUSIONS	LOW STRENGTH \ LANDSLIDE PRONE	SLOW PERCOLATION	PIPING	POOR SOURCE OF TOPSOIL	FROST ACTION	SHRINK-SWELL	POTENTIAL SINKHOLE	PONDING	WETNESS
WASHINGTON	X	S				X	X	X	X	X	X	X	X			

SOIL LIMITATION RESOLUTIONS

LIMITATION	RESOLUTION
CUTBANKS CAVE	CONDUCT TRENCHING OPERATIONS IN ACCORDANCE WITH OSHA TECHNICAL MANUAL FOR TRENCHING. STABILIZE BANKS IMMEDIATELY WITH SEED, MULCH, EROSION CONTROL MATS, BONDED FIBER MATRIX, OR A COMBINATION OF THESE AND/OR OTHER METHODS.
CORROSIVE TO CONCRETE OR STEEL	PROTECT CONCRETE AND STEEL WITH PROTECTIVE COATINGS, SELECT ALTERNATIVE MATERIALS IN LIEU OF CONCRETE OR STEEL, OR A COMBINATION OF THESE AND OR OTHER METHODS.
DROUGHTY	SELECT VEGETATIVE SPECIES TOLERANT TO DRY CONDITIONS, IRRIGATE VEGETATED AREAS, OR IMPLEMENT COMBINATIONS OF THESE AND/OR OTHER METHODS.
EASILY ERODIBLE	PROVIDE TEMPORARY OR PERMANENT CHANNEL LINING, DECREASE CHANNEL GRADE, INCREASE CHANNEL WIDTH, SELECT VEGETATION WITH A GREATER RETARDANCE, SELECT PERMANENT LININGS OTHER THAN GRASSES, OR IMPLEMENT COMBINATIONS OF THESE AND/OR OTHER METHODS.
DEPTH TO SATURATED ZONE \ SEASONAL HIGH WATER TABLE	SELECT VEGETATIVE SPECIES TOLERANT TO WET CONDITIONS, TILE VEGETATED AREAS, OR IMPLEMENT COMBINATIONS OF THESE AND/OR OTHER METHODS.
LOW STRENGTH \ LANDSLIDE PRONE	LOCATE ROADWAYS TO OTHER SOIL TYPES, IMPORT OTHER SOILS FOR THESE ROADWAY CONSTRUCTION, OR IMPLEMENT A COMBINATION OF THESE AND/OR OTHER METHODS. FOR CUT/FILL SLOPES, REDUCE SLOPE, INSTALL

CONSTRUCTION AND EROSION CONTROL PLANS FOR SCULAC ROAD STREAM RESTORATION


4225 EASTON AVENUE
BETHLEHEM, PA 18020
BETHLEHEM TOWNSHIP, NORTHAMPTON COUNTY, PENNSYLVANIA

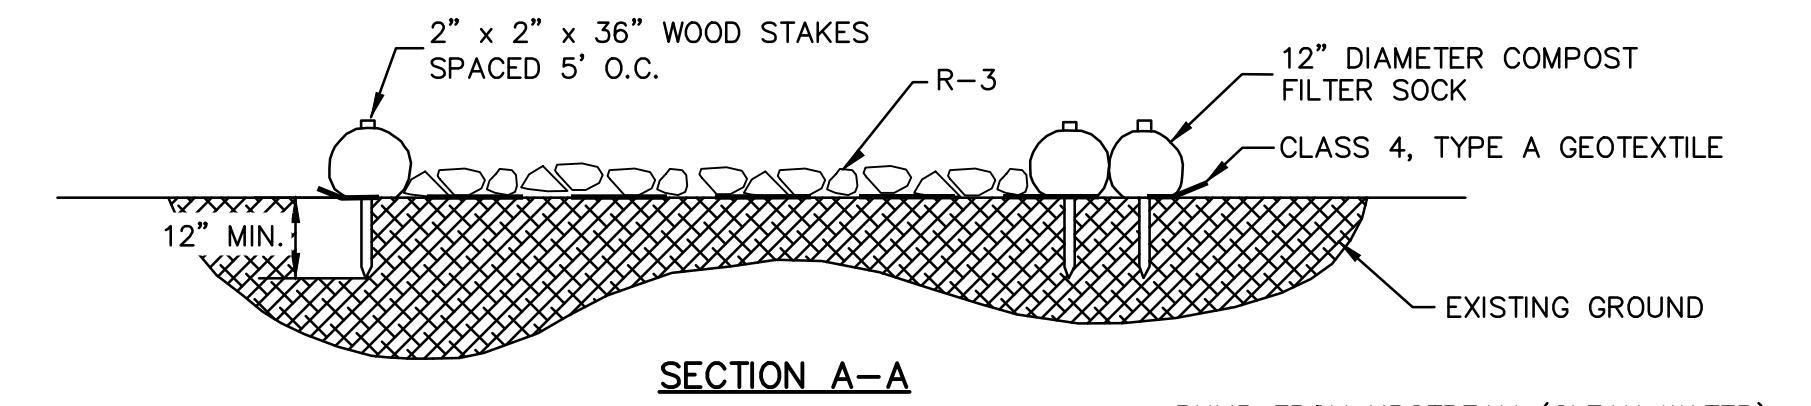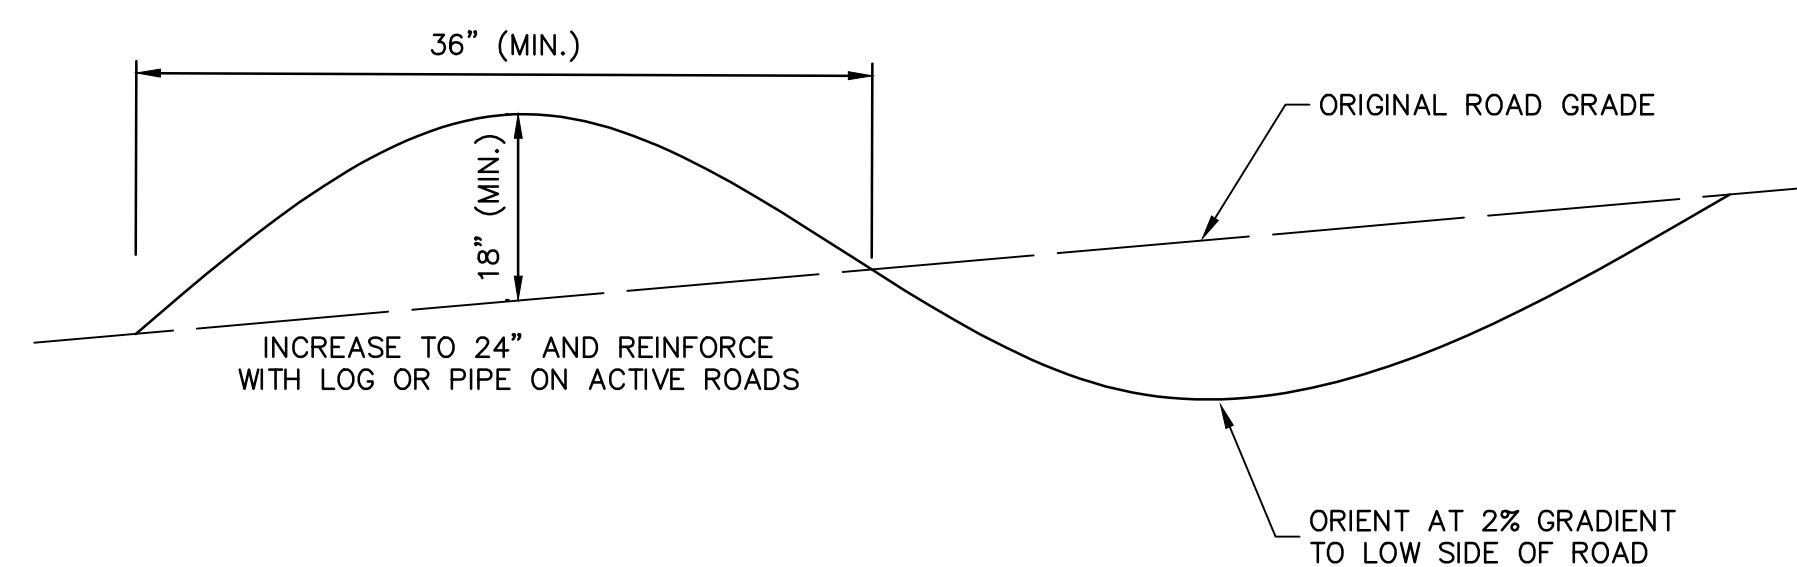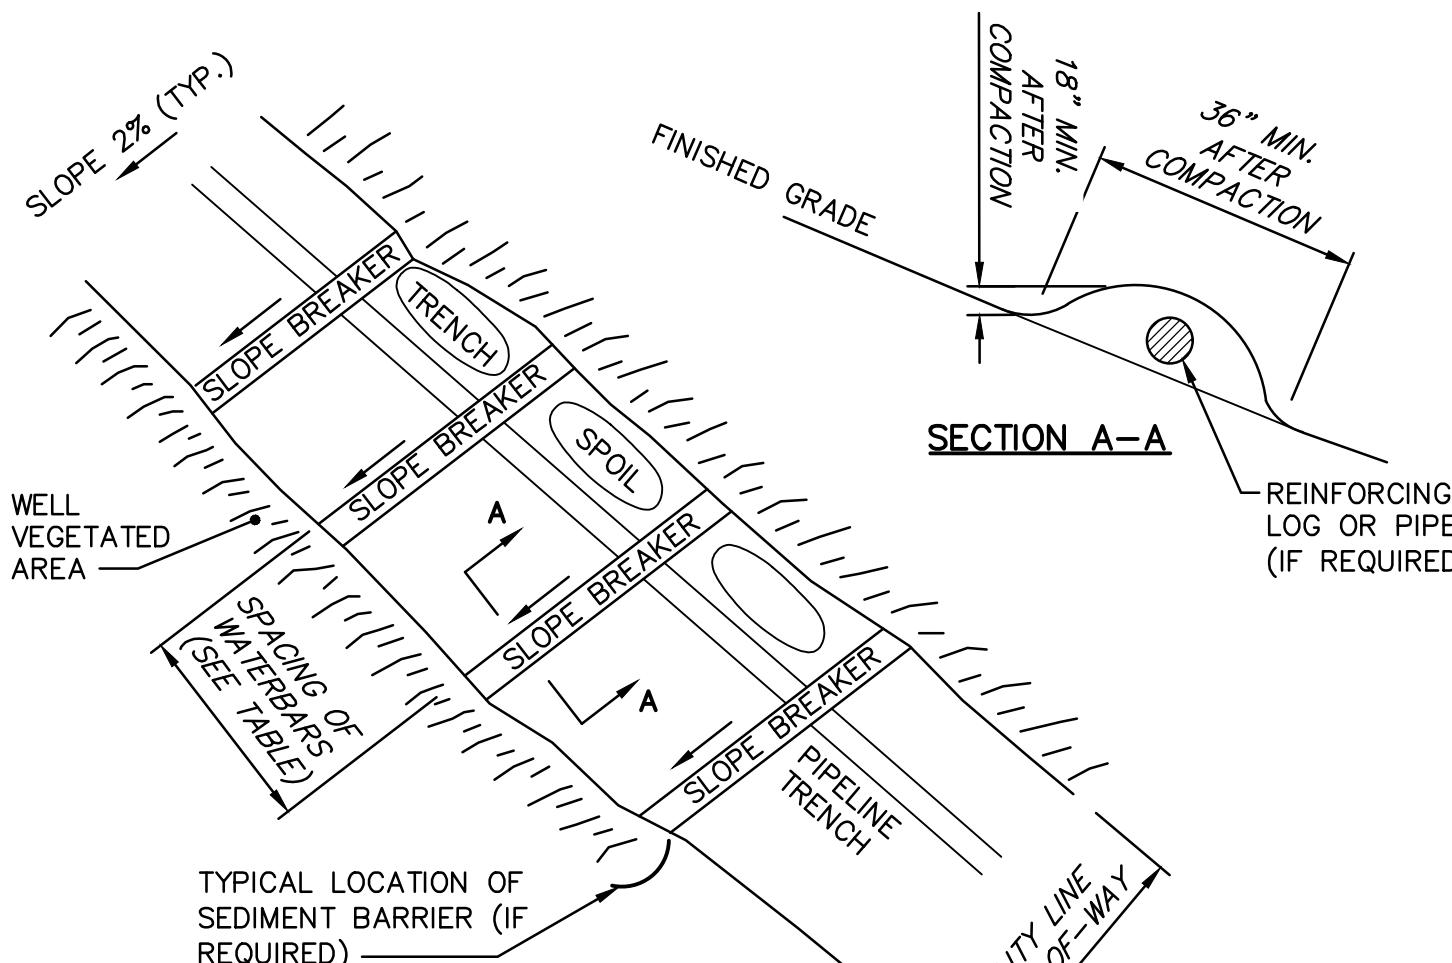

NOTES:

1. WATERBARS MUST DISCHARGE TO A STABLE AREA.
2. WATERBARS SHALL BE INSPECTED WEEKLY (DAILY ON ACTIVE ROADS) AND AFTER EACH RUNOFF EVENT. DAMAGED OR ERODED WATERBARS SHALL BE RESTORED TO ORIGINAL DIMENSIONS WITHIN 24 HOURS OF INSPECTION.
3. MAINTENANCE OF WATERBARS SHALL BE PROVIDED UNTIL ROADWAY, SKIDTRAIL, OR RIGHT-OF-WAY HAS ACHIEVED PERMANENT STABILIZATION.
4. WATERBARS ON RETIRED ROADWAYS, SKIDTRAILS, AND RIGHTS-OF-WAY SHALL BE LEFT IN PLACE AFTER PERMANENT STABILIZATION HAS BEEN ACHIEVED.


02 WATERBAR DETAIL
NOT TO SCALE

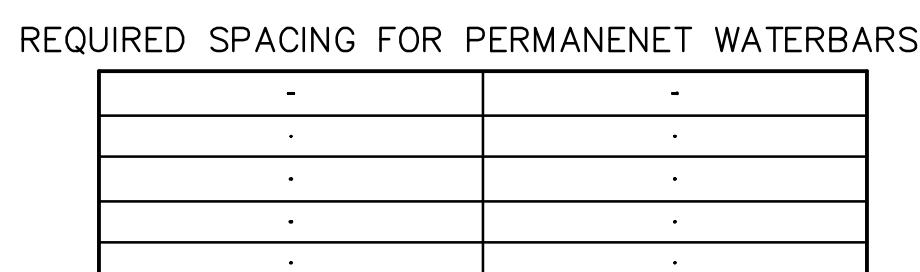

NOTES:

1. WATERBARS (SLOPE BREAKERS, INTERCEPTOR DIKES) SHOULD BE INSTALLED ACROSS THE ENTIRE RIGHT-OF-WAY ON ALL SLOPES GREATER THAN 5%.
2. WATERBARS SHOULD BE CONSTRUCTED AT A SLOPE OF 2% AND DISCHARGED TO A WELL VEGETATED AREA. WATERBARS SHOULD NOT DISCHARGE INTO AN OPEN TRENCH. WATERBARS SHOULD BE ORIENTED SO THAT THE DISCHARGE DOES NOT FLOW BACK ONTO THE RIGHT-OF-WAY. OBSTRUCTIONS (E.G. STRAW BALES, SILT FENCE, ROCK FILTERS, ETC.) SHOULD NOT BE PLACED IN ANY WATERBARS. WHERE NEEDED, THEY SHOULD BE LOCATED BELOW THE DISCHARGE END OF THE WATERBAR.
3. WHERE WATERBARS ARE USED ON ACTIVE ACCESS ROADS, IT IS NECESSARY TO PROVIDE REINFORCEMENT OF THE BERM WITH A LOG, STEEL PIPE, ETC. TO MAINTAIN INTEGRITY OF THE WATERBAR BETWEEN MAINTENANCE OPERATIONS. ALL SUCH WATERBARS SHOULD BE RESTORED TO ORIGINAL DIMENSIONS AT THE END OF EACH WORK DAY.
4. ALL WATERBARS SHOULD BE VEGETATED.


01 WATERBAR INSTALLATION DETAIL
NOT TO SCALE

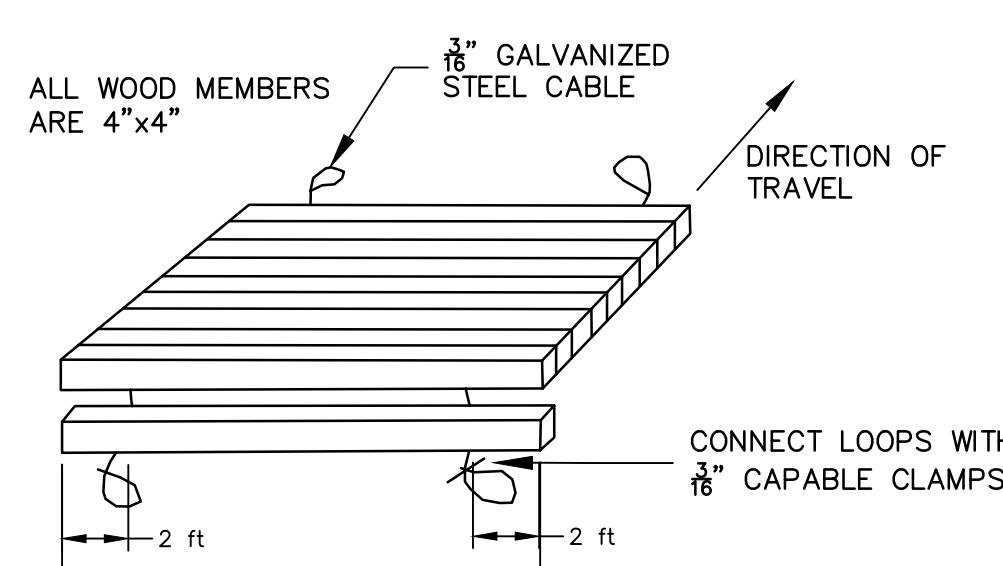

NOTES:

1. GEOTEXTILE UNDERLAYMENT SHALL BE USED UNDER TIMBER MATTING FOR EACH WETLAND CROSSING.
2. WETLAND SHALL BE CROSSED AT SHORTEST WIDTH PRACTICABLE.


04 TYPICAL TIMBER MAT DETAIL
NOT TO SCALE

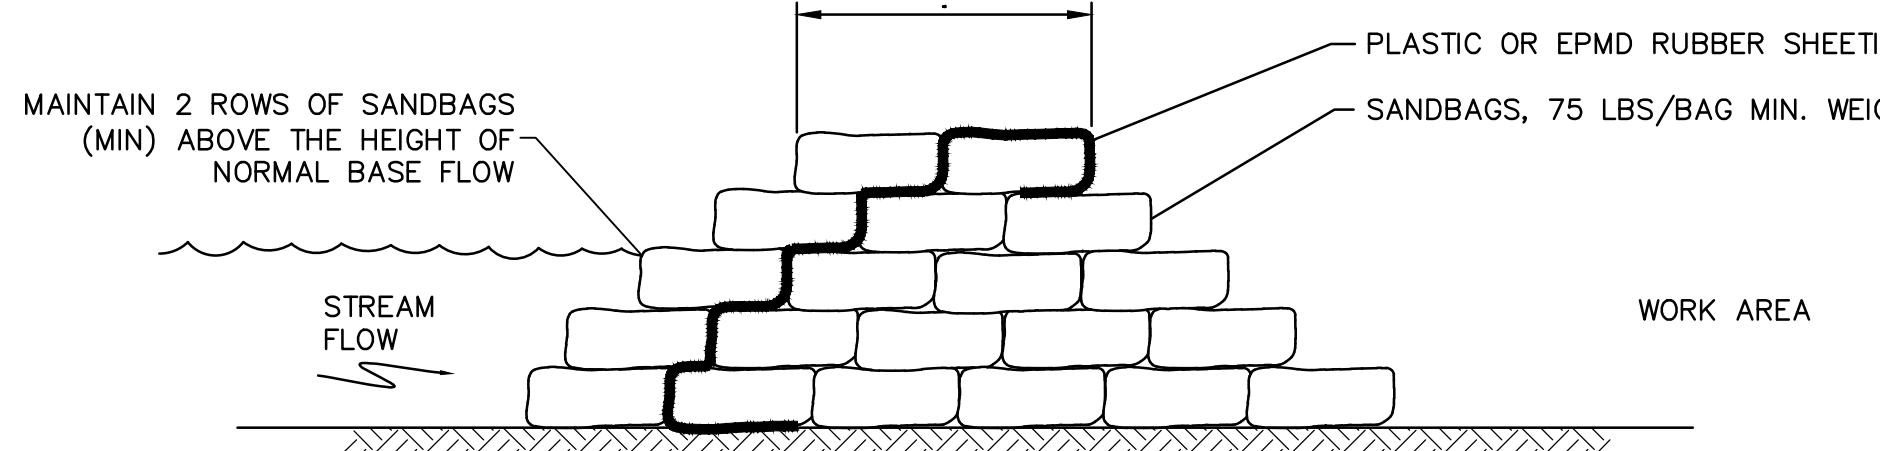

NOTES:

1. TOE THE SANDBAGS INTO THE EMBANKMENT. SECURE THE PLASTIC SHEETING OR EPMD LINER TO THE TOP, BOTTOM AND SIDES OF THE COFFERDAM WITH SANDBAGS TO FORM A WATERTIGHT SEAL.


05 SANBAG COFFER DAM FOR PUMP BY-PASS DETAIL
NOT TO SCALE

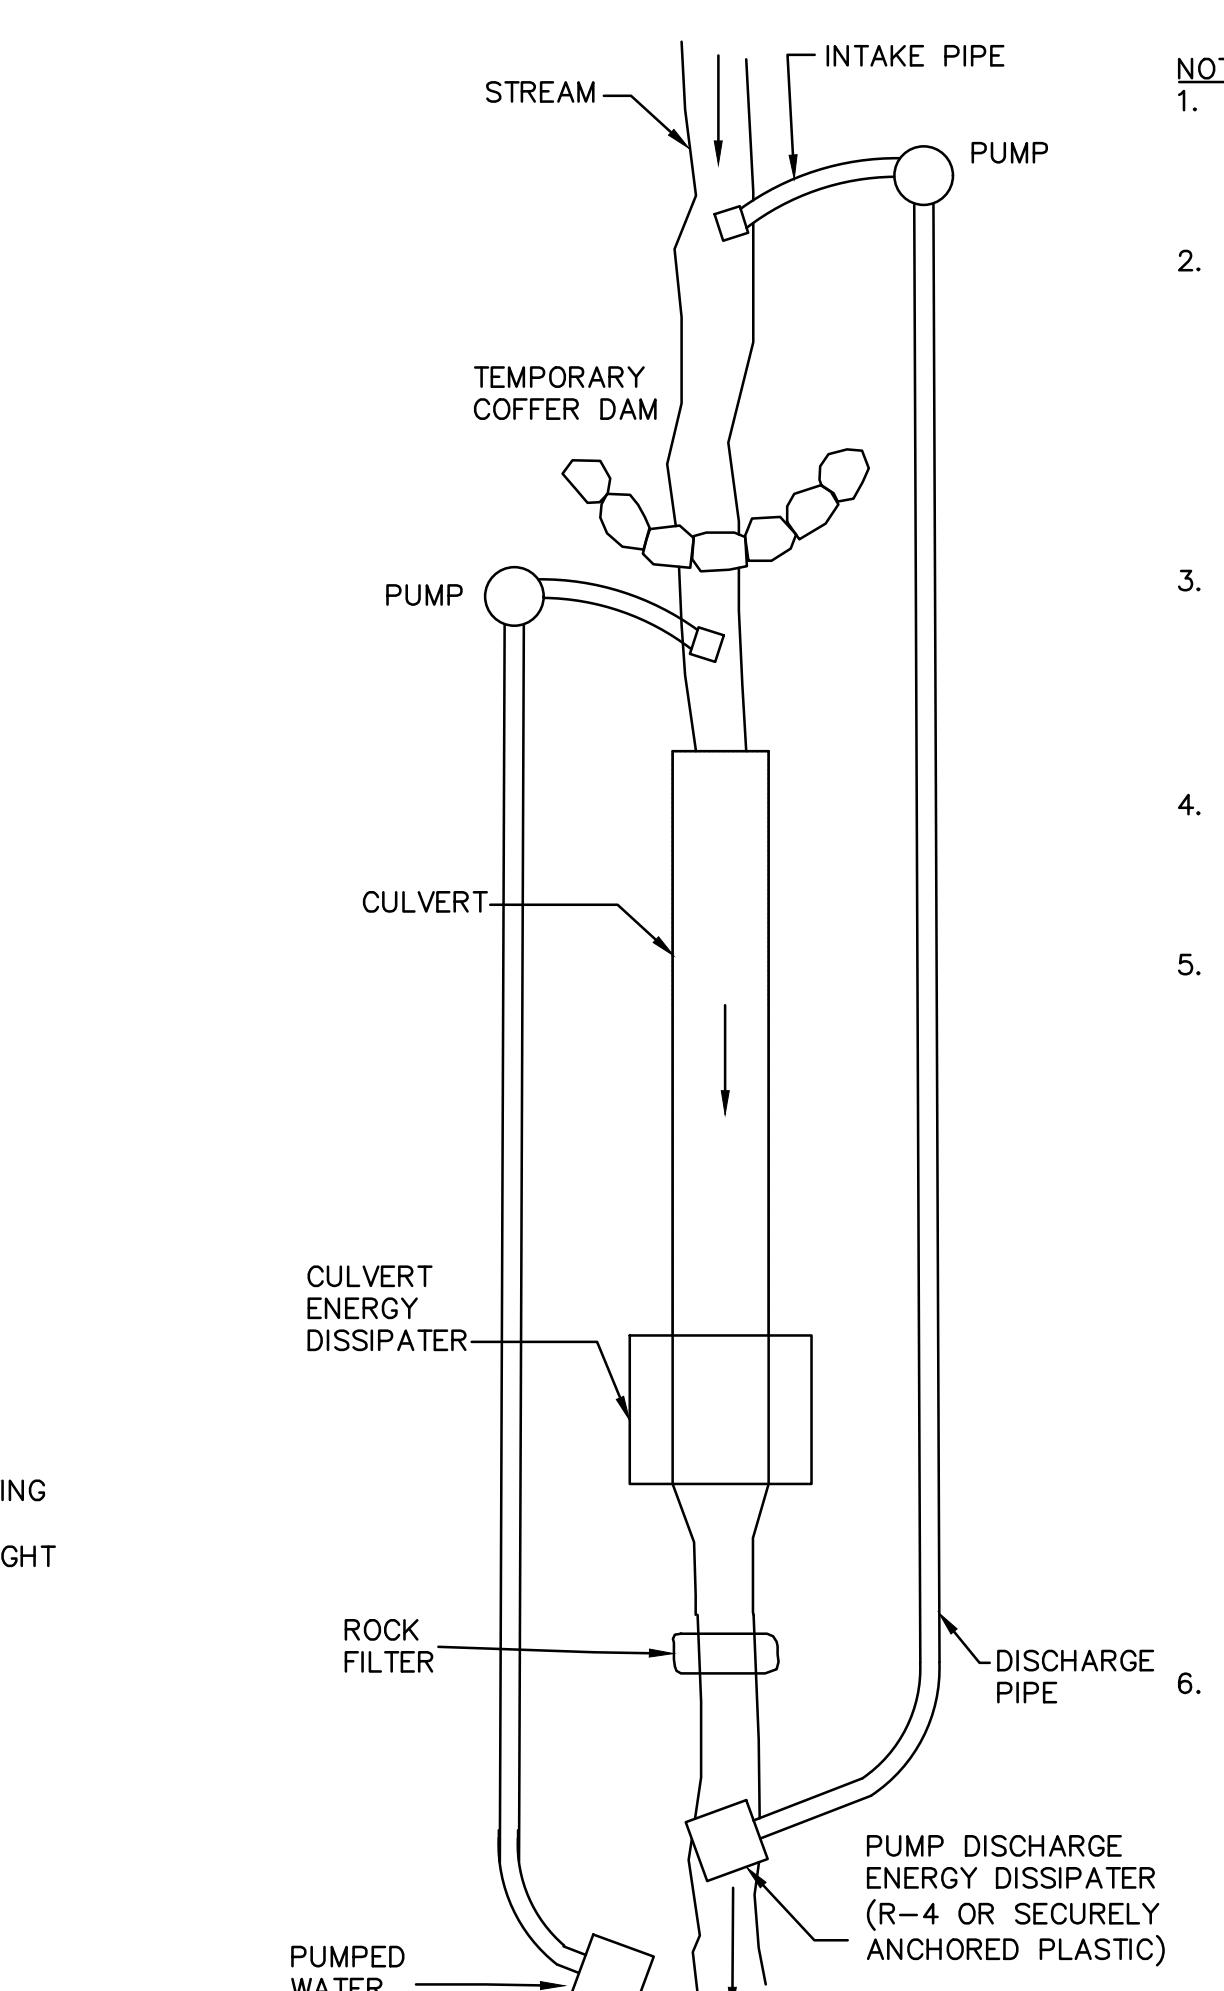

06 IN-CHANNEL WORK/PUMPED BYPASS DETAIL
NOT TO SCALE

NOTES:



1. NORMAL FLOW SHOULD BE CONVEYED PAST THE WORK AREA BY MEANS OF A BYPASS PUMP. ALL SUCH BYPASSES SHOULD BE COMPLETED AND STABILIZED PRIOR TO DIVERTING FLOW.
2. ANY IN-CHANNEL EXCAVATIONS SHOULD BE DONE FROM THE TOP OF BANKS WHEREVER POSSIBLE. WHERE THIS IS NOT POSSIBLE, A TEMPORARY CROSSING SHOULD BE PROVIDED. FOR ANY EQUIPMENT WORKING WITHIN THE CHANNEL UPON COMPLETION, ALL CHANNEL ENTRANCES SHOULD BE RESTORED TO PRE-CONSTRUCTION CONFIGURATIONS, AS MUCH AS POSSIBLE, AND STABILIZED.
3. ALL EXCAVATED CHANNEL MATERIALS THAT WILL BE SUBSEQUENTLY USED AS BACKFILL SHOULD BE PLACED IN A TEMPORARY STOCKPILE LOCATED OUTSIDE THE CHANNEL. A SEDIMENT BARRIER SHOULD BE INSTALLED BETWEEN THE STORAGE PILE AND THE STREAM CHANNEL.
4. ALL EXCAVATED MATERIALS THAT WILL NOT BE USED ON SITE MUST BE IMMEDIATELY REMOVED TO A DISPOSAL SITE HAVING AN APPROVED EROSION AND SEDIMENT POLLUTION CONTROL PLAN.
5. ANY PUMPED WATER FROM EXCAVATED AREAS MUST BE FILTERED PRIOR TO DISCHARGING INTO WATERS OF THE COMMONWEALTH. THE USE OF FILTER BAGS IS ANOTHER ACCEPTABLE METHOD. IF LOCATED ON A RELATIVELY FLAT (<5% SLOPE), WELL VEGETATED AREA, THE BAG SHOULD BE DESIGNED TO TRAP PARTICLES LARGER THAN 150 MICRONS. THE PUMP DISCHARGE HOSE SHALL BE INSERTED INTO THE BAGS IN THE MANNER SPECIFIED BY THE MANUFACTURER AND SECURELY CLAMPED. WHEN THE BAG HAS BEEN FILLED TO 1/2 ITS TOTAL CAPACITY, IT SHOULD BE REPLACED WITH A NEW BAG AND PROPERLY DISPOSED. WHEREVER WELL VEGETATED AREAS ARE NOT AVAILABLE, A GEOTEXTILE UNDERLAYMENT SHOULD BE USED. CONSIDERATION SHOULD BE GIVEN TO HOW THE BAG WILL BE ACCESSED AND REMOVED ONCE IT HAS BEEN 1/2 FILLED WITH SEDIMENT.
6. ALL DISTURBED AREAS WITHIN THE EXISTING CHANNEL SHOULD BE COMPLETED AND STABILIZED BEFORE FLOW IS REDIRECTED INTO IT. SUITABLE PROTECTION SHOULD BE PROVIDED FOR THE STREAM CHANNEL FROM ANY DISTURBED AREAS THAT HAVE NOT YET ACHIEVED STABILIZATION.

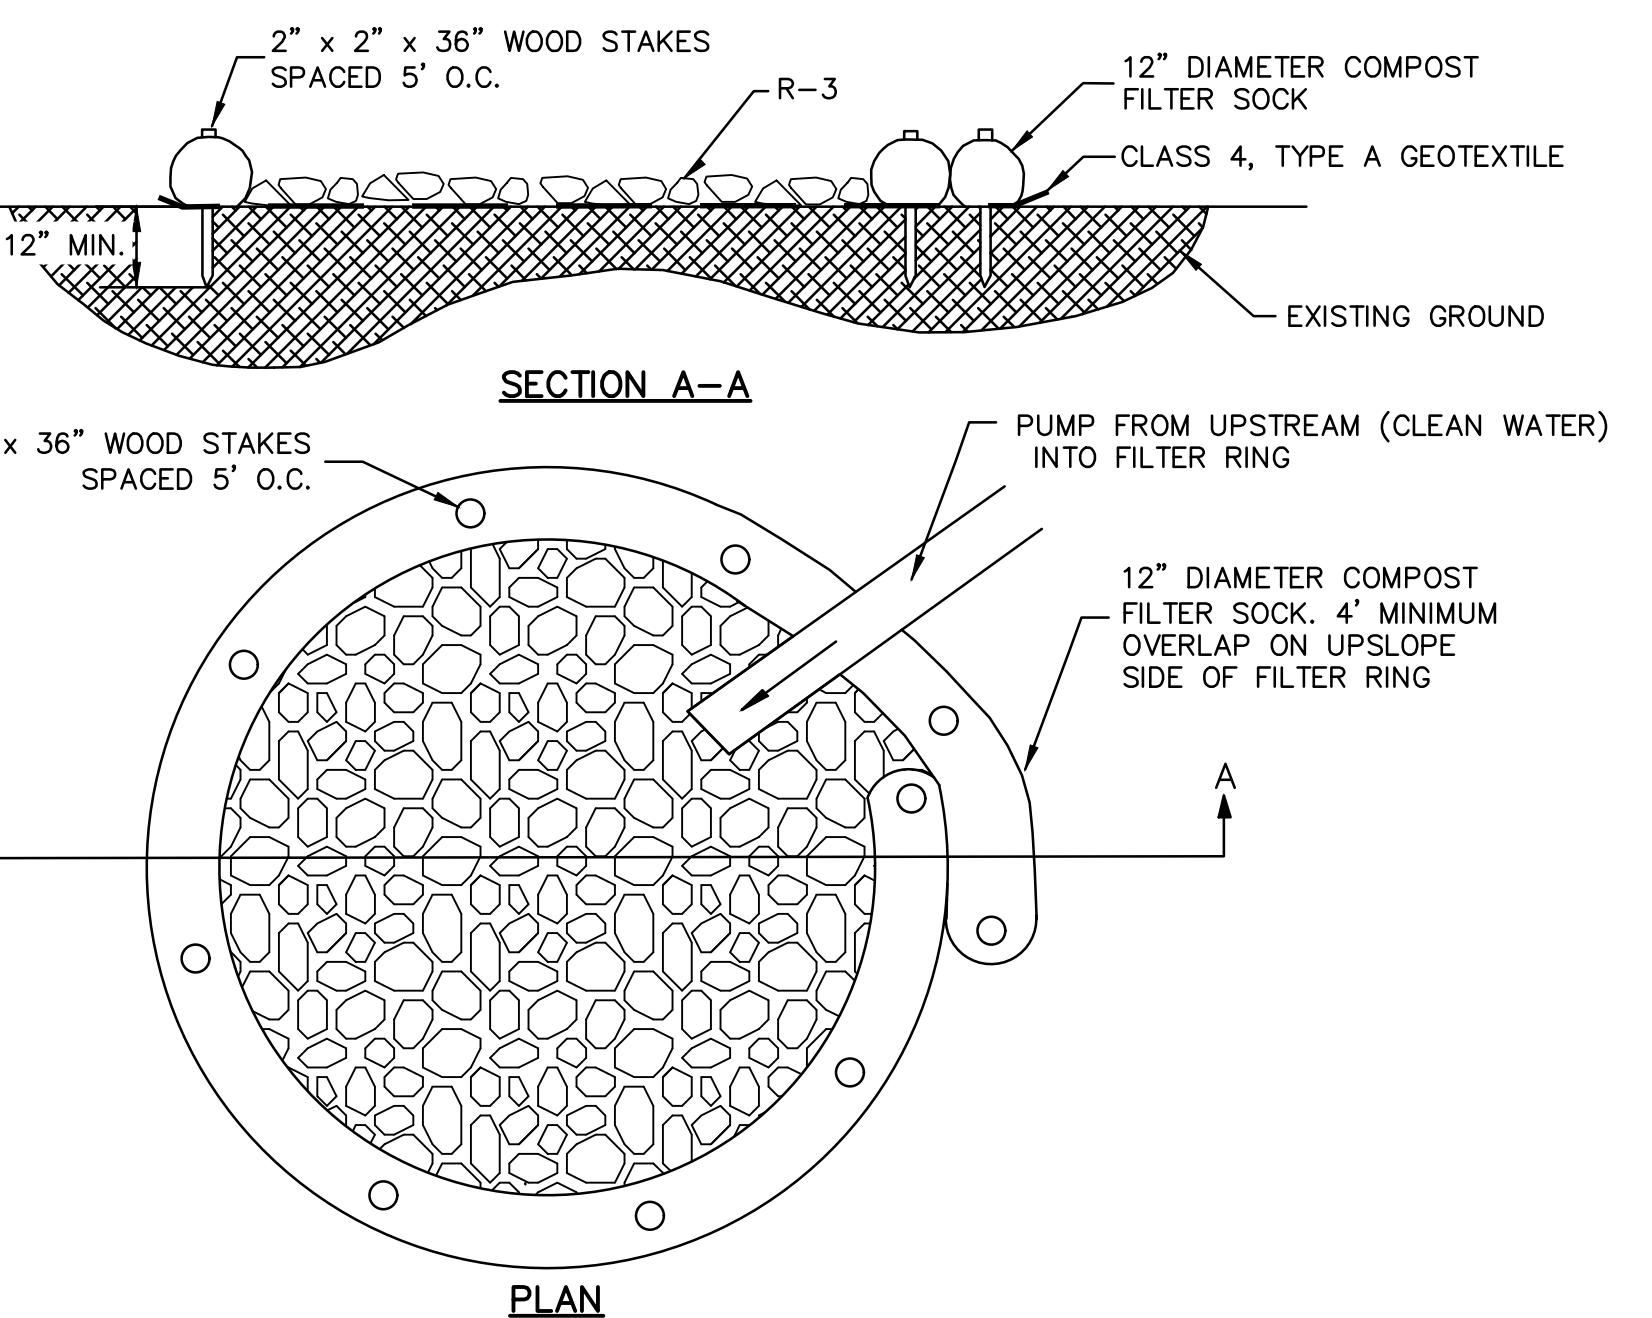

NOTES:

1. INSTALL ON FLAT GRADE (0 < 2% SLOPE).
2. 18" DIAMETER FILTER SOCK MAY BE STACKED ONTO DOUBLE 24" DIAMETER SOCKS IN PYRAMIDAL CONFIGURATION FOR ADDED HEIGHT.

03 PUMP DISCHARGE ENERGY DISSIPATOR DETAIL
NOT TO SCALE

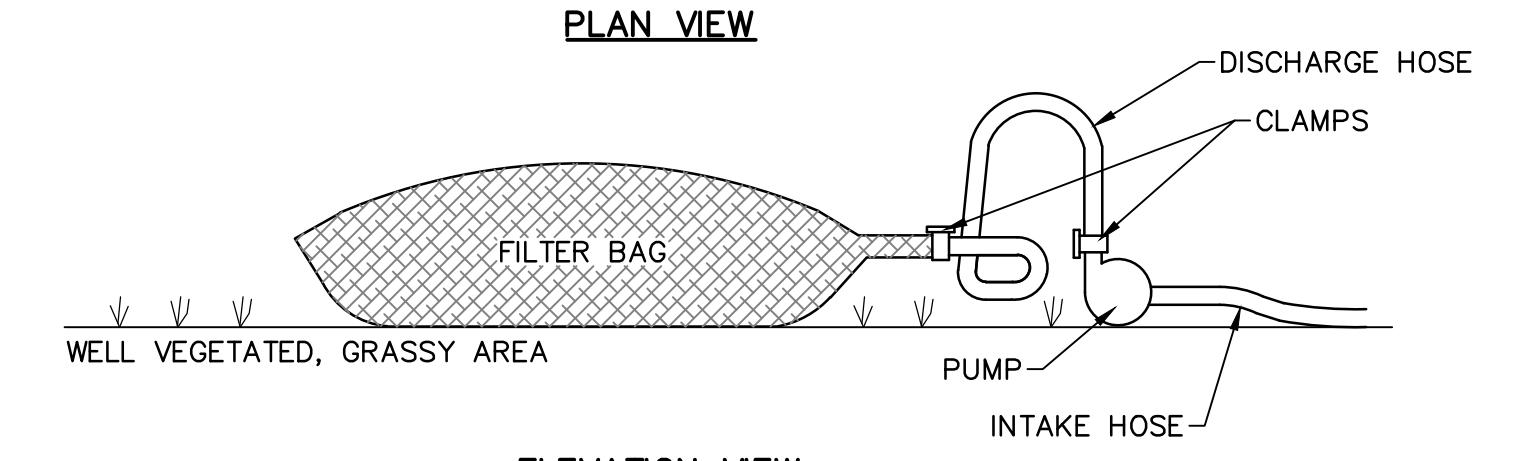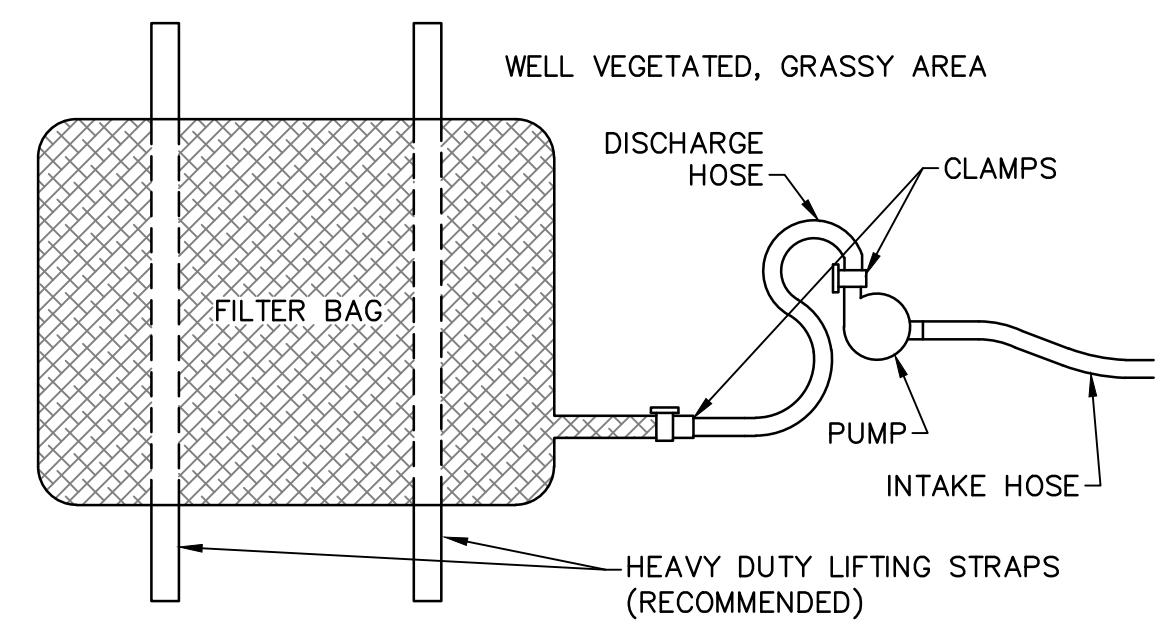


NOTES:

1. LOW VOLUME FILTER BAGS SHALL BE MADE FROM NON-WOVEN GEOTEXTILE MATERIAL SEWN WITH HIGH STRENGTH, DOUBLE STITCHED "J" TYPE SEAMS. THEY SHALL BE CAPABLE OF TRAPPING PARTICLES LARGER THAN 150 MICRONS. HIGH VOLUME FILTER BAGS SHALL BE MADE FROM WOVEN GEOTEXTILES THAT MEET THE FOLLOWING STANDARDS:

PROPERTY	TEST METHOD	MINIMUM STANDARD
AVG. WIDE WIDTH STRENGTH	ASTM D-4884	60 LB/IN
GRAB TENSILE	ASTM D-4632	205 LB
PUNCTURE	ASTM D-4833	110 LB
MULLEN BURST	ASTM D-3786	350 PSI
UV RESISTANCE	ASTM D-4355	70%
AOS % RETAINED	ASTM D-4751	80 SIEVE

2. A SUITABLE MEANS OF ACCESSING THE BAG WITH MACHINERY REQUIRED FOR DISPOSAL PURPOSES SHALL BE PROVIDED. FILTER BAGS SHALL BE REPLACED WHEN THEY BECOME 1/2 FULL OF SEDIMENT. SPARE BAGS SHALL BE KEPT AVAILABLE FOR REPLACEMENT OF THOSE THAT HAVE FAILED OR ARE FILLED. BAGS SHALL BE PLACED ON STRAPS TO FACILITATE REMOVAL UNLESS BAGS COME WITH LIFTING STRAPS ALREADY ATTACHED.
3. BAGS SHALL BE LOCATED IN WELL-VEGETATED (GRASSY) AREA, AND DISCHARGE ONTO STABLE, EROSION RESISTANT AREAS. WHERE THIS IS NOT POSSIBLE, A GEOTEXTILE UNDERLAYMENT AND FLOW PATH SHALL BE PROVIDED. BAGS MAY BE PLACED ON FILTER STONE TO INCREASE DISCHARGE CAPACITY. BAGS SHALL NOT BE PLACED ON SLOPES GREATER THAN 5% FOR SLOPES EXCEEDING 5%, CLEAN ROCK OR OTHER NON-ERODIBLE AND NON-POLLUTING MATERIAL MAY BE PLACED UNDER THE BAG TO REDUCE SLOPE STEEPNESS.
4. NO DOWNSLOPE SEDIMENT BARRIER IS REQUIRED FOR MOST INSTALLATIONS. COMPOST BERM OR COMPOST FILTER SOCK SHALL BE INSTALLED BELOW BAGS LOCATED IN HQ OR EV WATERSHEDS, WITHIN 50 FEET OF ANY RECEIVING SURFACE WATER OR WHERE GRASSY AREA IS NOT AVAILABLE.
5. THE PUMP DISCHARGE HOSE SHALL BE INSERTED INTO THE BAGS IN THE MANNER SPECIFIED BY THE MANUFACTURER AND SECURELY CLAMPED. A PIECE OF PVC PIPE IS RECOMMENDED FOR THIS PURPOSE.
6. THE PUMPING RATE SHALL BE NO GREATER THAN 750 GPM OR 1/2 THE MAXIMUM SPECIFIED BY THE MANUFACTURER, WHICHEVER IS LESS. PUMP INTAKES SHALL BE FLOATING AND SCREENED.
7. FILTER BAGS SHALL BE INSPECTED DAILY. IF ANY PROBLEM IS DETECTED, PUMPING SHALL CEASE IMMEDIATELY AND NOT RESUME UNTIL THE PROBLEM IS CORRECTED.

07 PUMPED WATER FILTER BAG DETAIL
NOT TO SCALE

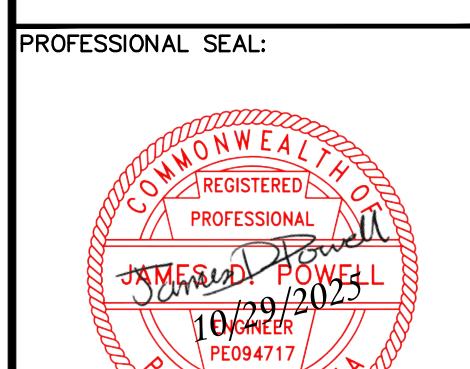


HRG PROJECT NUMBER: R009170.0431
PLAN DATE: FEBRUARY 2025
DRAWING SCALE: AS SHOWN
PROJ. MANAGER: MATTHEW VANASKE

REVISIONS	DESCRIPTION
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1	03/05/2025 REVISED PER NCC COMMENTS
2	10/01/25 REVISED FOR CONSTRUCTION REVIEW
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FILE NAME: EROSION CONTROL DETAILS
SHEET TITLE: EROSION CONTROL DETAILS
SHEET: DT-05

SECTION AND EDITION ONE: LANE
FOR
SCULAC ROAD STREAM RESTORATION

4225 EASION AVENUE
BETHLEHEM, PA 18020
NORTHAMPTON COUNTY
BETHLEHEM TOWNSHIP PENNSYLVANIA

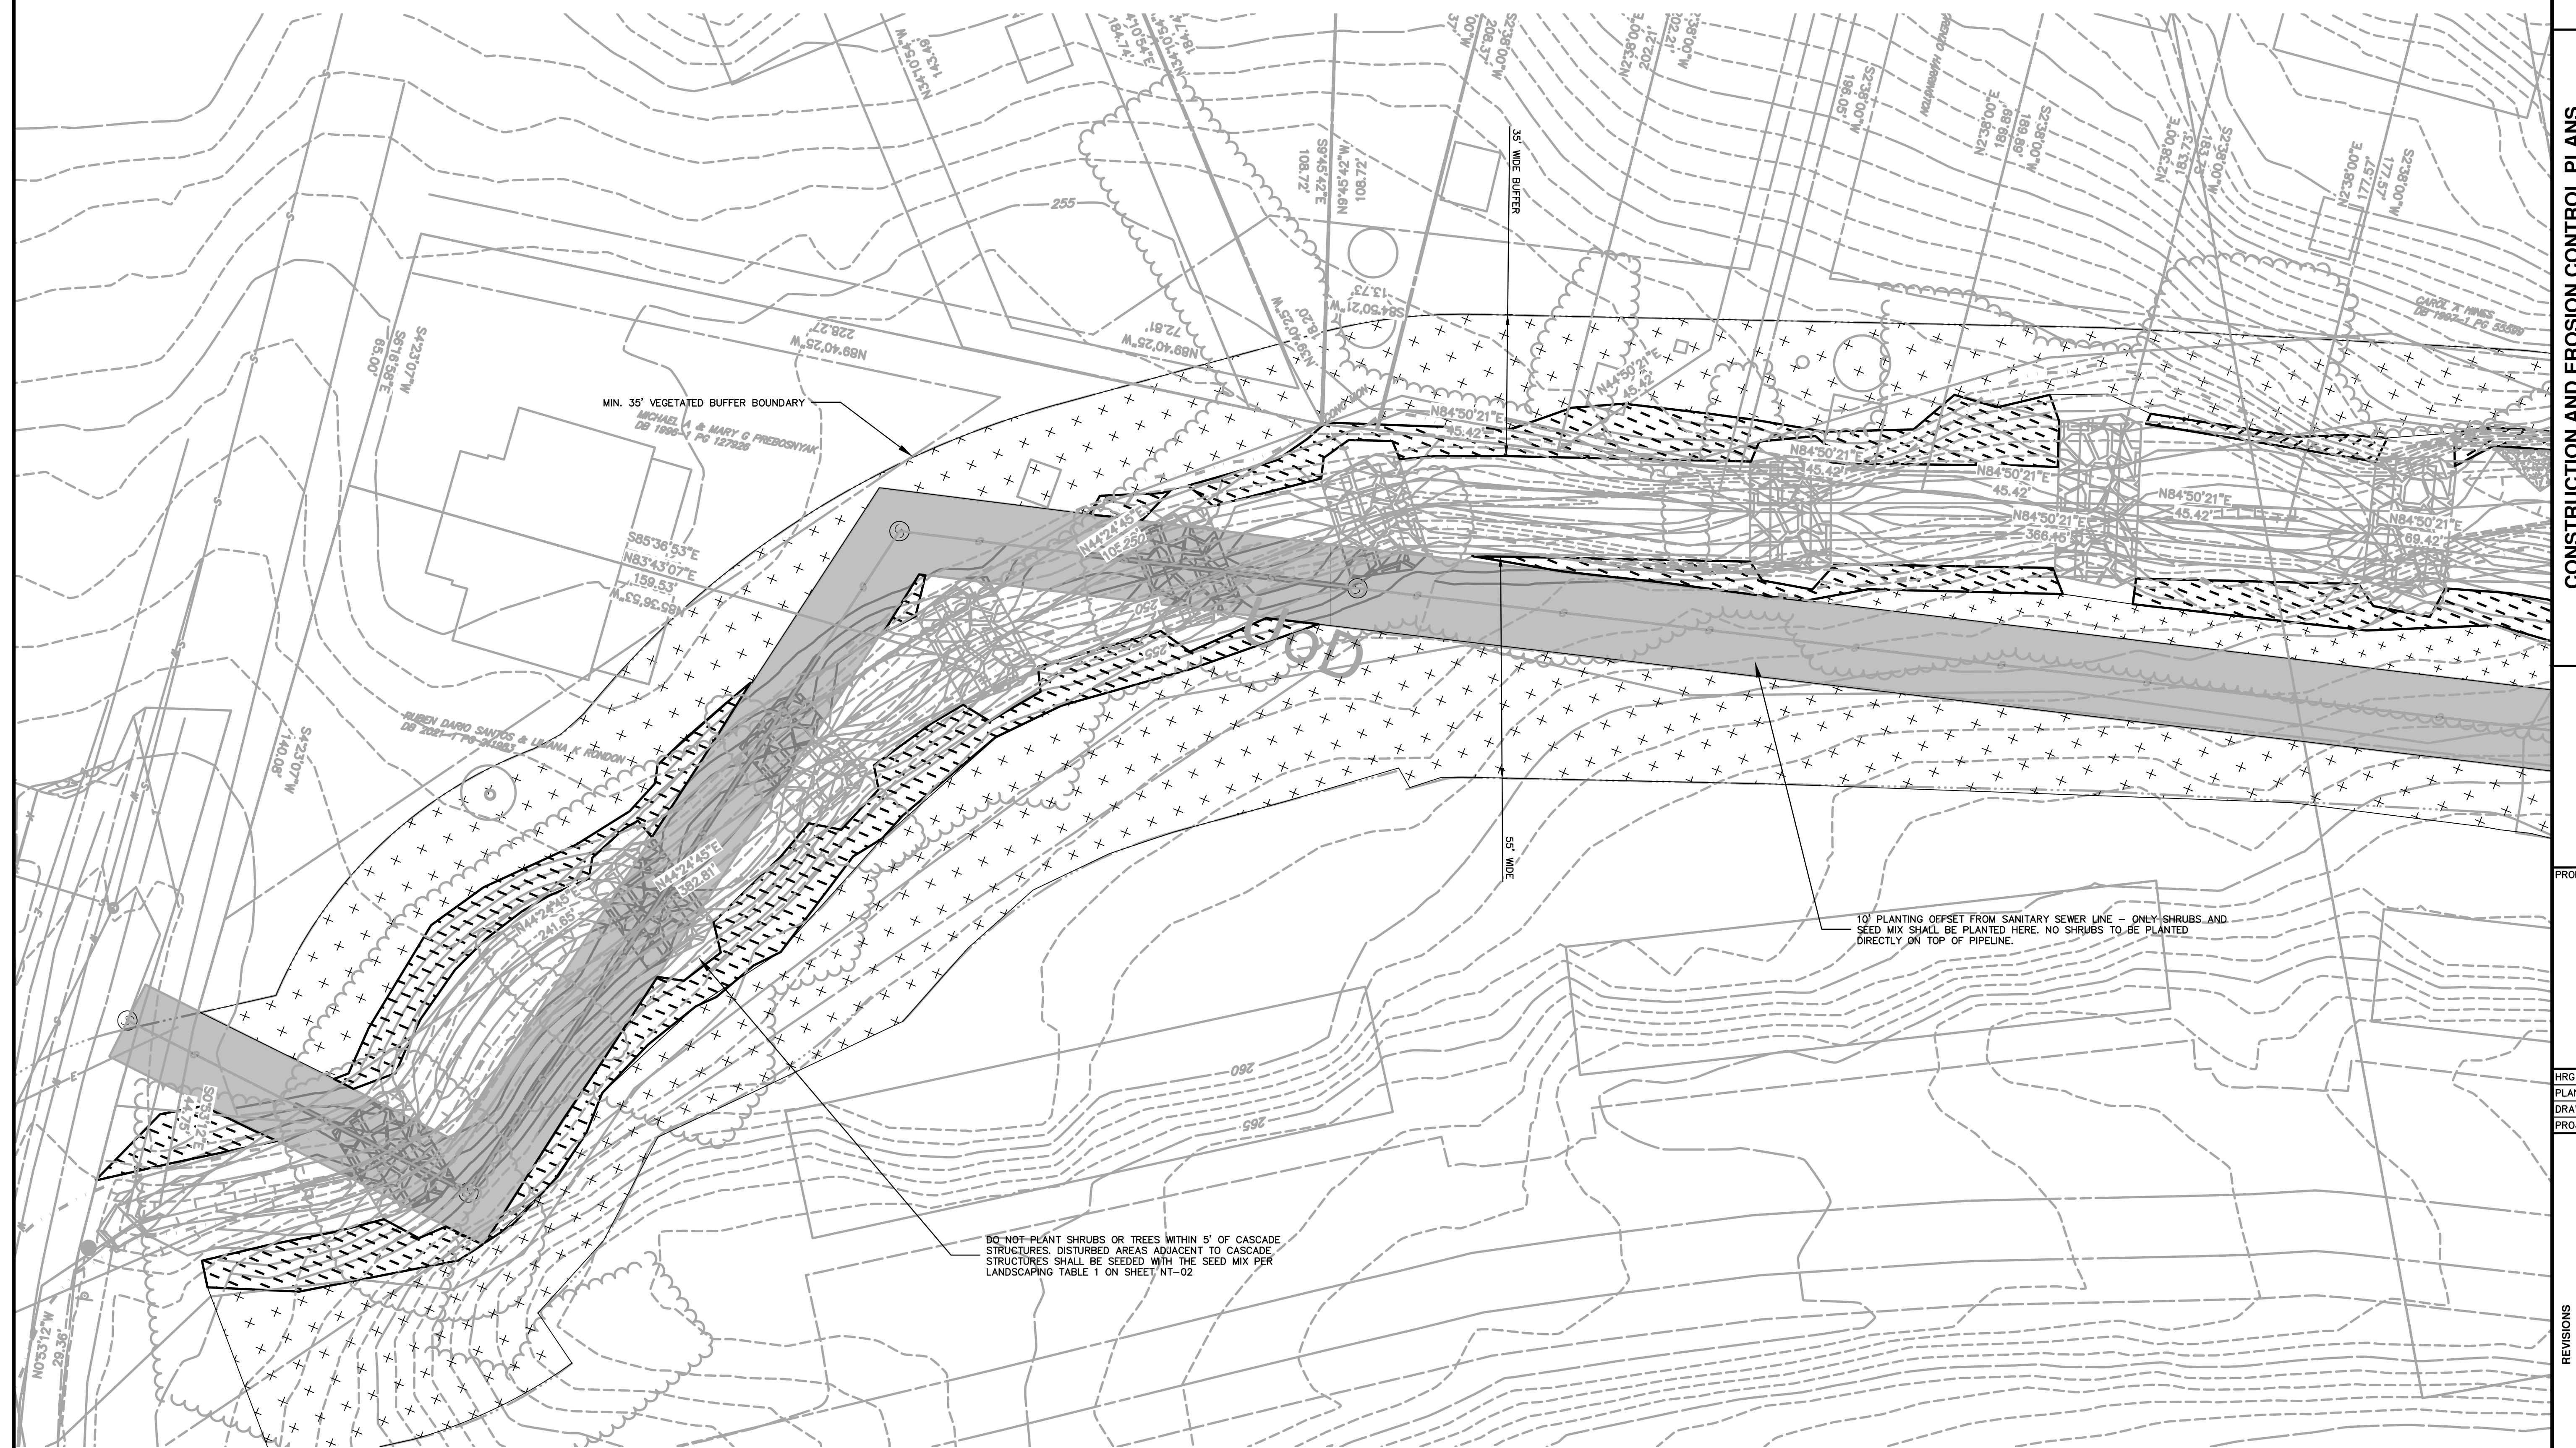

LEGEND

 20' SANITARY SEWER LINE OFFSET

 PROPOSED HIGH-DENSITY DISTURBED PLANTING AREA – SEE LANDSCAPING TABLE 1

 PROPOSED LOW-DENSITY UPLAND RIPARIAN PLANTING AREA – SEE LANDSCAPING TABLE

VEGETATED BUFFER BOUNDARY – MINIMUM 35' EACH BANK

NOTES

1. FINAL PLANTING AREA LAYOUT TO BE COORDINATED IN THE FIELD WITH HRG ENGINEER AS A CRITICAL INSPECTION STAGE.
2. SEE SHEET NT-02 FOR PLANT SCHEDULE.
3. NO PLANT SUBSTITUTIONS WITHOUT PRIOR APPROVAL OF LANDSCAPE ARCHITECT.
4. NO TREES SHALL BE PLANTED WITHIN THE 10' OFFSET OF THE EXISTING SANITARY SEWER LINE. SHRUBS CAN BE PLANTED WITHIN THE 10' OFFSET, BUT SHALL NOT BE PLANTED DIRECTLY ON TOP OF PIPELINE.
5. DO NOT PLANT SHRUBS OR TREES WITHIN 5' OF THE EDGE OF EACH CASCADE STRUCTURE. ALL DISTURBED AREAS ADJACENT TO CASCADE STRUCTURES SHALL BE SEEDED WITH THE SEED MIX AS INDICATED IN LANDSCAPING TABLE #1 ON SHEET NT-02.

A graphic scale bar consisting of a horizontal line with a break in the center. The left segment is labeled "10'" and the right segment is labeled "0'".

SHEET TITLE:
**LANDSCAPING
PLAN**

SHEET: **LS-01**

32

The seal is circular with a rope-like border. The words "COMMONWEALTH OF PENNSYLVANIA" are written in a circle at the top. In the center, "REGISTERED PROFESSIONAL" is written above "ENGINEER". Below the engineer title is the name "JAMES D. POWELL". At the bottom, "10/29/2025" is written above "PE094717".


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DATE:	FEBRUARY 2022
WING SCALE:	AS SHOWN
MANAGER:	MATTHEW VANASKI

NO.	DATE	DESCRIPTION
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2	10/01/25	REVISED PER CONSTRUCTABILITY REVIEW
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SET TITLE: **LANDSCAPING PLAN**

ET:
LS-01

32

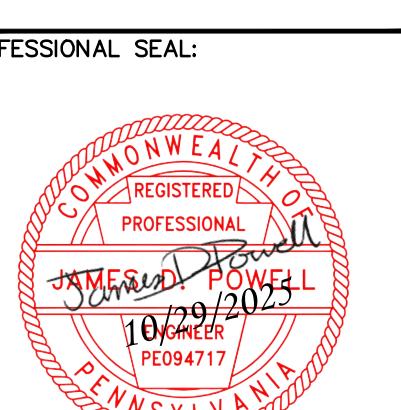


HRG PROJECT NUMBER: R009170.0431
PLAN DATE: FEBRUARY 2025
DRAWING SCALE: AS SHOWN
PROJ. MANAGER: MATTHEW VANASKE

REVISIONS	DESCRIPTION
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LANDSCAPING
PLAN

FILE NAME: F:\D\DRAWINGS\HRG\SCULAC\SCULAC.dwg SHEET: LS-02 LAST SAVED: 03/29/2025 11:15 AM BY PC01

FILE NAME: F:\D\DRAWINGS\HRG\SCULAC\SCULAC.dwg SHEET: LS-02 LAST SAVED: 03/29/2025 11:15 AM BY PC01

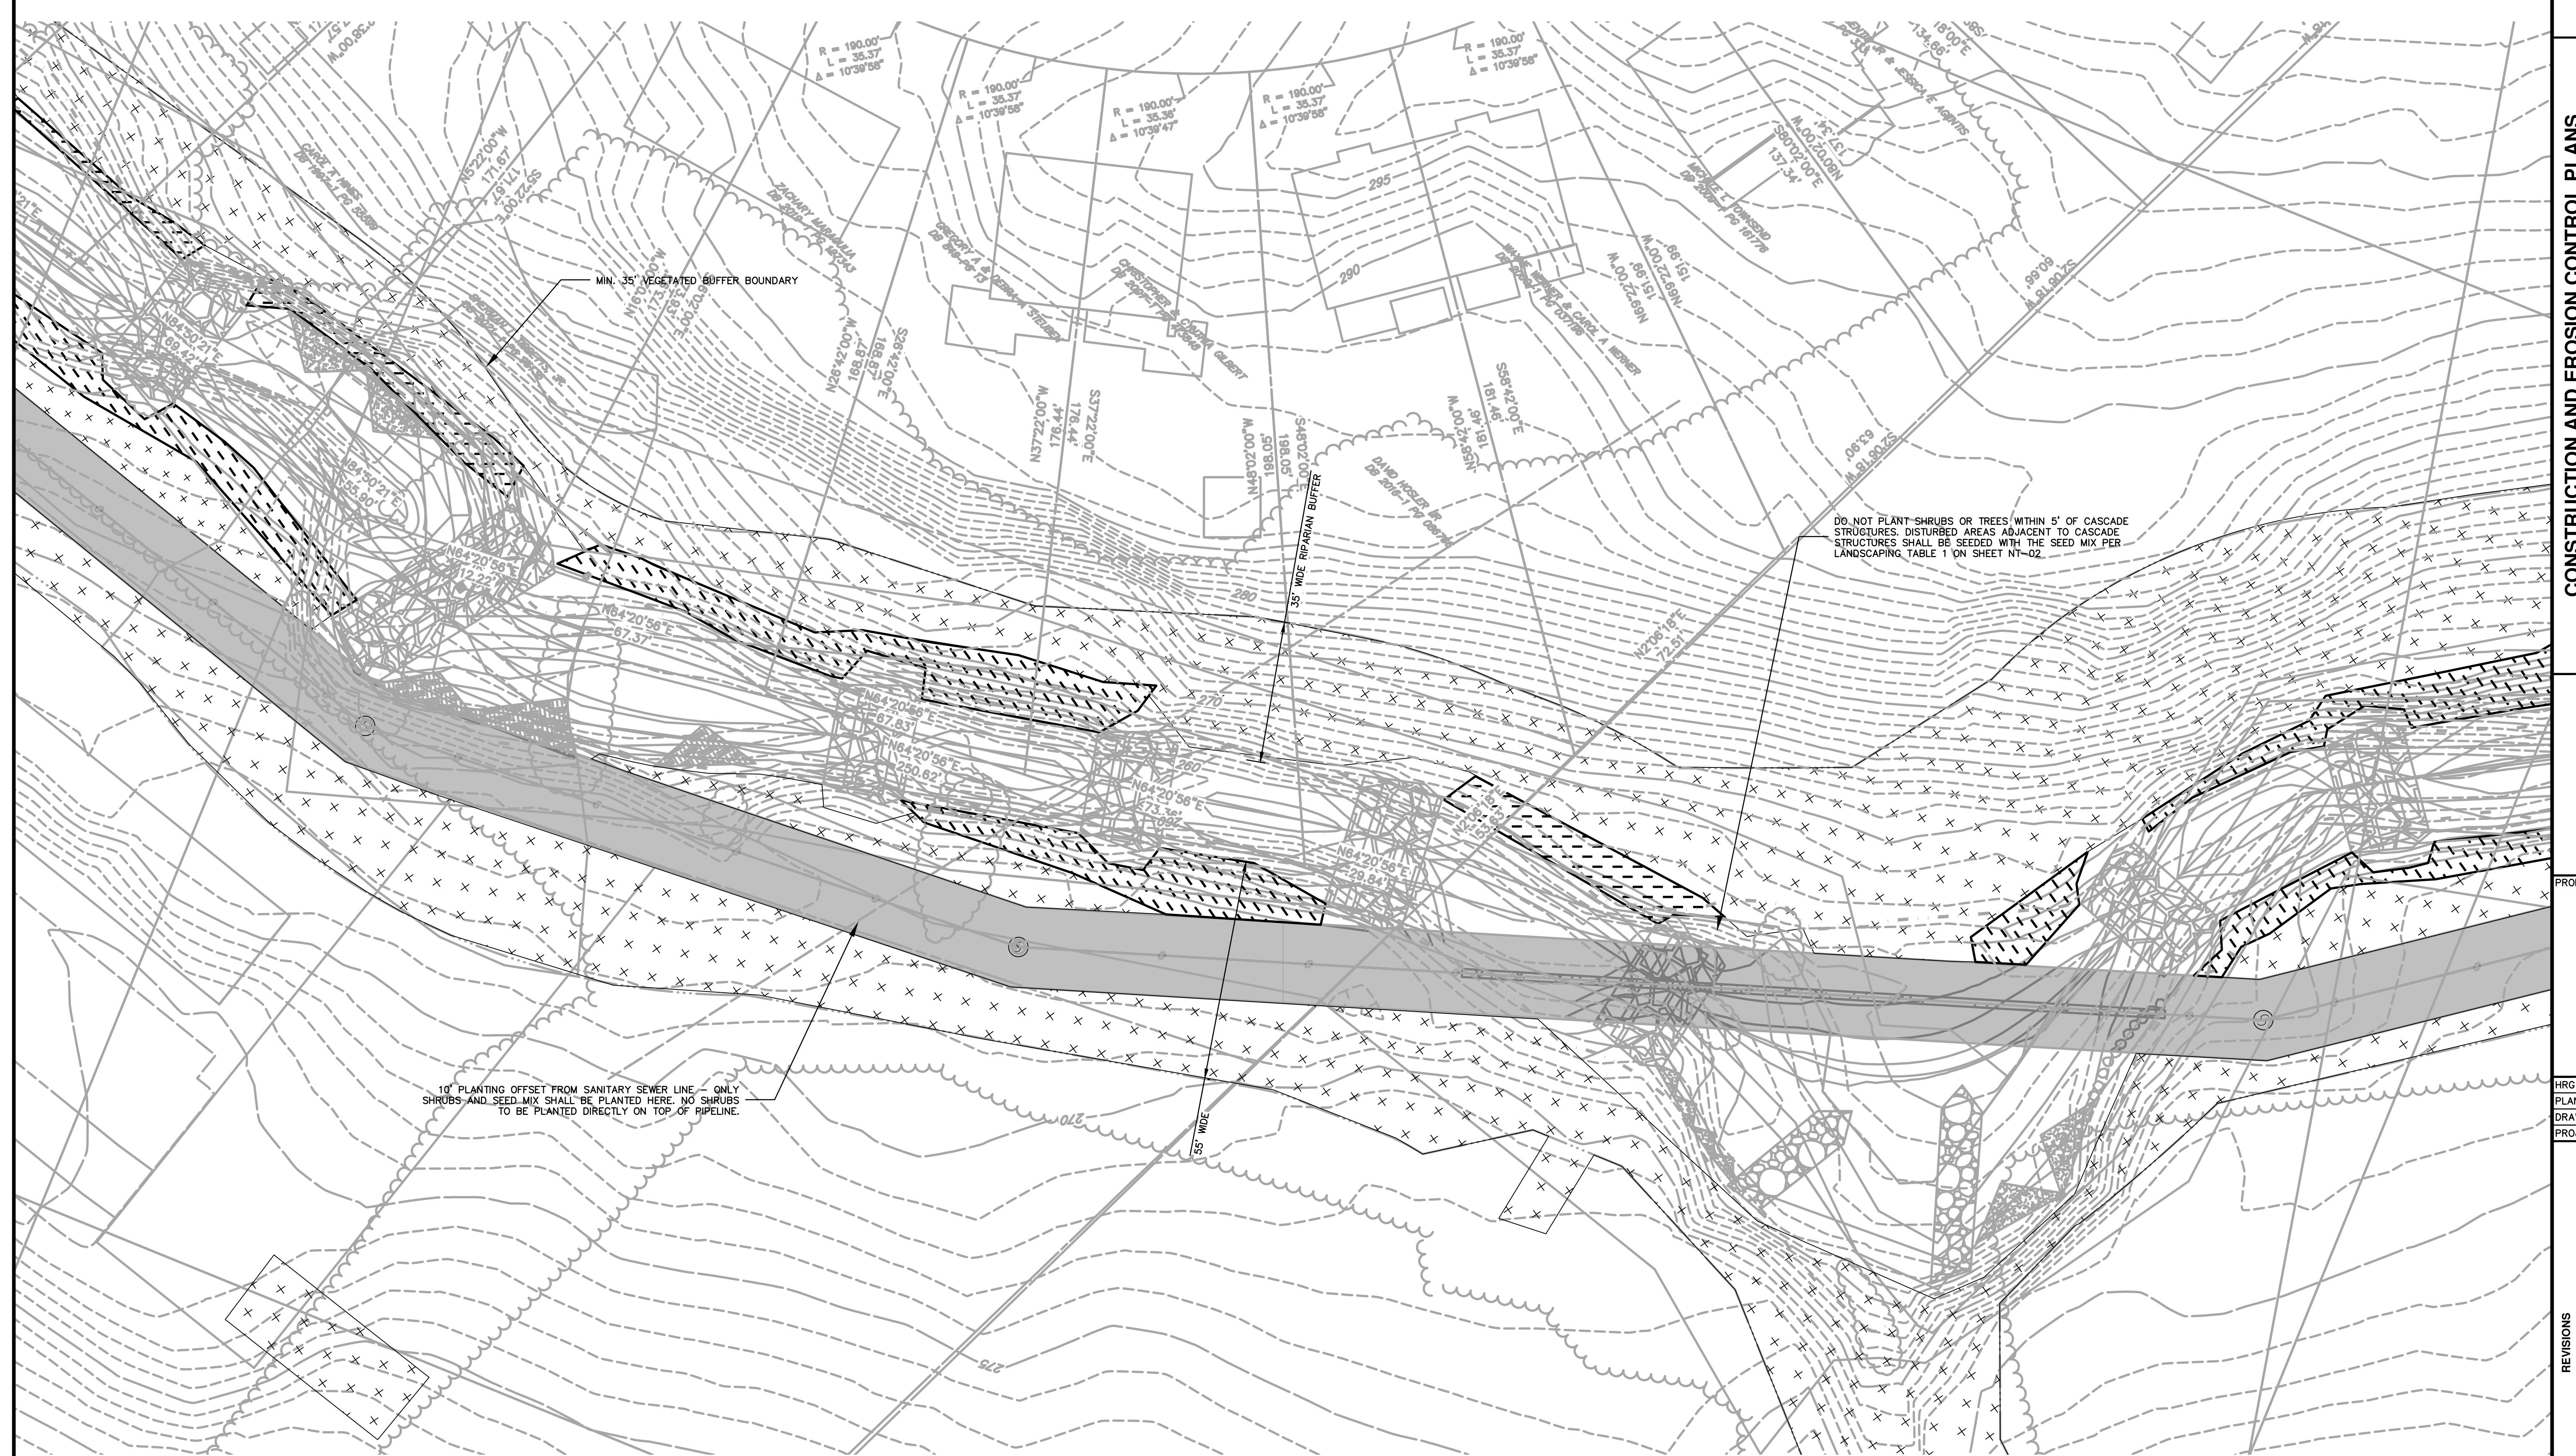

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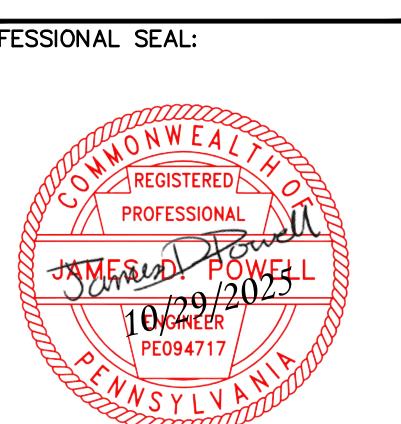
- 20' SANITARY SEWER LINE OFFSET
- PROPOSED HIGH-DENSITY DISTURBED PLANTING AREA - SEE LANDSCAPING TABLE 1
- PROPOSED LOW-DENSITY UPLAND RIPARIAN PLANTING AREA - SEE LANDSCAPING TABLE 2
- VEGETATED BUFFER BOUNDARY - MINIMUM 35' EACH BANK

NOTES

1. FINAL PLANTING AREA LAYOUT TO BE COORDINATED IN THE FIELD WITH HRG ENGINEER AS A CRITICAL INSPECTION STAGE.
2. SEE SHEET NT-02 FOR PLANT SCHEDULE.
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GRAPHIC SCALE
20' 10' 0' 20'
SCALE: 1" = 20'

FILE NAME: F:\D\DRAWINGS\HRG\SCULAC\SCULAC.dwg SHEET: LS-02 LAST SAVED: 03/29/2025 11:15 AM BY PC01



HRG PROJECT NUMBER: R009170.0431
PLAN DATE: FEBRUARY 2025
DRAWING SCALE: AS SHOWN
PROJ. MANAGER: MATTHEW VANASKE


REVISIONS	DESCRIPTION
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LANDSCAPING
PLAN


FILE NAME: R009170.0431-SCULAC-04.dwg | LAST UPDATED: 10/29/2025 11:58 AM BY POWELL

SHEET: LS-04

35

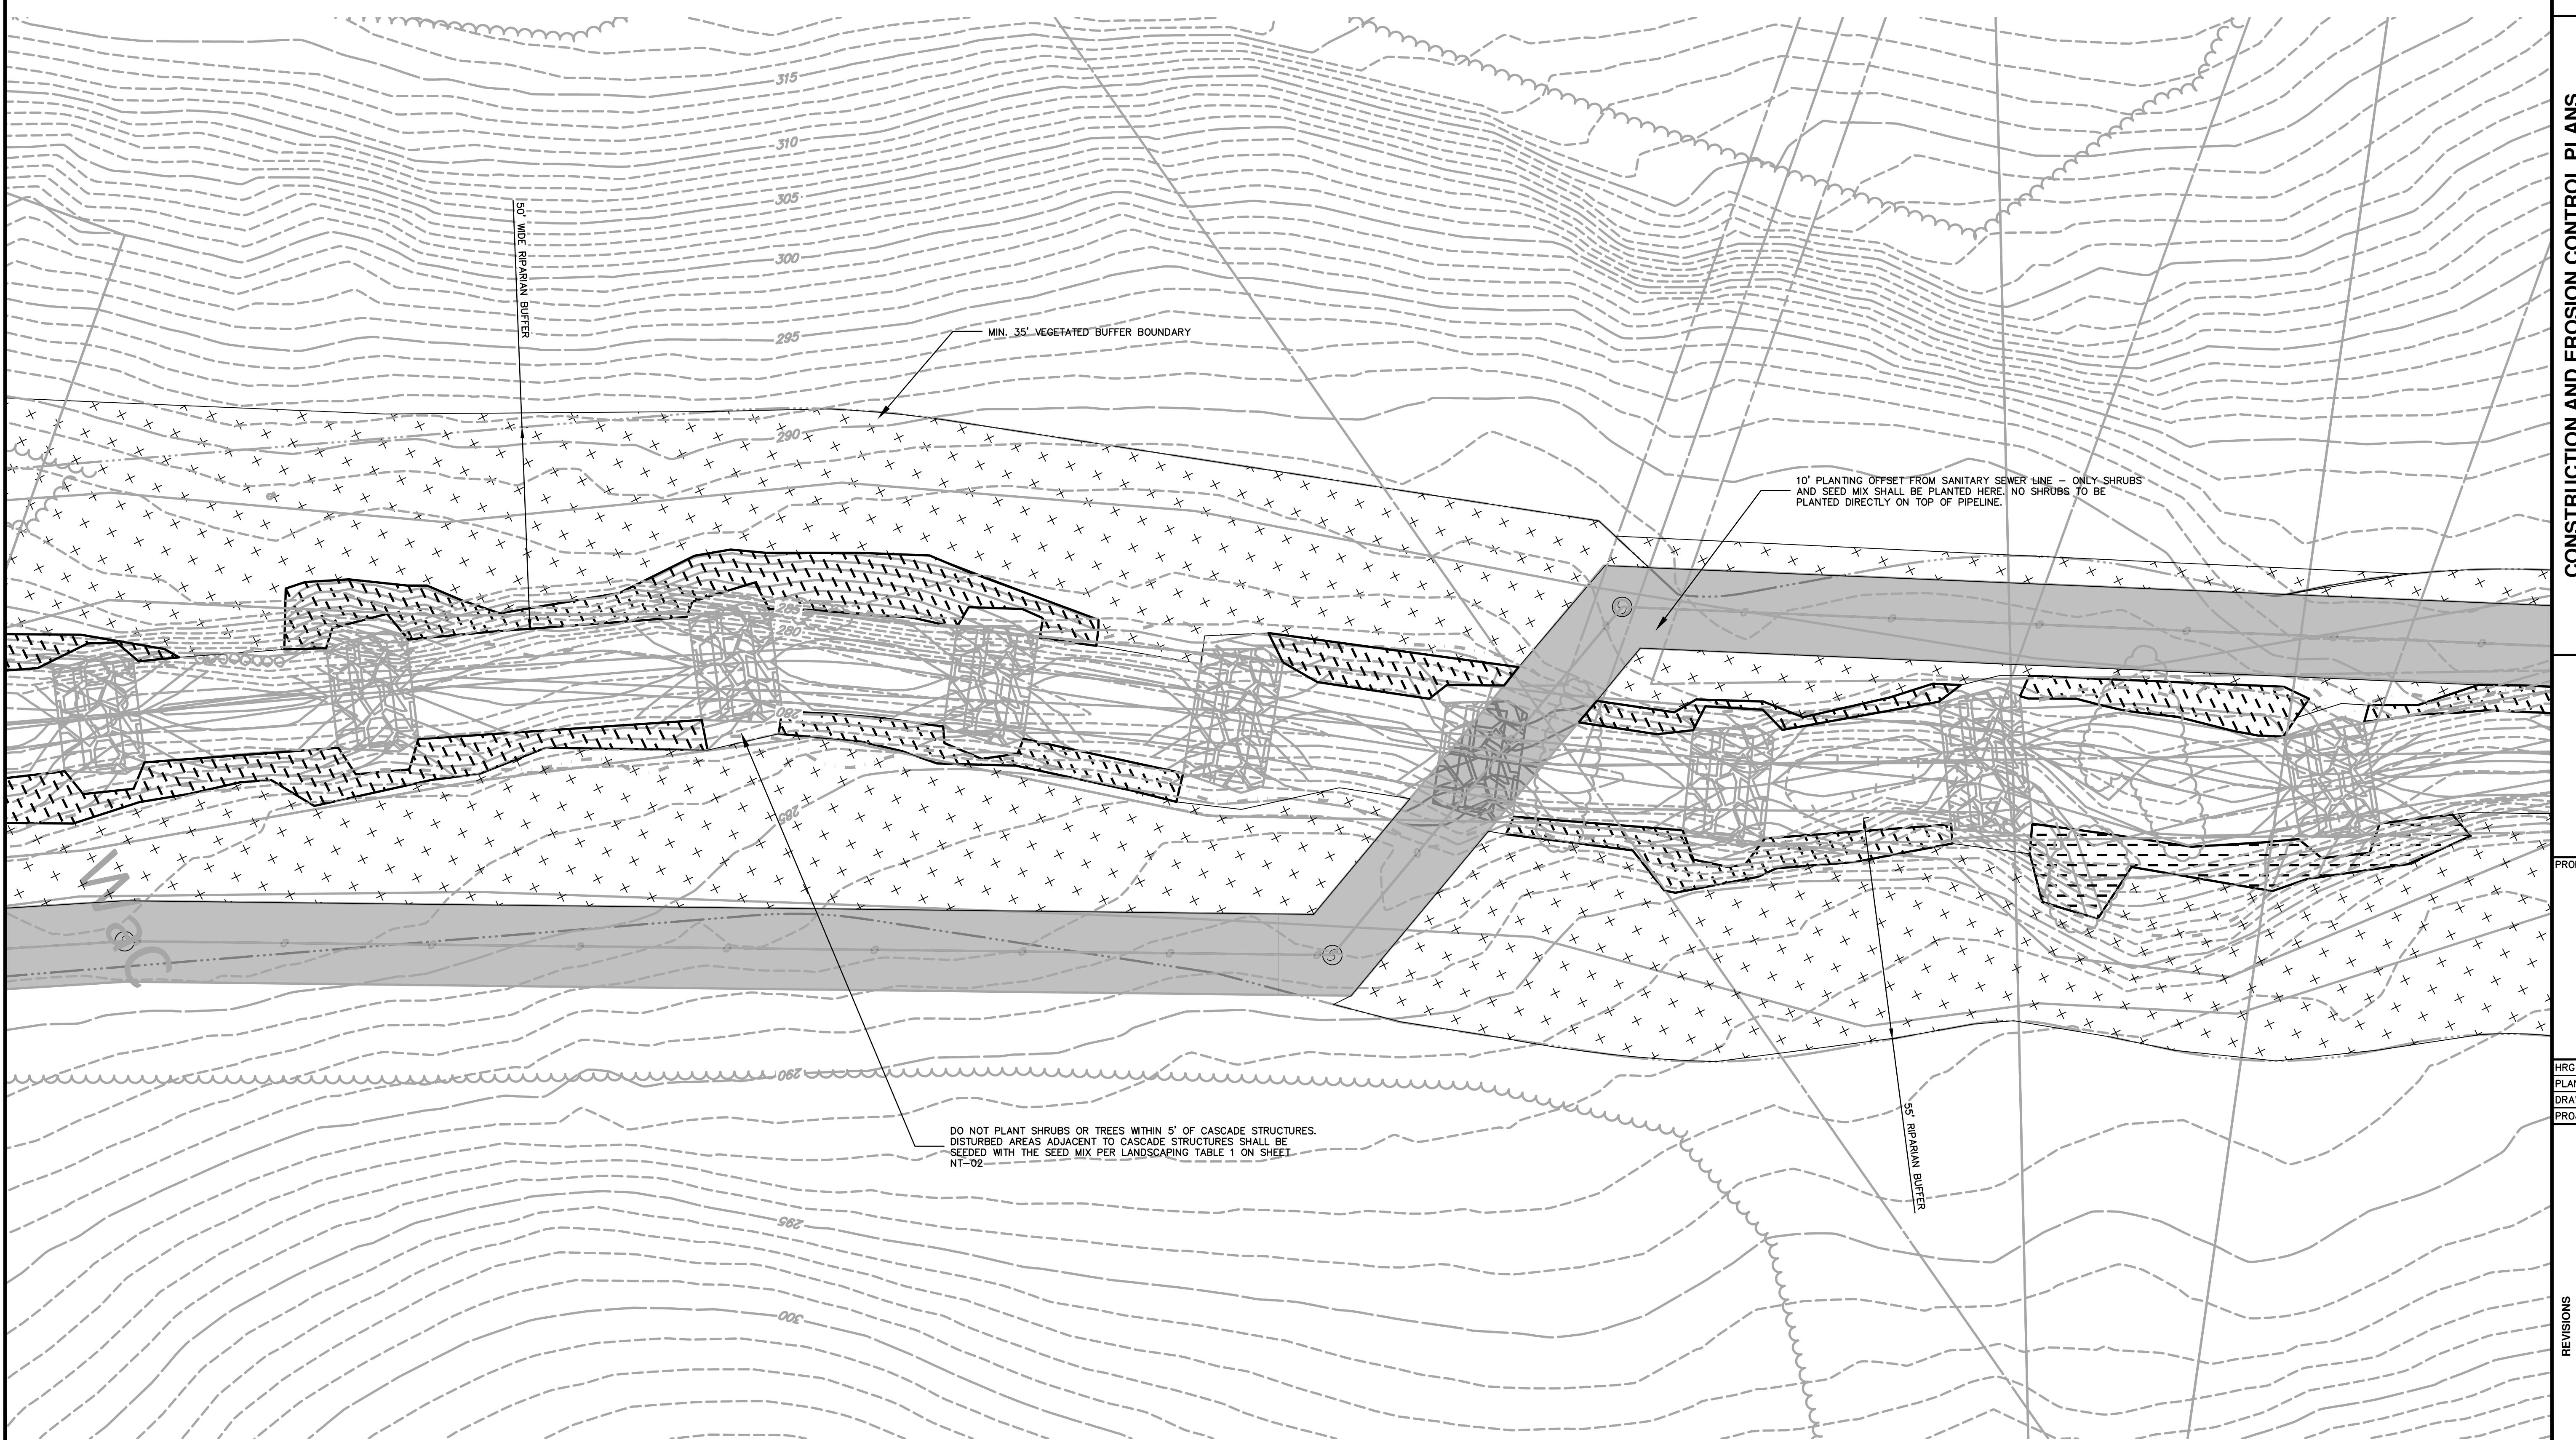

LEGEND

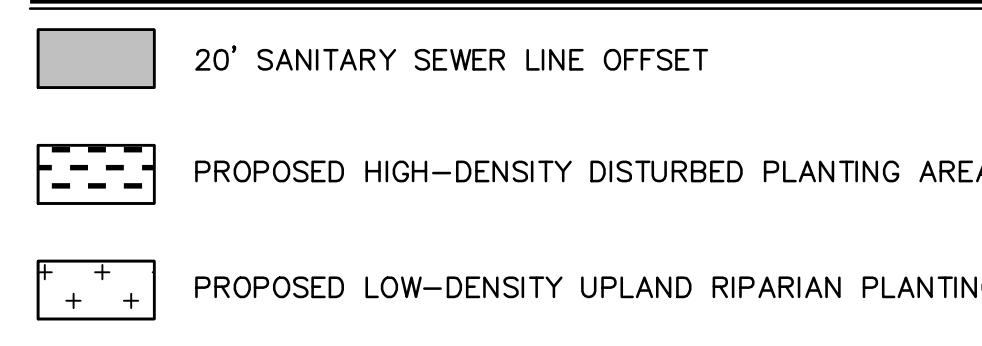

NOTES

- FINAL PLANTING AREA LAYOUT TO BE COORDINATED IN THE FIELD WITH HRG ENGINEER AS A CRITICAL INSPECTION STAGE.
- SEE SHEET NT-02 FOR PLANT SCHEDULE.
- NO PLANT SUBSTITUTIONS WITHOUT PRIOR APPROVAL OF LANDSCAPE ARCHITECT.
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GRAPHIC SCALE
20' 10' 0' 20'
SCALE: 1" = 20'

SHEET: LS-04

SUBMITTALS

1. PRODUCT DATA: SUBMIT LIST OF PLANT MATERIAL SOURCES, DATA FOR SOIL AMENDMENTS AND OTHER ACCESSORIES.
2. PROVIDE DATA SUBMIT DATA FOR SEED MIX, MULCH, AND OTHER ACCESSORIES.
3. MANUFACTURER'S CERTIFICATE: CERTIFY PRODUCTS MEET OR EXCEED SPECIFIED REQUIREMENTS.
4. QUALITY ASSURANCE.
5. PROVIDE SEED MIXTURE IN CONTAINERS SHOWING PERCENTAGE OF SEED MIX, GERMINATION PERCENTAGE, INERT MATTER PERCENTAGE, WEED PERCENTAGE, YEAR OF PRODUCTION, NET WEIGHT, DATE OF PACKAGING, AND LOCATION OF PACKAGING.
6. PROVIDE TREE SEEDLINGS THAT ARE STRAIGHT, STURDY AND OF REGULAR SHAPE, FREE OF WOUNDS, DECAY, FUNGUS, INSECTS, BACTERIA, AND OTHER DISEASES.
7. SOURCE QUALITY CONTROL.
8. TEST AND ANALYZE IMPORTED OR EXISTING TOPSOIL.
9. ANALYZE NUTRIENT PERCENTAGE OF NITROGEN, PHOSPHOROUS, POTASH, SOLUBLE SALT AND ORGANIC MATTER, AND PH VALUE.
10. PROVIDE RECOMMENDATION FOR SOIL AMENDMENT APPLICATION RATES FOR SPECIFIED PLANTING AS RESULT OF TESTING.
11. TESTING IS NOT REQUIRED WHEN RECENT TESTS ARE AVAILABLE FOR IMPORTED OR EXISTING TOPSOIL. SUBMIT THESE TEST RESULTS TO TESTING LABORATORY. INDICATE, BY TEST RESULTS, INFORMATION NECESSARY TO DETERMINE SUITABILITY.

PRODUCTS

1. TREE SEEDLINGS
 - a. SPECIES: ACCORDING TO STANDARDIZED PLANT NAMES, OFFICIAL CODE OF AMERICAN JOINT COMMITTEE ON HORTICULTURE NOMENCLATURE.
 - b. SPECIES AND SIZES IDENTIFIABLE IN PLANT SCHEDULE, GROWN IN CLIMATIC CONDITIONS SIMILAR TO THOSE IN LOCALITY OF THE WORK.
 - c. IDENTIFICATION LABEL: INDIVIDUAL PLANTS OR EACH BUNDLE OF PLANTS WHEN TIED IN BUNDLES.
2. PLANTS: NO. 1 GRADE CONFORMING TO AMERICAN STANDARD FOR NURSERY STOCK™, AMERICAN ASSOCIATION OF NURSERYMEN (AAN): WELL-BRANCHED, VIGOROUS AND BALANCED ROOT AND TOP GROWTH; FREE FROM DISEASE, INJURIOUS INSECTS, MECHANICAL WOUNDS, BROKEN BRANCHES, DECAY AND OTHER DEFECTS.

GENERAL PRODUCT DELIVERY, STORAGE AND HANDLING GUIDELINES

1. TRANSPORT AND HANDLE PRODUCTS ACCORDING TO MANUFACTURER'S INSTRUCTIONS.
2. DELIVER PRODUCTS IN MANUFACTURER'S ORIGINAL SEALED CONTAINER OR PACKAGING, COMPLETE WITH LABELS/INSTRUCTIONS FOR STORING, HANDLING, UNPACKING, PROTECTING, AND INSTALLING.
3. PROMPTLY INSPECT SHIPMENTS TO ENSURE PRODUCTS COMPLY WITH REQUIREMENTS, QUANTITIES ARE CORRECT, AND PRODUCTS ARE UNDAMAGED.
4. DELIVER FERTILIZER IN WATERPROOF BAGS SHOWING WEIGHT, CHEMICAL ANALYSIS, AND NAME OF MANUFACTURER.
5. STORE AND PROTECT PRODUCTS ACCORDING TO MANUFACTURER'S INSTRUCTIONS.
6. STORE PRODUCTS WITH SEALS AND LABELS INTACT AND LEGIBLE.
7. STORE SENSITIVE PRODUCTS IN WEATHERTIGHT, CLIMATE-CONTROLLED ENCLOSURES IN AN ENVIRONMENT SUITABLE TO PRODUCT.
8. PROTECT AND MAINTAIN PLANT LIFE UNTIL PLANTED.
9. DELIVER PLANT LIFE MATERIALS IMMEDIATELY PRIOR TO PLACEMENT. KEEP PLANTS MOIST.
10. PLANT MATERIAL DAMAGED AS A RESULT OF DELIVERY, STORAGE OR HANDLING WILL BE REJECTED.

CONTAINERIZED SEEDLING TRANSPORT, STORAGE AND HANDLING GUIDELINES

TRANSPORT:

1. KEEP SEEDLINGS SHADED AND COVERED DURING TRANSPORT. COVER WITH A TARP OR HARD-SHELL COVER WHILE IN TRANSIT, IF NOT INSIDE A CLOSED VEHICLE.

STORAGE:

1. DO NOT EXPOSE SEEDLINGS TO EXTREME TEMPERATURES, WIND, OR CONTAMINANTS (FUEL OR HERBICIDES).
2. KEEP SEEDLINGS MOIST.
3. KEEP SEEDLINGS SHADED AND COVERED.
4. STORE SEEDLINGS AND THEIR CONTAINERS OUT OF DIRECT SUNLIGHT.
5. ALLOW SPACE FOR AIR CIRCULATION BETWEEN SEEDLING BOXES/BAGS.
6. DO NOT EXPOSE SEEDLING ROOTS TO EXCESSIVE DRYING CONDITIONS.
7. DO NOT ALLOW SEEDLINGS TO FREEZE. DO NOT PLANT SEEDLINGS IF THEY ARE FROZEN FOR MORE THAN 2 DAYS.
8. SEEDLINGS FOUR WEEKS OR OLDER SHOULD BE CAREFULLY CHECKED FOR MILDEW, MOLD OR DECAY.
9. DON'T STACK SEEDLINGS MORE THAN 2 BOXES/BAGS DEEP WITHOUT SPACERS TO PROVIDE SUPPORT.

HANDLING:

1. PLANT SEEDLINGS WITHIN TWO WEEKS OF DELIVERY TO PROJECT SITE IF POSSIBLE.
2. REMOVE ONLY MINIMUM NUMBER OF SEEDLINGS THAT CAN BE PLANTED QUICKLY AND CORRECTLY TO AVOID EXPOSING ROOTS TO WIND AND SUN.
3. CLOSE BOXES OR BAGS AND PLACE OUT OF DIRECT SUNLIGHT. DO NOT LEAVE SEEDLING BAGS OR BOXES OPEN WHILE PLANTING.
4. DO NOT DUMP THE CONTENTS OF SEEDLING BAGS OR BOXES ON THE GROUND TO SORT BEFORE PLANTING.
5. DO NOT PRUNE ROOTS UNLESS THE LATERALS ARE 5' OR LONGER. PRUNE THE LATERALS WITH A SHARP MACHETE TO 3 TO 4 INCHES IN LENGTH.
6. DO NOT BEAT SEEDLINGS AGAINST OBJECTS TO REMOVE CLAY SLURRY.
7. DISCARD CULL SEEDLINGS SUCH AS THOSE WITH A STEM DIAMETER SMALLER THAN A KITCHEN MATCH, DRY SEEDLINGS, OR SEEDLINGS WITHOUT A GOOD ROOT SYSTEM.

SOIL AMENDMENTS AND ACCESSORIES

1. SOIL AMENDMENT MATERIALS
 - a. WHEN SOIL TESTS INDICATE SOIL AMENDMENT, APPLY SOIL CONDITIONERS OR FERTILIZERS TO AMEND SOIL TO SPECIFIED CONDITIONS.
 - b. PEAT MOSS: SHREDDED, LOOSE, SPAGHUM MOSS; FREE OF LUMPS, ROOTS, INORGANIC MATERIALS, OR ACIDIC MATERIALS; MINIMUM OF 85 PERCENT ORGANIC MATTER, MEASURED AS DRY, EVEN DRY WEIGHT, PH RANGE OF 4 TO 5; MOISTURE CONTENT OF 30 PERCENT.
 - c. BONE MEAL: RAW, FINELY GROUND, COMMERCIAL GRADE, MINIMUM OF 3 PERCENT NITROGEN AND 20 PERCENT PHOSPHOROUS.
 - d. LIME: GROUND LIMESTONE, DOLOMITE TYPE, MINIMUM 95 PERCENT CARBONATES.
2. ACCESSORIES
 - a. SEEDING AREA MULCHING MATERIAL: OAT OR WHEAT STRAW, FREE FROM WEEDS, FOREIGN MATTER DEDIMENTAL TO PLANT LIFE, AND DRY. HAY OR CHOPPED CORNSTALKS ARE NOT ACCEPTABLE.
 - b. FERTILIZER: COMMERCIAL GRADE; RECOMMENDED FOR GRASS, OF PROPORTION NECESSARY TO CORRECT NUTRIENT DEFICIENCIES OF TOPSOIL, AS INDICATED IN SOIL ANALYSIS TEST RESULTS.
 - c. LIME: ASTM C602, CLASS T AGRICULTURAL LIMESTONE CONTAINING A MINIMUM 80 PERCENT CALCIUM CARBONATE EQUIVALENT.
 - d. WOOD STAKES: WHITE OAK LUMBER, POINTED END.
 - e. PLANT PROTECTORS: TUBEX COMBITE, 5' TREE SHELTER (OR APPROVED EQUAL); TUBEX BIRD NETTING (OR APPROVED EQUAL).

SEEDING INSTRUCTIONS

TIME OF PLANTING

1. FALL (AUGUST 20 TO OCTOBER 20). FALL IS THE BEST TIME TO PLANT. COOL TEMPS AND GENTLE RAINS PROMOTE GERMINATION OF COOL SEASON FESCUES. WEED GERMINATION IS LOWER IN FALL THAN IN SPRING. FALL-SEEDED LAWNS TYPICALLY HAVE FAR FEWER WEEDS THAN SPRING-SEEDED LAWNS.
2. SPRING (MARCH 15 TO MAY 15). SPRING PLANTING IS A GOOD SECOND OPTION. SPRING SEEDED OFTEN REQUIRE WATERING MORE FREQUENTLY. SUMMER DROUGHT CAN BE A THREAT, AND WEEDS ARE TYPICALLY MORE COMPETITIVE. SEEDED NO NOW BETWEEN MAY 16TH AND AUGUST 19TH IS NOT RECOMMENDED.
3. INSTALL PER MANUFACTURER'S INSTRUCTIONS. DRILLING INTO EXISTING CONDITIONS PREFERRED.
4. DO NOT SEED AREAS MORE THAN WHICH CAN BE MULCHED ON SAME DAY.
5. DO NOT SOW IMMEDIATELY FOLLOWING RAIN, WHEN GROUND IS TOO DRY, OR WHEN WINDS ARE OVER 12 MPH.

WARRANTY

1. WARRANT PLANTS FOR THE FOLLOWING DURATION AFTER DATE OF SUBSTANTIAL COMPLETION, AGAINST DEFECTS INCLUDING DEATH AND UNSATISFACTORY GROWTH, BUT EXCEPTING DEFECTS RESULTING FROM NEGLECT BY OWNER, ABUSE OR DAMAGE BY OTHERS, OR UNUSUAL PHENOMENA OR INCIDENTS BEYOND CONTRACTOR'S CONTROL:
 - a. TREES AND SEEDED AREAS: TWO YEARS
2. REMOVE AND REPLACE TREES OR OTHER PLANTS FOUND TO BE DEAD OR IN UNHEALTHY CONDITION DURING WARRANTY PERIOD. MAKE REPLACEMENTS DURING GROWTH SEASON FOLLOWING END OF WARRANTY PERIOD. REPLACE TREES WHICH ARE MORE THAN 25% DEAD AT END OF WARRANTY PERIOD. UNLESS, IN THE OPINION OF DESIGN PROFESSIONAL, IT IS ADVISABLE TO EXTEND WARRANTY PERIOD FOR A FULL GROWING SEASON.

FINAL ACCEPTANCE

FINAL ACCEPTANCE OF THE LANDSCAPING PLAN SHALL INCLUDE ESTABLISHMENT OF SEEDED AREAS TO A MINIMUM UNIFORM 70% COVERAGE, AND ESTABLISHMENT OF A MINIMUM SURVIVAL RATE OF 50% FOR TREE SEEDED. CONSERVATION LANDSCAPING TO BE COMPLETED PER THE PLANT AND SEEDED SCHEDULE AND PLANTING DETAILS.

SITE PREPARATION NOTES

1. WARRANT PLANTS FOR THE FOLLOWING DURATION AFTER DATE OF SUBSTANTIAL COMPLETION, AGAINST DEFECTS INCLUDING DEATH AND UNSATISFACTORY GROWTH, BUT EXCEPTING DEFECTS RESULTING FROM NEGLECT BY OWNER, ABUSE OR DAMAGE BY OTHERS, OR UNUSUAL PHENOMENA OR INCIDENTS BEYOND CONTRACTOR'S CONTROL:
 - a. TREES AND SEEDED AREAS: TWO YEARS
2. REMOVE AND REPLACE TREES OR OTHER PLANTS FOUND TO BE DEAD OR IN UNHEALTHY CONDITION DURING WARRANTY PERIOD. MAKE REPLACEMENTS DURING GROWTH SEASON FOLLOWING END OF WARRANTY PERIOD. REPLACE TREES WHICH ARE MORE THAN 25% DEAD AT END OF WARRANTY PERIOD. UNLESS, IN THE OPINION OF DESIGN PROFESSIONAL, IT IS ADVISABLE TO EXTEND WARRANTY PERIOD FOR A FULL GROWING SEASON.

POST-PLANTING OPERATION AND MAINTENANCE PROCEDURES

WATERING – SEEDED AREAS

1. MAINTAIN SEEDED AREAS IMMEDIATELY AFTER PLACEMENT UNTIL GRASS IS WELL ESTABLISHED AND EXHIBITS VIGOROUS GROWING CONDITION.
2. SEEDS SHOULD BE WATERED EVERY OTHER MORNING FOR 15 TO 30 MINUTES DURING THE FIRST FOUR TO SIX WEEKS AFTER PLANTING, ESPECIALLY IF PLANTING ON DRY SOILS OR IN LATE SPRING WHEN TEMPERATURES ARE HIGHER.
3. ONCE ESTABLISHED, SEEDED AREAS SHOULD BE WATERED ONLY DURING DRY PERIODS.
 - A. OCCASIONAL THOROUGH SOAKINGS ARE BETTER THAN FREQUENT, LIGHT SPRINKLINGS.
 - B. DURING PERIODS OF HOT, DRY WEATHER, SEEDED AREAS SHOULD RECEIVE AT LEAST 2 INCHES OF WATER PER WEEK, APPLIED AS 1 OR 2 DEEP SOAKINGS.

WATERING – SEEDED

1. MAINTAIN TREE SEEDED IMMEDIATELY AFTER PLACEMENT, UNTIL PLANTS ARE WELL ESTABLISHED AND EXHIBIT VIGOROUS GROWING CONDITION.
2. WATERING NEEDS CAN VARY DEPENDING ON THE TIME OF YEAR AND SITE CONDITIONS.
3. APPLY SUPPLEMENTAL WATERING DURING FIRST PLANTING SEASON DURING DRY PERIODS (LESS THAN 1 INCH OF RAIN PER WEEK) TO IMPROVE SURVIVAL.

FERTILIZING AND WEED CONTROL

1. FERTILIZING IS NOT RECOMMENDED FOR SEEDED AREAS, AND SHOULD BE APPLIED SPARINGLY, IF AT ALL, IN EARLY SPRING OR LATE SUMMER.
 - A. USE A SLOW-RELEASE, BALANCED FERTILIZER WITH EQUAL PORTIONS NITROGEN, PHOSPHOROUS, AND POTASSIUM.
 - B. DO NOT USE HIGH LEVELS OF NITROGEN FERTILIZER ON SEEDED AREAS.
2. FERTILIZING IS NOT RECOMMENDED FOR SEEDED.
3. PROBLEM WEEDS SHOULD BE HAND PULLED OR SPOT SPRAYED WITH AN APPROVED HERBICIDE SUCH AS ROUNDUP, RODEO, OR GARLON 3A.

REGULAR INSPECTION OF PROTECTIVE TREE SHELTERS

1. AT MINIMUM, AN ANNUAL INSPECTION OF EACH PLANTING SITE IS REQUIRED. IDEALLY, SITES SHOULD BE INSPECTED ON A SEASONAL BASIS (EVERY THREE MONTHS) AS WELL AS AFTER ANY SIGNIFICANT RAINFALL OR STORM EVENT.
2. SITE INSPECTIONS SHOULD INCLUDE: EVALUATING FOR COMPETING GRASSES AND NOXIOUS WEEDS; CHECKING TREE SHELTERS AND BIRD NETTING; ASSESSING FOR VOLE OR DEER DAMAGE; RELOCATING SHELTERS AND EVALUATING SURVORSHIP. PROBLEMS SHOULD BE CORRECTED AS THEY ARE DISCOVERED. REPLANT AS NECESSARY IN THE APPROPRIATE SEASONS.
3. PROTECTIVE TREE SHELTERS ARE DESIGNED TO REMAIN IN PLACE FOR A MINIMUM OF FIVE (5) YEARS, OR UNTIL THE BASE OF TREE TRUNK REACHES 3-3.5" CAL. OR TREES BEGIN TO BREAK OUT OF THEIR TUBES NATURALLY.
4. INSPECT PROTECTIVE TREE SHELTERS MONTHLY DURING EACH GROWING SEASON (MARCH – NOVEMBER).
5. REPLACE DAMAGED OR BENT SHELTERS, STAKES, AND TIES, AND ENSURE THAT TUBE BASES ARE FIRMLY TOUCHING THE SOIL AROUND SEEDED.
6. IF INVASIVE PLANT SPECIES ARE FOUND GROWING INSIDE A SHELTER, GENTLY LOOSEN TIES, LEFT THE SHELTER SEVERAL INCHES OFF THE GROUND, AND HAND PULL WEEDS. REPLACE THE SHELTER AROUND THE BASE OF THE SEEDED AND RETIGHTEN THE TIES. DISCARD WEEDS OFF-SITE.
7. REMOVE BIRD NETTING FROM TOPS OF SHELTERS WHEN FOLIAGE IS WITHIN 2-3' OF THE TOP OF THE TUBE.

SANITARY PROTECTION NOTES

1. SEEDED SHALL NOT BE PLANTED WITHIN 10' OFFSET OF EXISTING SANITARY SEWER LINE AND MANHOLES. SHRUBS AND GRASSES SHALL ONLY BE PLANTED WITHIN 10' OF PIPELINE AND MANHOLES.

LANDSCAPE TABLE 1: HIGH-DENSITY DISTURBED AREA PLANTING SCHEDULE
NO SUBSTITUTIONS WITHOUT PRIOR APPROVAL OF LANDSCAPE DESIGNER

SHRUB SEELED PLANTINGS - PLANT AT A DENSITY OF 200 SHRUBS/ACRE						
QTY	BOTANICAL NAME	COMMON NAME	SPACING	MIN. SIZE	CONTAINER	COMMENTS
25	CORNUS SERICEA	REDOSIER DOGWOOD	15'	3'	LS	
25	CORNUS AMOMUM	SILKY DOGWOOD	15'	3'	LS	
25	SALIX DISCOLOR	Pussy Willow	15'	3'	LS	
26	SAMBUCUS L.	ELDERBERRY	15'	2'	2-GAL	
26	PHYSOCARPUS RAF.	NINEBARK	15'	2'	2-GAL	
27	AMELANCHIER	SERVICEBERRY	15'	2'	2-GAL	

TREE SEEDED PLANTINGS - PLANT AT A DENSITY OF 200 TREES/ACRE						
QTY	BOTANICAL NAME	COMMON NAME	SPACING	MIN. SIZE	CONTAINER	COMMENTS
51	PLATANUS L.	SYCAMORE	15'	N/A	1" CAL	Provide Tree Shelter w/ Stake
51	FRAXINUS AMERICANA	WHITE ASH	15'	N/A	1" CAL	Provide Tree Shelter w/ Stake
52	CERCIS L.	REDBUD	15'	N/A	1" CAL	Provide Tree Shelter w/ Stake

HERBACEOUS PLANTINGS - PLANT AT A DENSITY OF 200 PLANTS/ACRE						
QTY	BOTANICAL NAME	COMMON NAME	SPACING	MIN. SIZE	CONTAINER	COMMENTS
154	POLYPODIOPSIDA	ASSORTED FERNS	14'	N/A	DP-50	

SEED MIX

Seed Mix #	SF	Seed Mix Name	Seeding Rate	Seed Source	Comments
ERNMX-111				Ernst Conservation Seeds (or approved equal)	Contractor to confirm all Seed Mix quantity prior to ordering and installing
ERNMX-181				Ernst Conservation Seeds (or approved equal)	Contractor to confirm all Seed Mix quantity prior to ordering and installing

LANDSCAPE TABLE 2 : LOW-DENSITY UPLAND RIPARIAN BUFFER PLANTING SCHEDULE NO SUBSTITUTIONS WITHOUT PRIOR APPROVAL OF LANDSCAPE DESIGNER

SHRUB SEEDED PLANTINGS - PLANT AT A DENSITY OF 150 SHRUBS/ACRE						
QTY						
<th